SPECIAL EXCEPTION PLAN COURTHOUSE PLAZA CITY OF FAIRFAX, VIRGINIA

REVISION SPECIAL EXCEPTION PLAN SUBMISSION #1 SPECIAL EXCEPTION PLAN SUBMISSION #2 SPECIAL EXCEPTION PLAN SUBMISSION #3 SPECIAL EXCEPTION PLAN SUBMISSION #4 SPECIAL EXCEPTION PLAN SUBMISSION #4.1 SPECIAL EXCEPTION PLAN SUBMISSION #5

PROJECT TEAM:

OWNER / APPLICANT

COMBINED COURTHOUSE, LLC C/O COMBINED PROPERTIES. INC.

> 7315 WISCONSIN AVENUE SUITE 1000W

BETHESDA, MD 20814

ATTORNEY

CURATA PARTNERS PLLC 4140 PLEASANT VALLEY ROAD

> SUITE 101 CHANTILLY, VA 20151

> > ARCHITECT

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SUITE 300

WASHINGTON, DC 20002

CIVIL ENGINEER

christopher consultants now IMEG

4035 RIDGE TOP ROAD SUITE 601

FAIRFAX, VA 22031

TRANSPORTATION ENGINEER

GOROVE SLADE ASSOCIATES INC.

4114 LEGATO ROAD

SUITE 650

FAIRFAX, VA 22033


LANDSCAPE ARCHITECT

LANDDESIGN , INC.

200 SOUTH PEYTON STREET

ALEXANDRIA, VA 22314

RECEIVED Jun **23** 2025 Community Dev & Planning

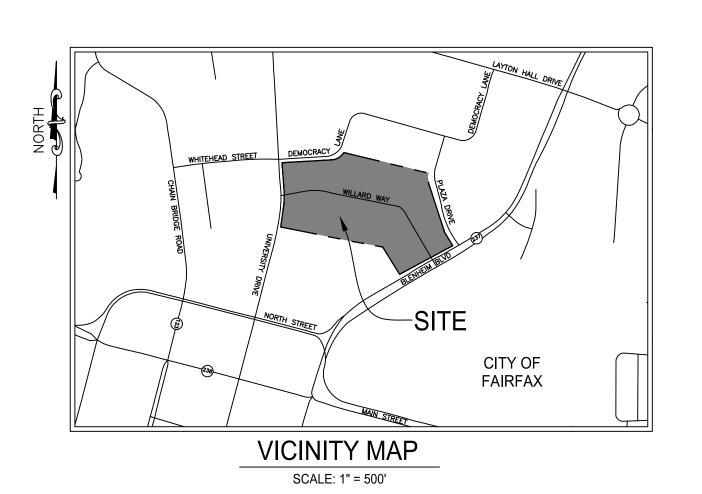

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6A	SITE PLAN
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9	BMP NARRATIVE & PRE DEVELOPMENT BMP MAP
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SIGHT DISTANCE SIGHT DISTANCE SIGHT DISTANCE SIGHT DISTANCE SIGHT DISTANCE TURNING MOVEMENTS TURNING MOVEMENTS FIRE SERVICE PLAN PEDESTRIAN CONNECTIVITY EXHIBIT VEHICULAR CONNECTIVITY EXHIBIT

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PROJECT No.: 16148.001.00 **DRAWING No.: 109632** DATE: 03/21/2023 SCALE: SEE SHEET DESIGN: EG DRAWN: NL

CHECKED: EG SHEET TITLE:

COVER SHEET

SHEET No.

NOTE: SEE CERTIFIED PLAT FOR MORE TOTAL AREA (ACRES): 2. THE PROPERTY SHOWN HEREON IS IDENTIFIED ON THE CITY OF FAIRFAX, VIRGINIA GEOGRAPHIC INFORMATION SYSTEM AS TAX MAP #57-2-20-004D AND IS CURRENTLY ZONED CR - COMMERCIAL RETAIL. 3. THE PROPERTY SHOWN HEREON IS NOW IN THE NAME OF COMBINED COURTHOUSE, LLC. AT DEED BOOK 23548, PAGE 286, AMONG THE LAND RECORDS OF FAIRFAX COUNTY, VIRGINIA. 4. THE PHYSICAL IMPROVEMENTS AND TOPOGRAPHY SHOWN HEREON ARE BASED UPON AN AERIAL TOPOGRAPHIC SURVEY PERFORMED BY MCKENZIE SNYDER, INC, FLOWN DECEMBER 16TH, 2016 AND COMPILED JANUARY 2ND, 2018. THIS DATA HAS BEEN SUPPLEMENTED BY CONVENTIONAL METHODS BY THIS FIRM BETWEEN THE DATES OF DECEMBER 18TH, 2017 AND JANUARY 9TH, 2018 AND FURTHER UPDATED BETWEEN THE DATES OF JANUARY 25TH AND JANUARY 29TH. 2018 5. THE FOLLOWING DATUM WERE USED: A. HORIZONTAL DATUM SHOWN HEREON IS REFERENCED TO THE VIRGINIA COORDINATE SYSTEM (VCS) 1983-NORTH AS THE VERTICAL DATUM SHOWN HEREON IS REFERENCED TO THE NATIONAL GEODETIC VERTICAL DATUM OF 1929 (NGVD29) AS 5. THE PROPERTY SHOWN HEREON IS LOCATED ON THE FLOOD INSURANCE RATE MAP (FIRM), COMMUNITY PANEL NO. 5155240002D, REVISED ON JUNE 2ND, 2006. BY GRAPHICALLY DEPICTION ONLY, THE PROPERTY SHOWN HEREON IS SHOWN IN: • FLOOD ZONE "X" (OTHER AREAS), AREAS DETERMINED TO BE OUTSIDE THE 0.2% ANNUAL CHANCE FLOODPLAIN. A FIELD SURVEY WAS NOT PERFORMED TO DETERMINE THE FLOOD ZONES LISTED HEREON. AN ELEVATION CERTIFICATE MAY BE NEEDED TO VERIFY THIS DETERMINATION OR APPLY FOR A VARIANCE FROM THE FEDERAL EMERGENCY MANAGEMENT 6. NO TITLE REPORT FURNISHED. ALL UNDERLYING TITLE LINES, EASEMENTS, SERVITUDES AND OTHER MATTERS OF TITLE MAY NOT BE

CR (COMMERCIAL RETAIL)

15. ONSITE STORMWATER MANAGEMENT AND BEST MANAGEMENT PRACTICES SHALL BE PROVIDED AS REQUIRED BY CITY REGULATIONS AT THE TIME OF FINAL SITE PLAN. DETENTION TO PROVIDE THE REQUIRED STORMWATER QUANTITY CONTROLS AND ONSITE BEST MANAGEMENT PRACTICES (BMPs) TO MEET THE STORMWATER QUALITY REQUIREMENTS ARE SHOWN ON SHEET 6 - SITE PLAN. 16. ALL SIGNAGE WILL BE IN CONFORMANCE WITH SECTION 4.6 OF THE ZONING ORDINANCE UNLESS MODIFIED WITH A COMPREHENSIVE 17. TO THE BEST KNOWLEDGE OF THE ENGINEER AND APPLICANT, THIS DEVELOPMENT PLAN CONFORMS TO ALL APPLICABLE ORDINANCES, REGULATIONS AND ADOPTED STANDARDS, WITH THE FOLLOWING MODIFICATIONS, WAIVERS, AND SPECIAL USE PERMIT: SPECIAL EXCEPTION FOR SECTION 3.5.1.D.1(B) TO ALLOW MORE THAN 25% OF THE GROUND FLOOR TO BE RESIDENTIAL USES AND/OR RESIDENTIAL ACCESSORY USES. SPECIAL EXCEPTION FOR SECTION 3.6.2 TO ALLOW FOR GREATER THAN 24 DWELLING UNITS PER ACRE. SPECIAL EXCEPTION FOR SECTION 3.7.3.C.2. TO EXCEED MAXIMUM HEIGHT OF 48' IN TOD. SPECIAL EXCEPTION FOR SECTION 3.7.3.D. 10' SIDEWALK IN TOD TO ALLOW SIDEWALKS IN TOD LESS THAN 10'. A SPECIAL EXCEPTION FOR SECTION 4.4.4.A TO ALLOW SIDEWALKS ON ONLY ONE SIDE OF A STREET AT THESE WOULD BE RESPONSIBLE FOR INSTALLING THE REMAINING PORTION OF THE SOUTHERN HALF OF THE

7. THE SUBJECT PROPERTY IS CURRENTLY SERVED BY PUBLIC WATER AND PUBLIC SEWER PROVIDED BY CITY OF FAIRFAX AND FAIRFAX

8. DURING THE PROCESS OF THE PHYSICAL SURVEY NO INDICATIONS OF A CEMETERY WERE FOUND. NO FURTHER INSPECTION OF THESE

NO GEOTECHNICAL FIELD REVIEWS, RESEARCH, GOVERNMENTAL RECORD REVIEWS, OR OTHER INVESTIGATIONS HAVE BEEN MADE FOR THE PURPOSE OF LOCATING, OR DETERMINING THE EXISTENCE OF HAZARDOUS MATERIALS, OR OTHER ENVIRONMENTAL

CONCERNS ON THIS SITE. A PRELIMINARY JURISDICTIONAL DETERMINATION HAS BEEN APPROVED BY THE ARMY CORPS OF

10. THIS DEVELOPMENT PROPOSAL IS COMPATIBLE WITH THE EXISTING DEVELOPMENT IN THE VICINITY OF THIS SITE. NO ADVERSE

11. NOTWITHSTANDING THE IMPROVEMENTS AND TABULATIONS SHOWN ON THIS PLAN, THE APPLICANT RESERVES THE RIGHT TO MAKE MINOR MODIFICATIONS TO THE FINAL DESIGN, TO COMPLY WITH FINAL ENGINEERING AND NEW CRITERIA AND REGULATIONS WHICH

MODIFICATIONS ARE SUBSTANTIALLY CONSISTENT WITH THE APPROVED DEVELOPMENT PLAN AND COMMITMENTS AND SUBJECT TO

MAY BE ADOPTED BY THE CITY OF FAIRFAX SUBSEQUENT TO THE SUBMISSION OF THIS APPLICATION. PROVIDED THAT SUCH

12. THE PROPOSED BUILDING FOOTPRINT SHOWN HEREIN IS PRELIMINARY. THE PROPOSED SQUARE FOOTAGE FOR THE PROPOSED BUILDING IS APPROXIMATE ONLY AND MAY BE SUBJECT TO MINOR REVISIONS AT THE TIME OF SITE PLAN. BUT SUBSTANTIALLY

14. SITE LIGHTING WITHIN THE PROJECT SITE AREA (I.E. ALONG SIDEWALKS AND PATHWAYS) WILL BE DETERMINED DURING FINAL SITE

PLAN REVIEW AND SHALL BE IN GENERAL CONFORMANCE WITH SECTION 4.8 OF THE ZONING ORDINANCE AND SECTION 2.10 OF THE

EFFECTS TO NEIGHBORING PROPERTIES ARE ANTICIPATED WITH THIS PROJECT.

THE DETERMINATIONS OF THE DIRECTOR OF DEVELOPMENT AND PLANNING.

13. ALL EXISTING UTILITY EASEMENTS ARE SHOWN ON THE EXISTING CONDITIONS PLAN.

CONSISTENT WITH THE APPROVED SPECIAL EXCEPTION PLAN.

1. THE SUBJECT PROPERTY SHOWN HEREON IS RECORDED IN THE LAND RECORDS OF FAIRFAX CITY, VIRGINIA AS FOLLOWS:

COMBINED COURTHOUSE, LLC. 10300 WILLARD WAY

GENERAL NOTES:

ENGINEERS TO DELINEATE THE RPA.

PUBLIC FACILITIES MANUAL.

57-2-20-004-D


ALLOWING SIDEWALK ON ONE SIDE OF STREET 1 (NORTH SIDE); THE FUTURE DEVELOPMENT TO THE SOUTH ALLOWING SIDEWALK ON ONE SIDE OF STREET 2 (WEST SIDE); THE PRIORITY OF THE EAST SIDE OF THE STREET IS TO MAXIMIZE OPEN SPACE WITH LANDSCAPED AREA. SPECIAL EXCEPTION FOR SECTION 4.5.6.B. STREET TREES TO ALLOW STREET TREES TO BE LOCATED MORE THAN 15


SPECIAL EXCEPTION FOR SECTION 3.7.3.C.4. TO ALLOW LOT COVERAGE (MAXIMUM) TO EXCEED 90 PERCENT. SPECIAL EXCEPTION FOR SECTION 3.5.1.D.3(A)(1) TO ALLOW UPPER LEVEL INTERIOR HEIGHTS LESS THAN THE


SPECIAL EXCEPTION FOR SECTION 4.3.3B TO NOT REQUIRE AN OFFSITE VEHICULAR CONNECTION TO PARCEL

PFM WAIVER FOR STREET DETAIL 401-01 FOR ALLOWING FOR A ROW LESS THAN 100' (WHICH IS 50' FROM STREET CENTERLINE) ALONG BLENHEIM BOULEVARD (MINOR ARTERIAL STREET CLASSIFICATION). A PUBLIC ACCESS EASEMENT WILL BE PROVIDED FOR THE PORTION OF STREET AND SIDEWALK THAT IS ON PRIVATE PROPERTY FOR


17.11. PFM WAIVER FOR STREET DETAIL 401-01 FOR ALLOWING LOCAL RESIDENTIAL STREETS TO BE LESS THAN 36' WIDE. PFM WAIVER FOR COMMERCIAL DRIVEWAY ENTRANCE DETAIL 404-06 TO ALLOW STREET 1 ENTRANCE TO BE LESS THAN 12' FROM PROPERTY LINE.

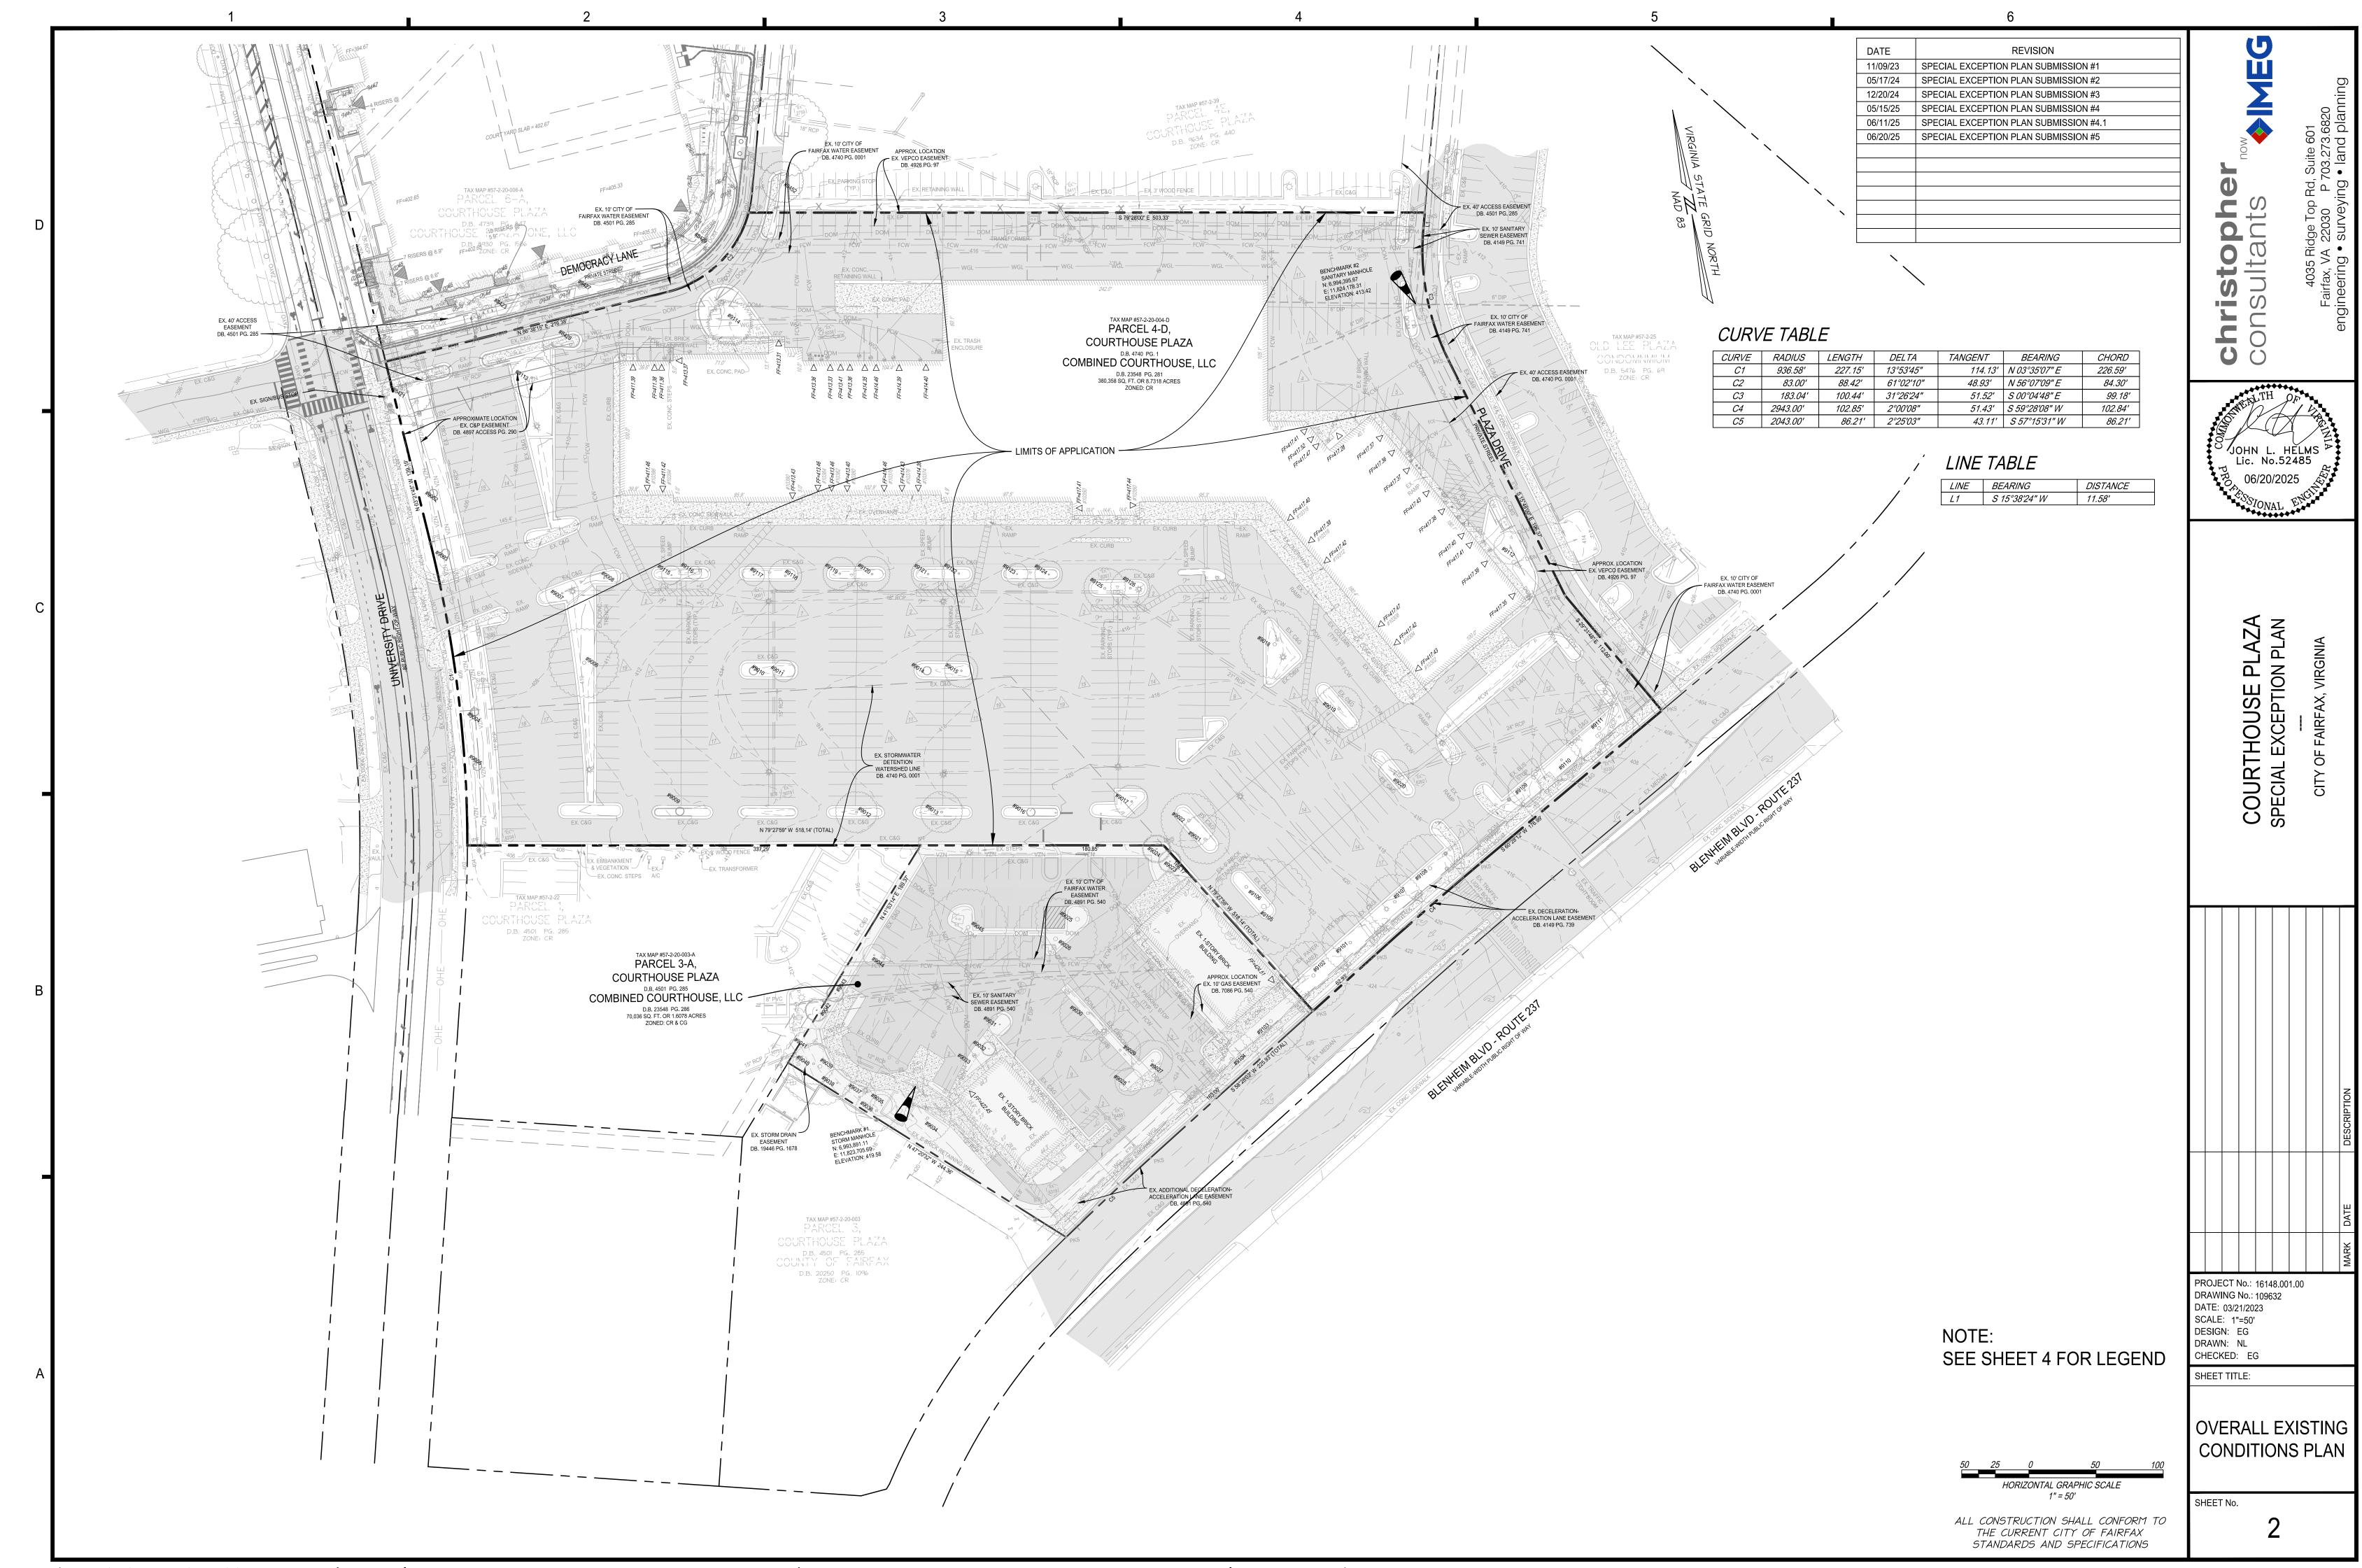


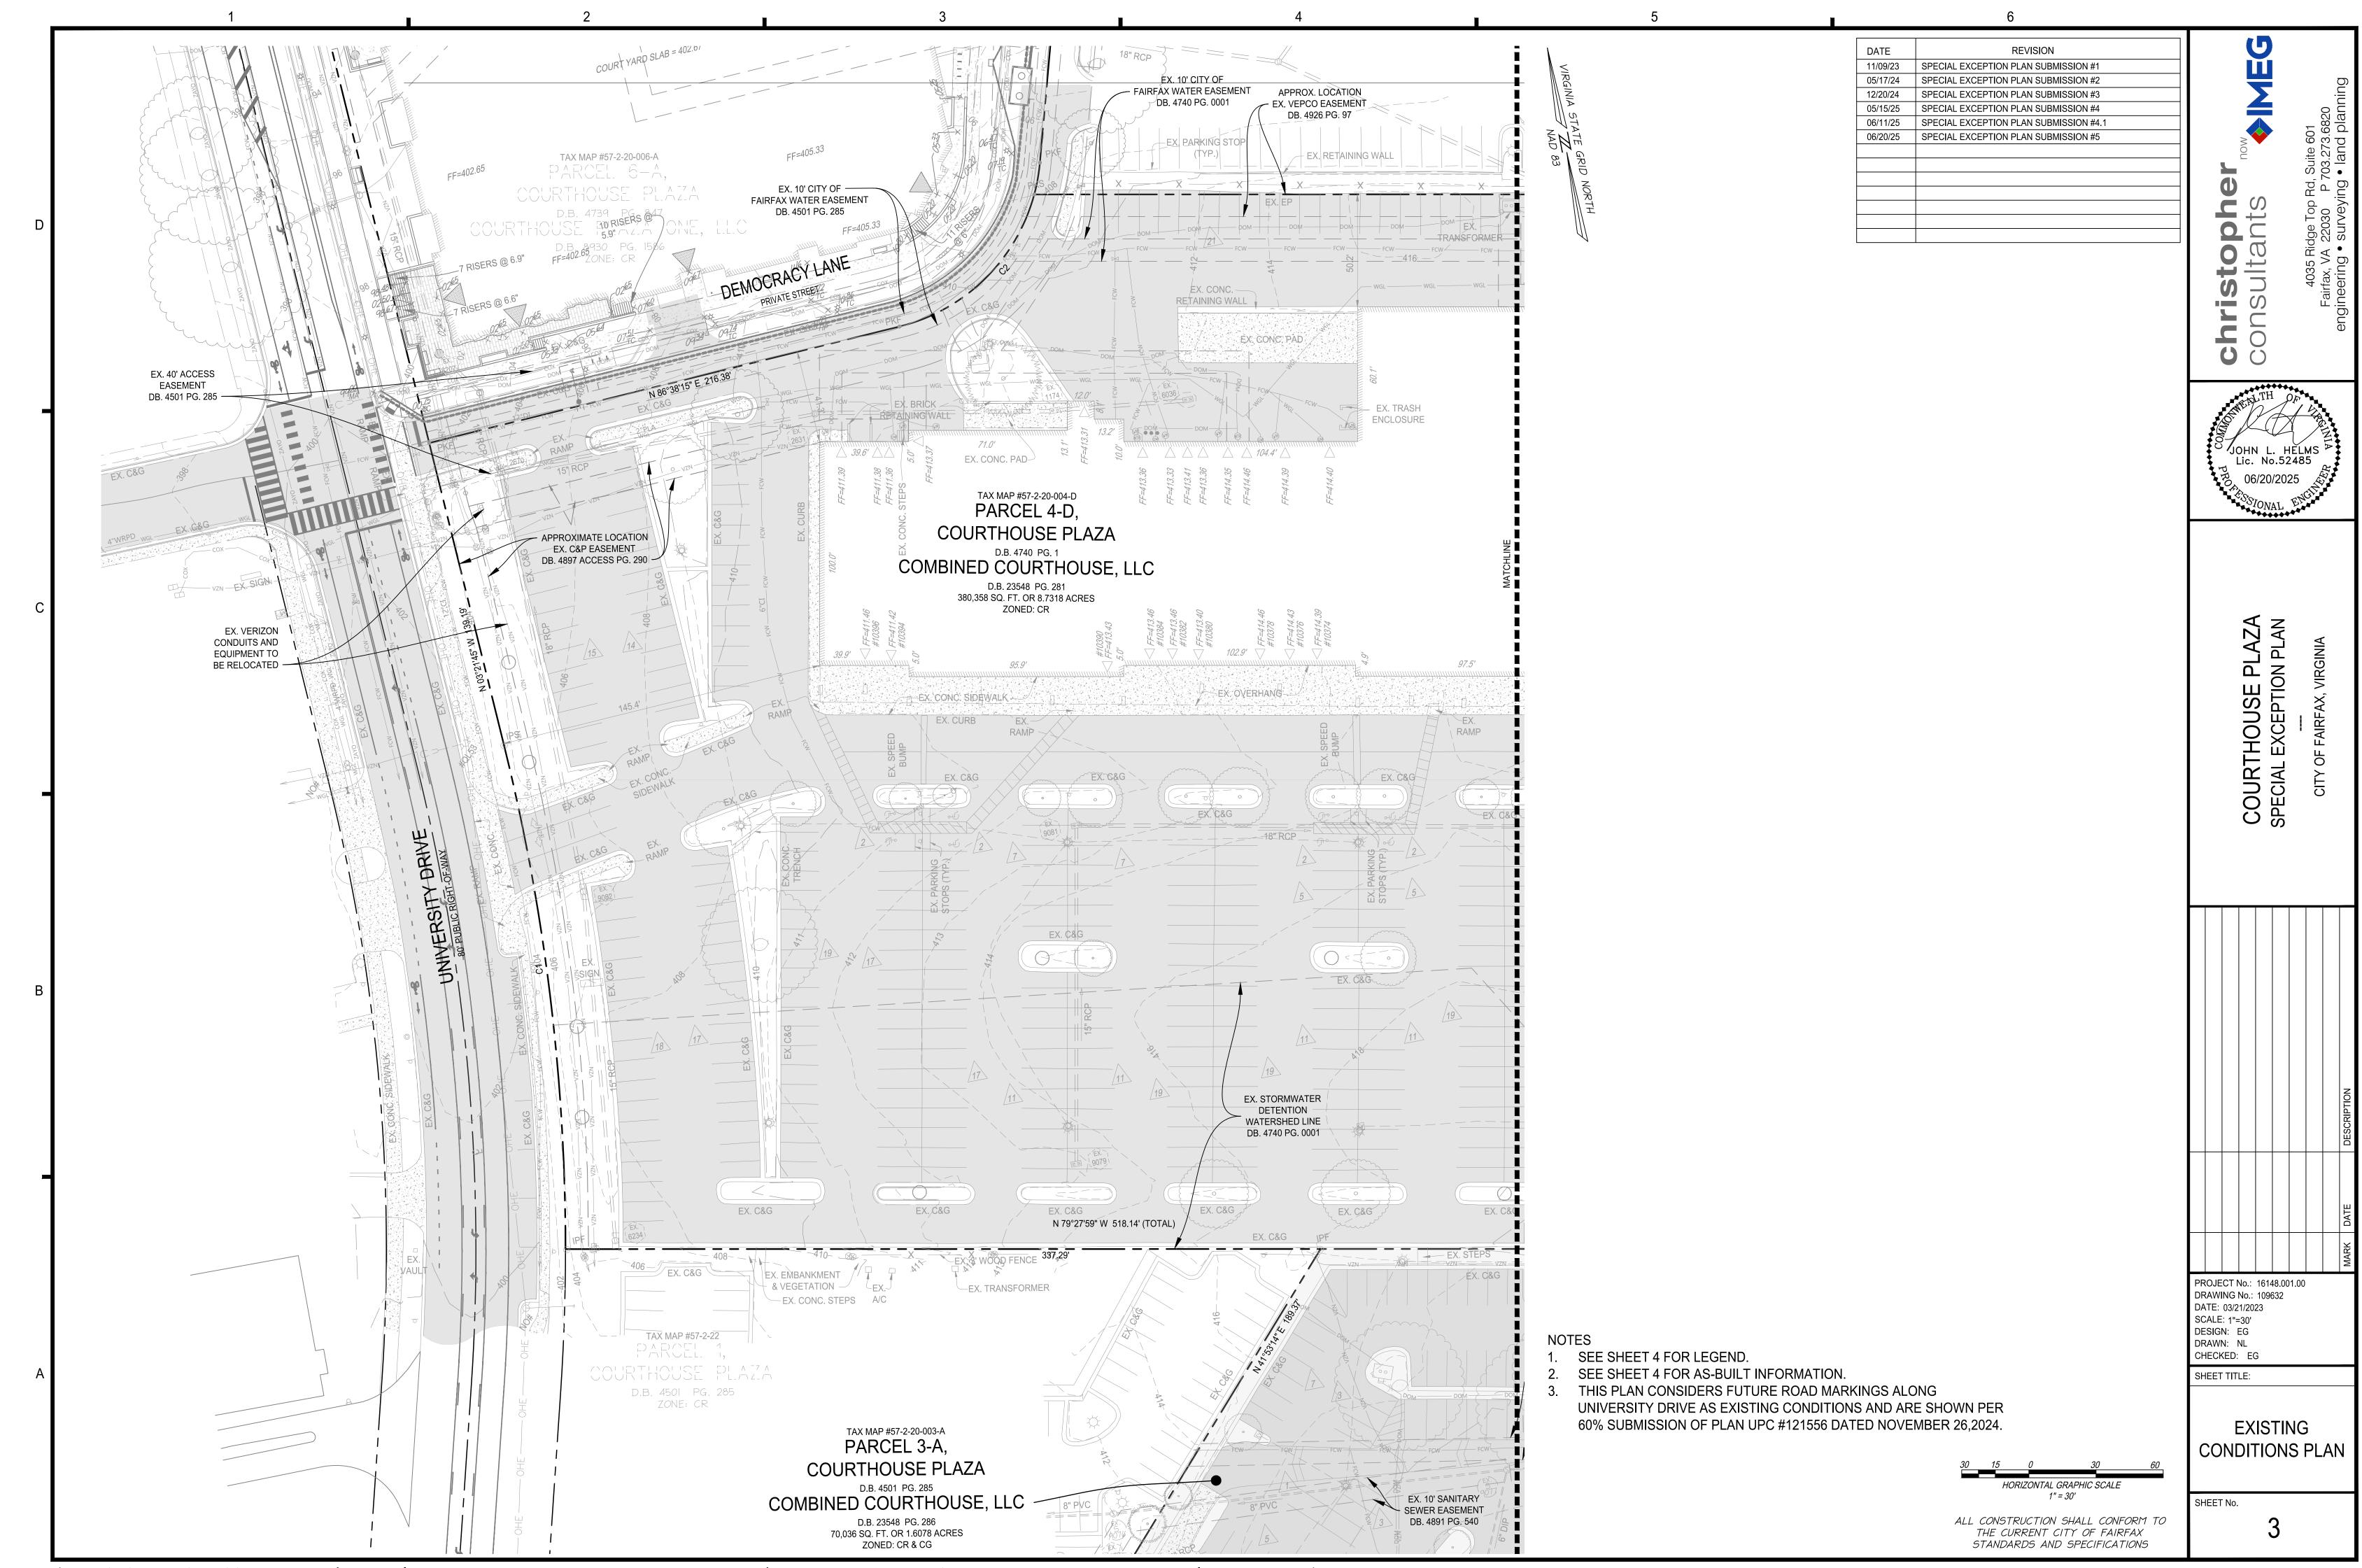

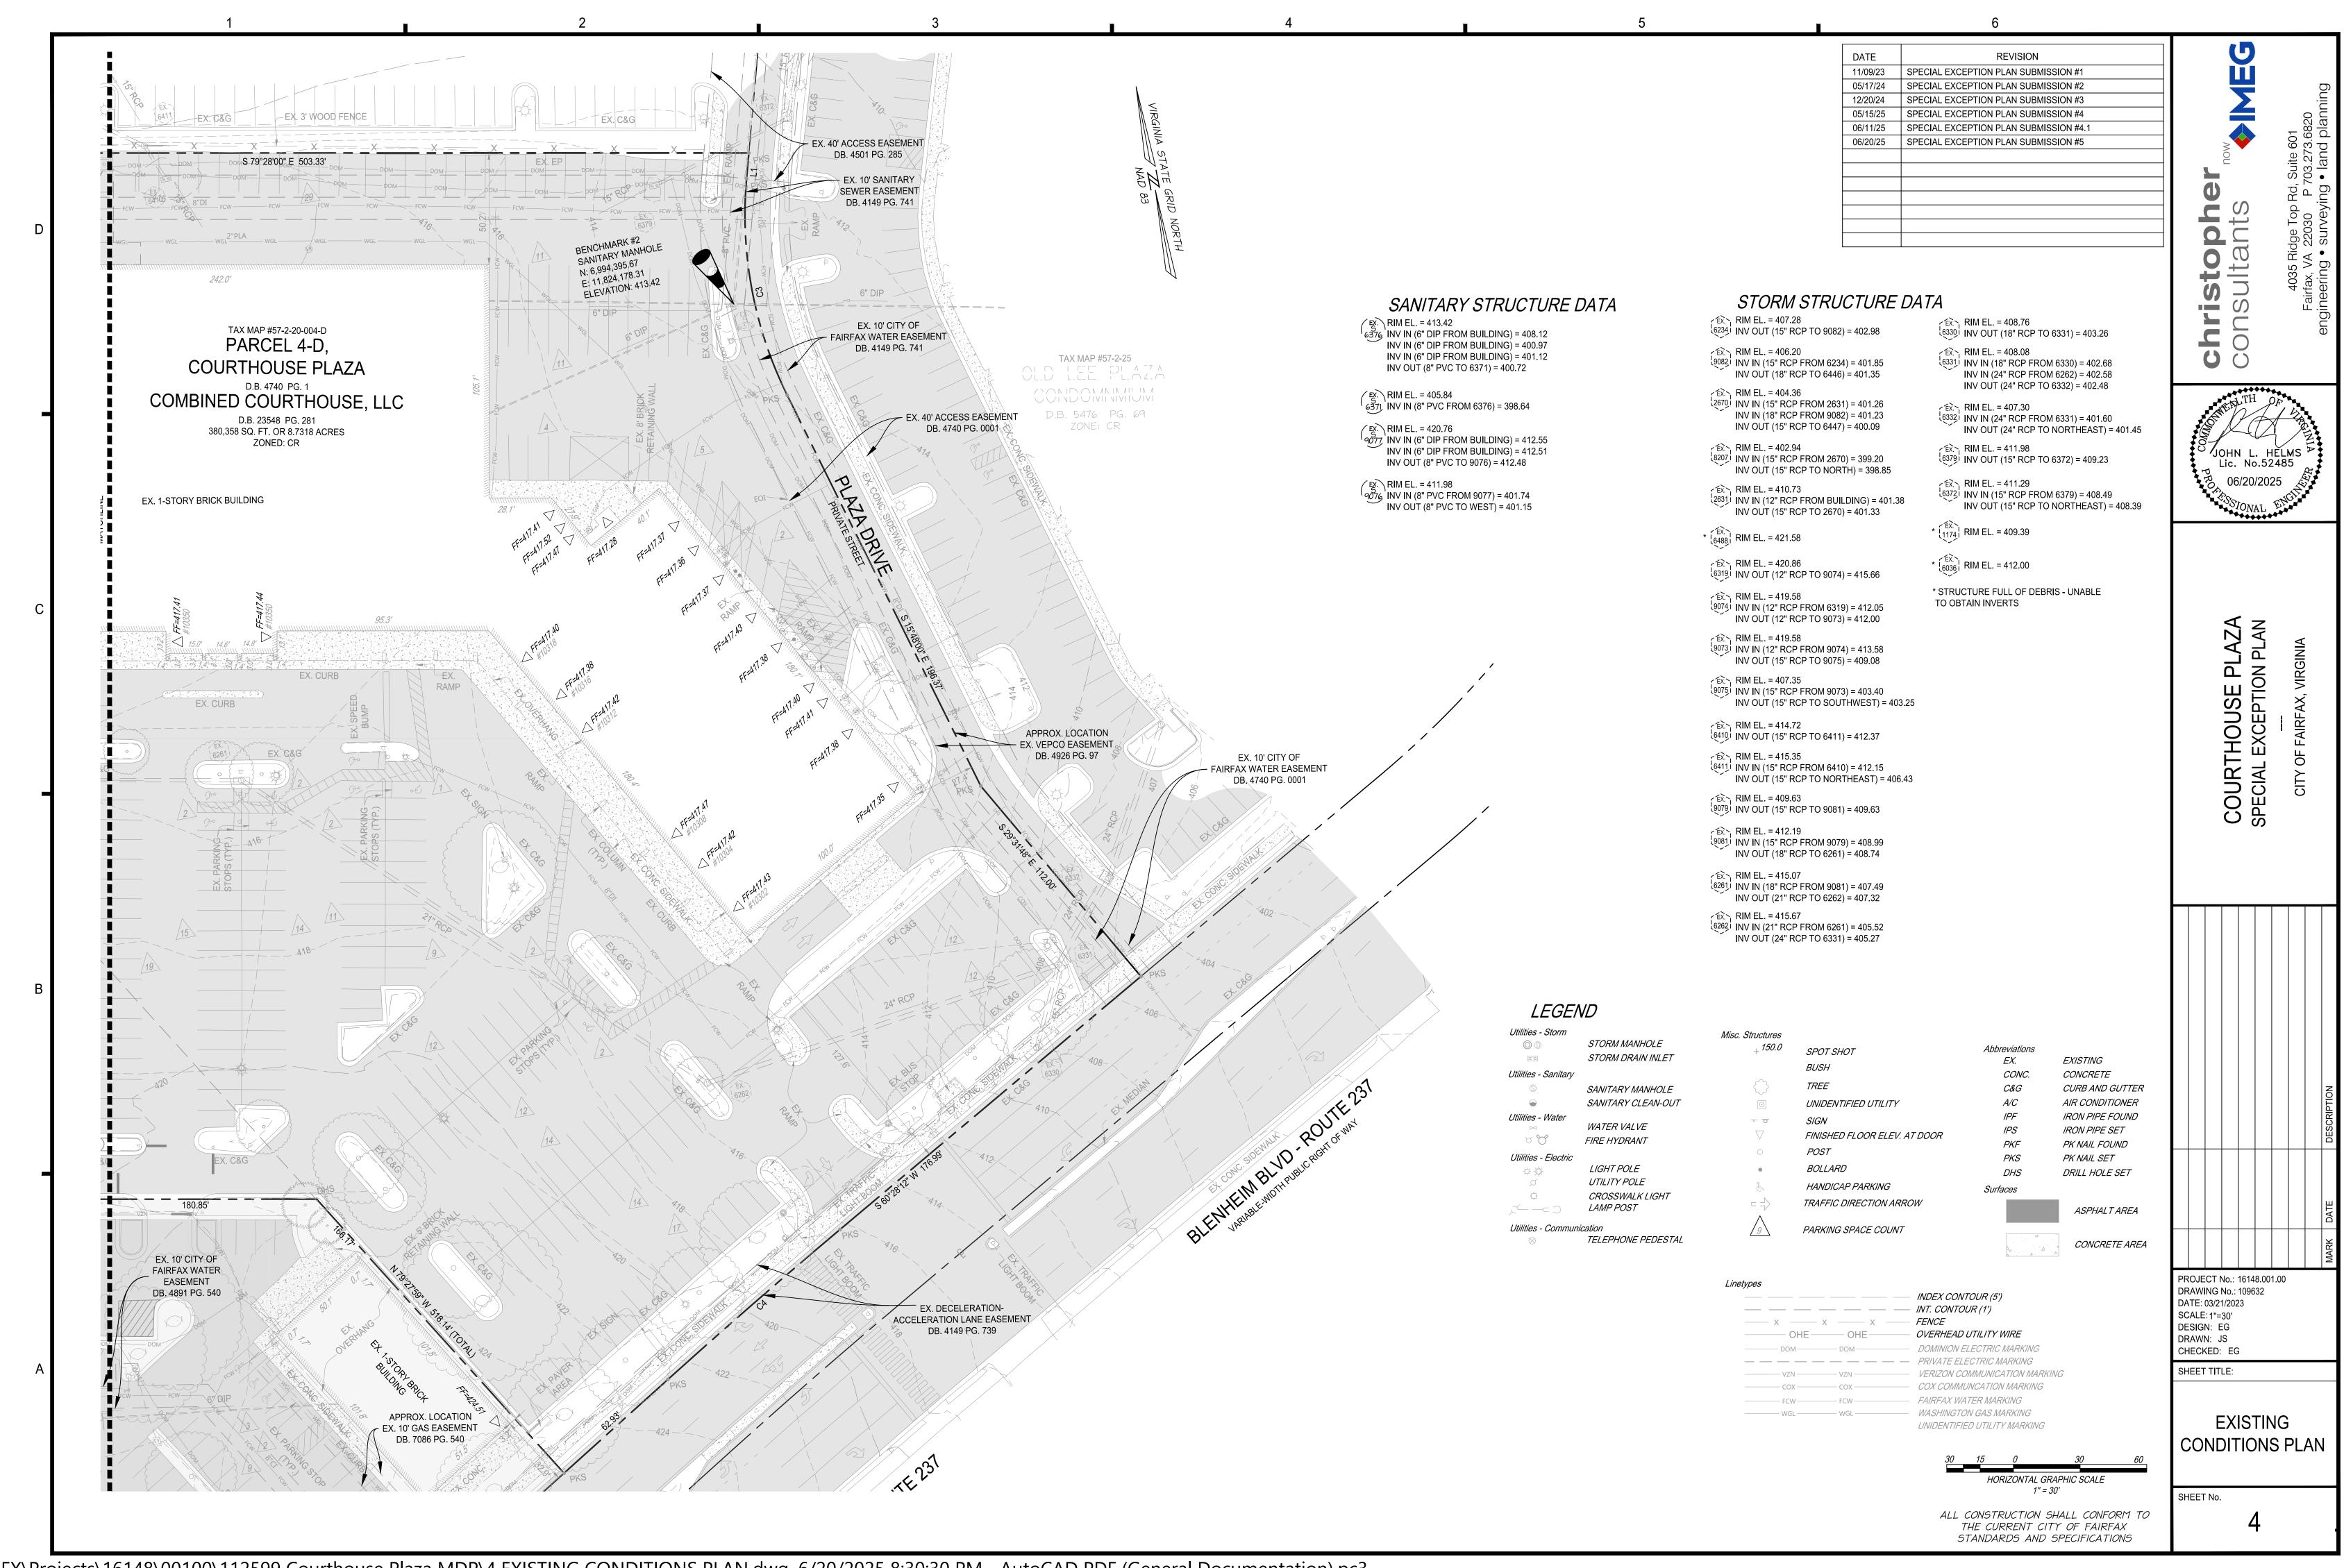


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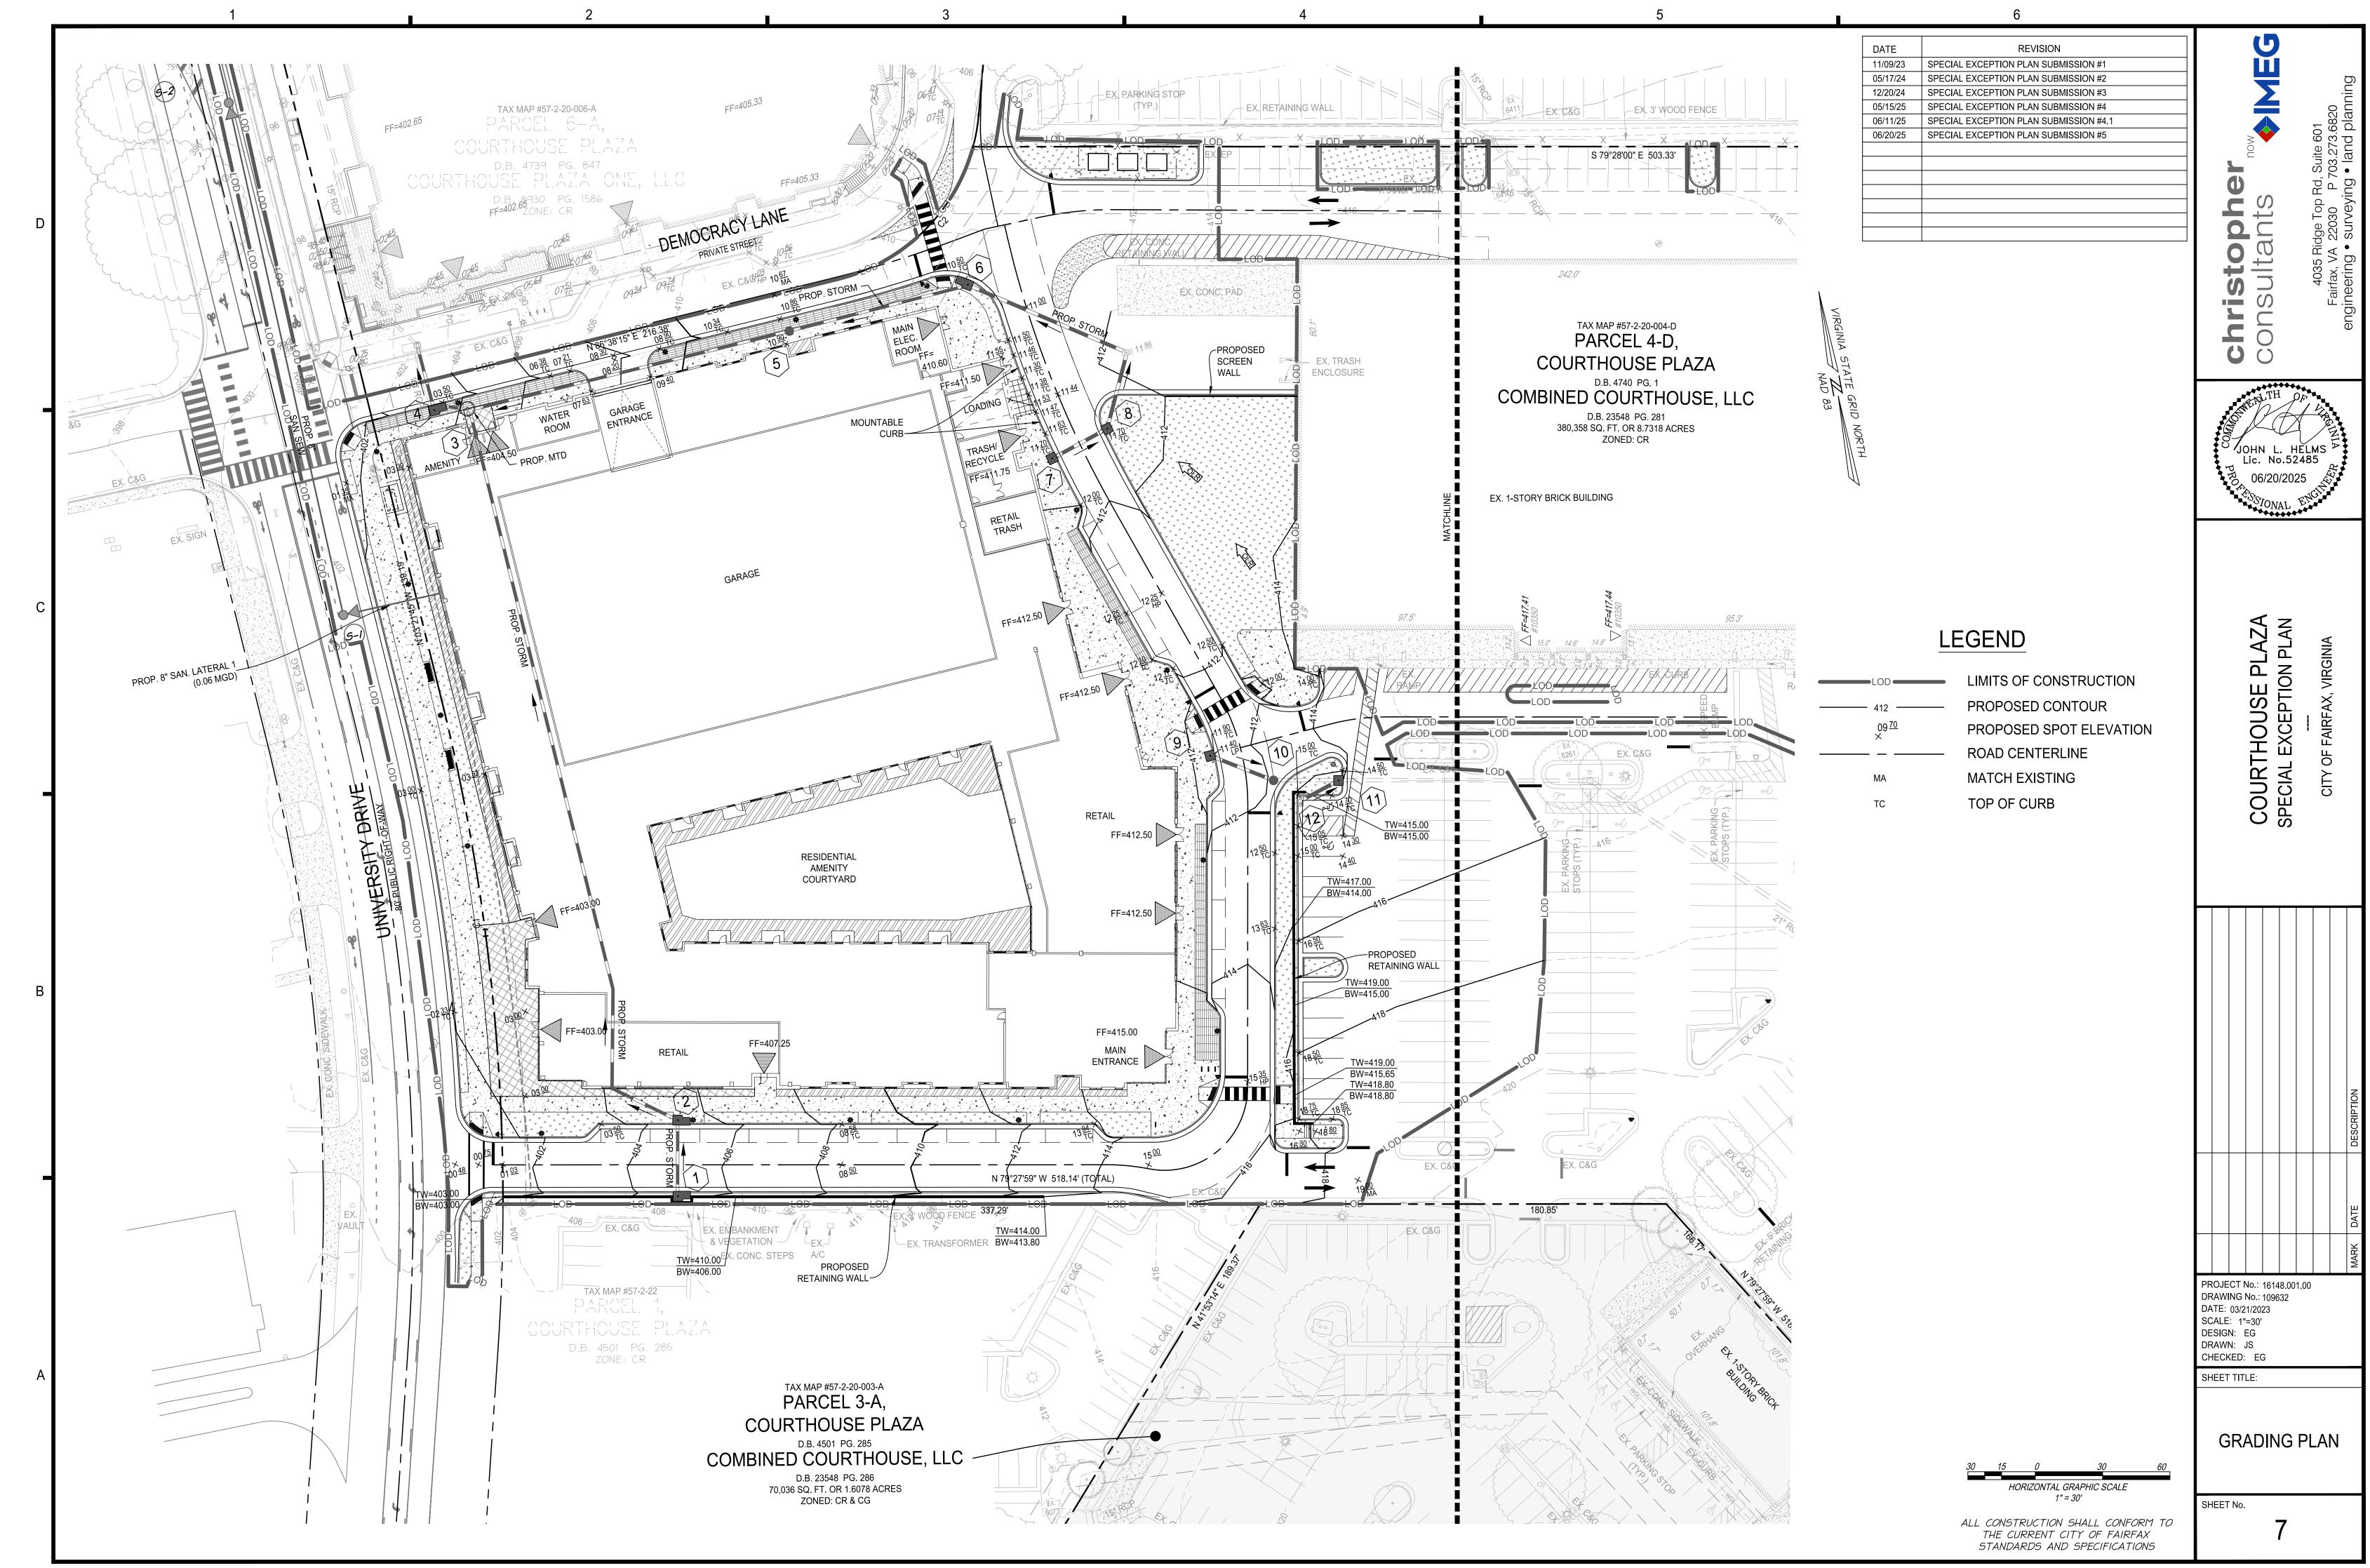


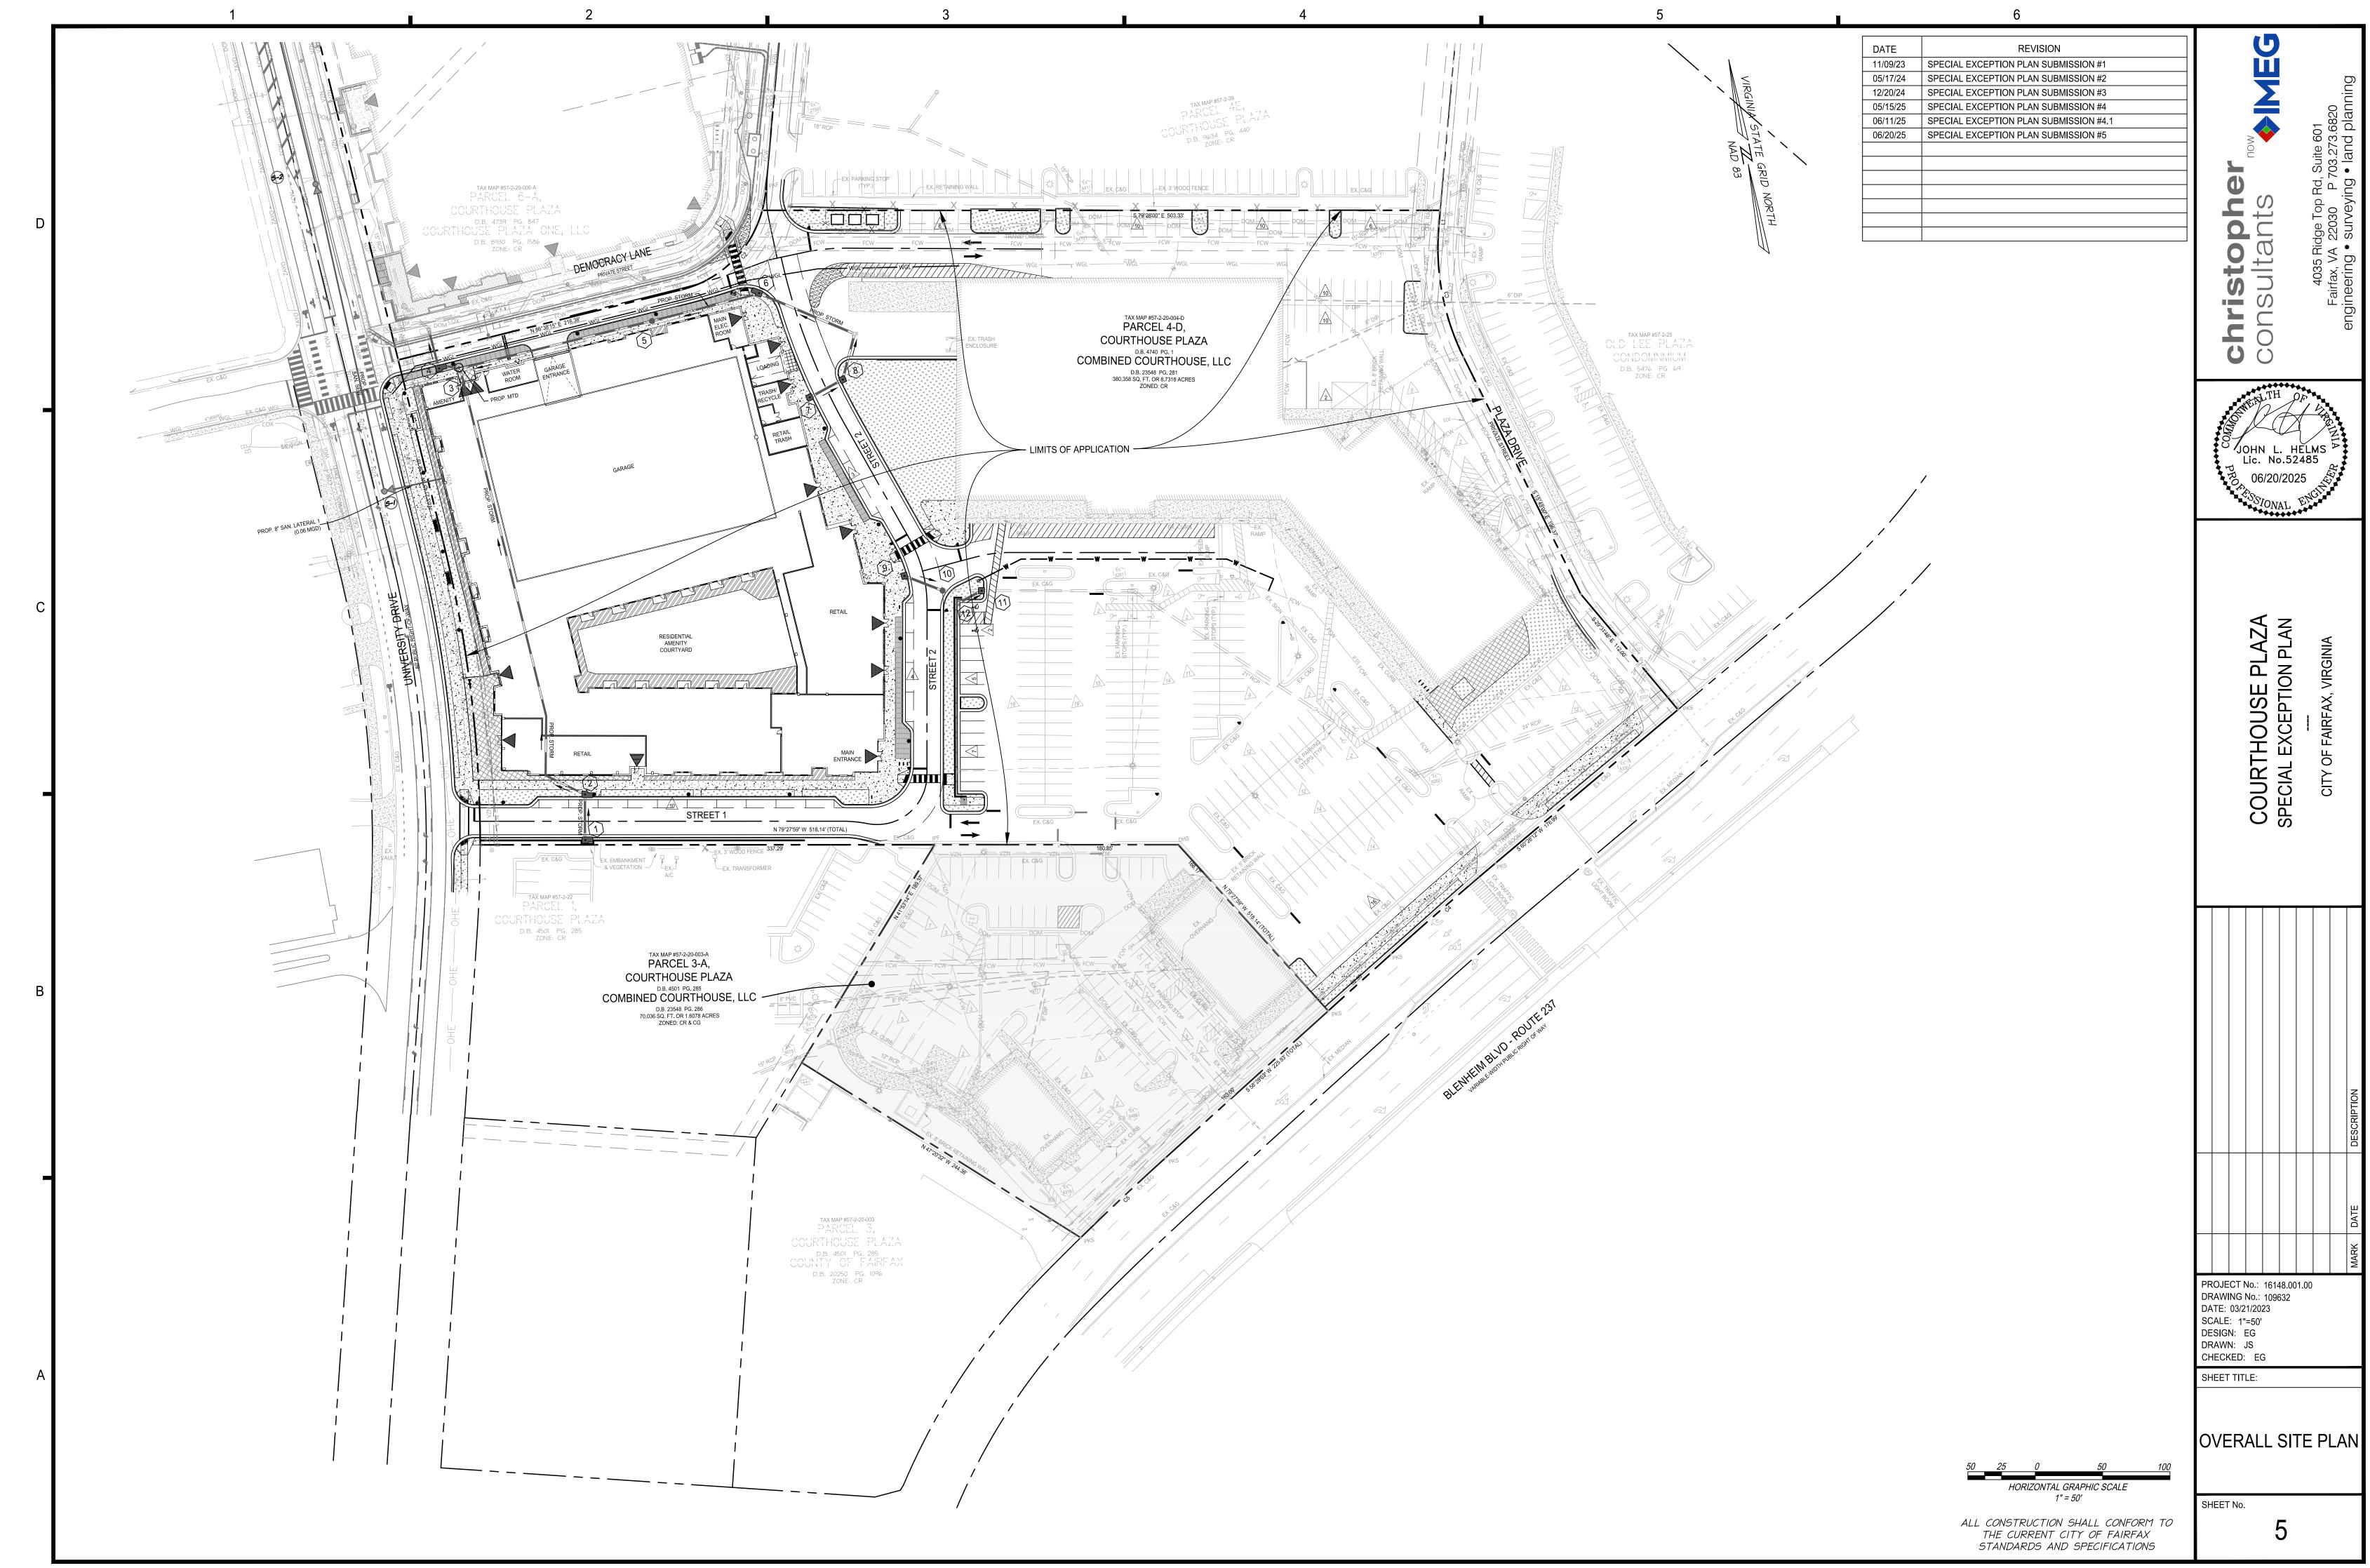


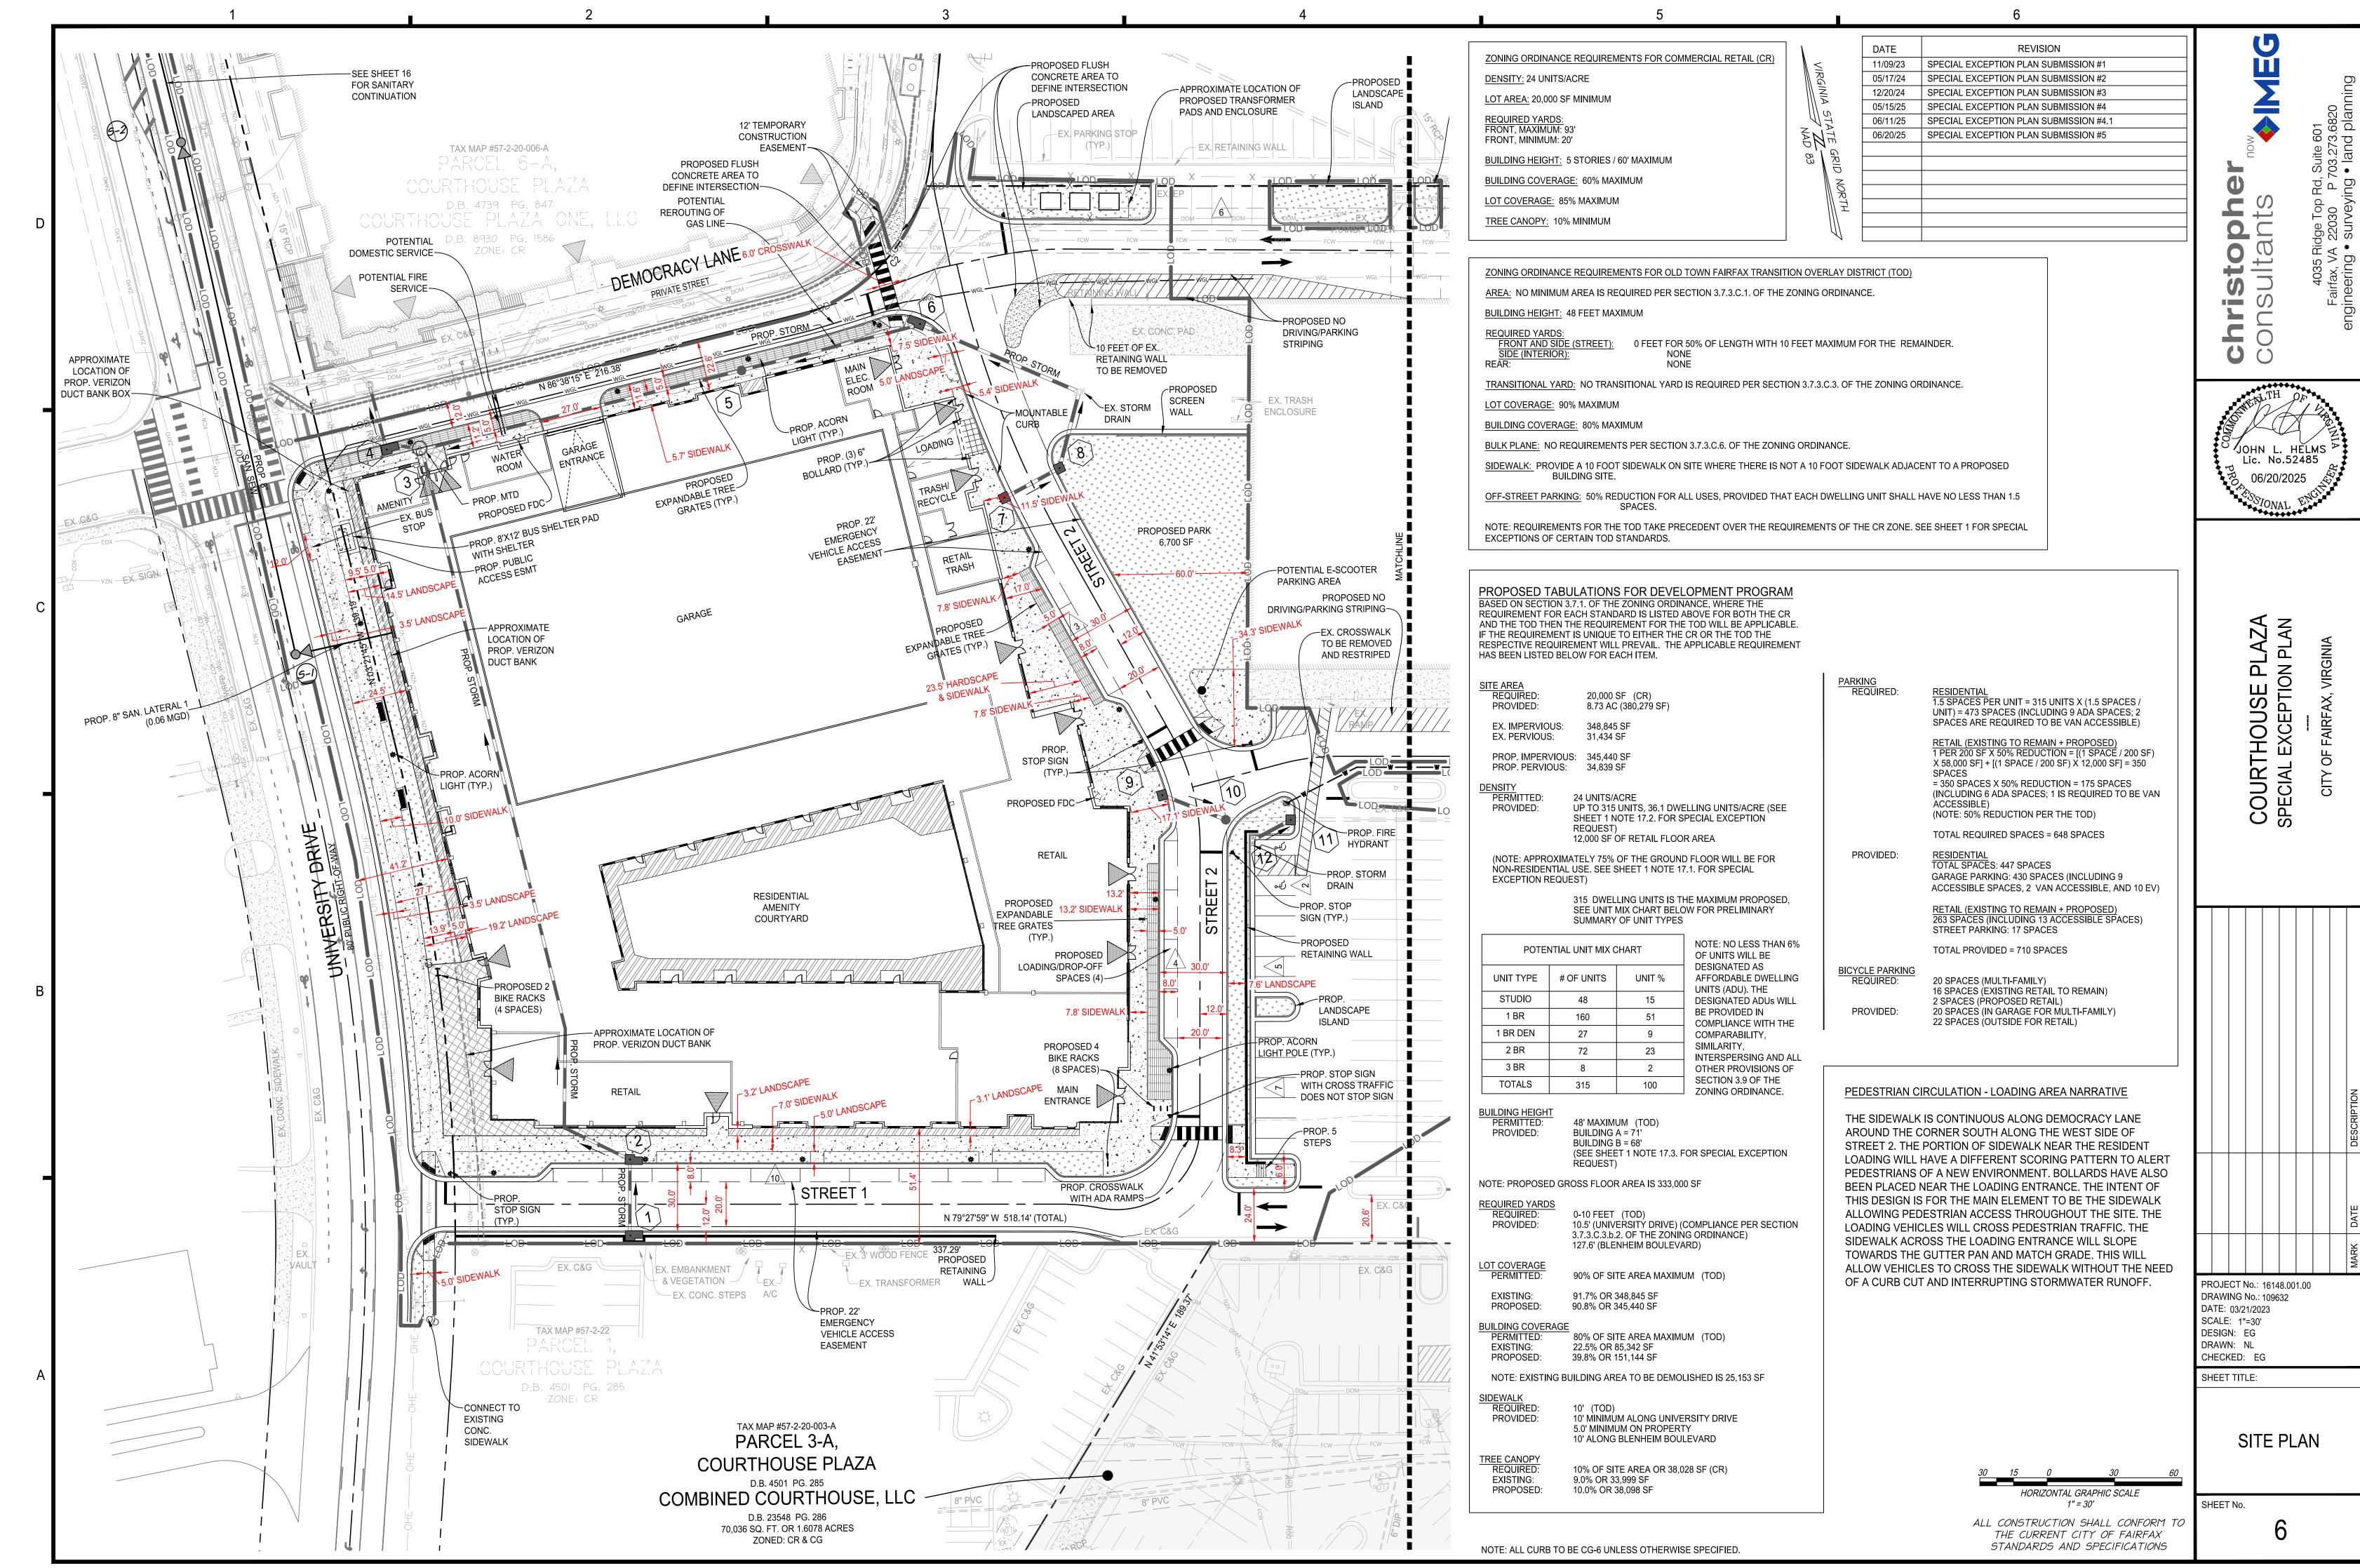
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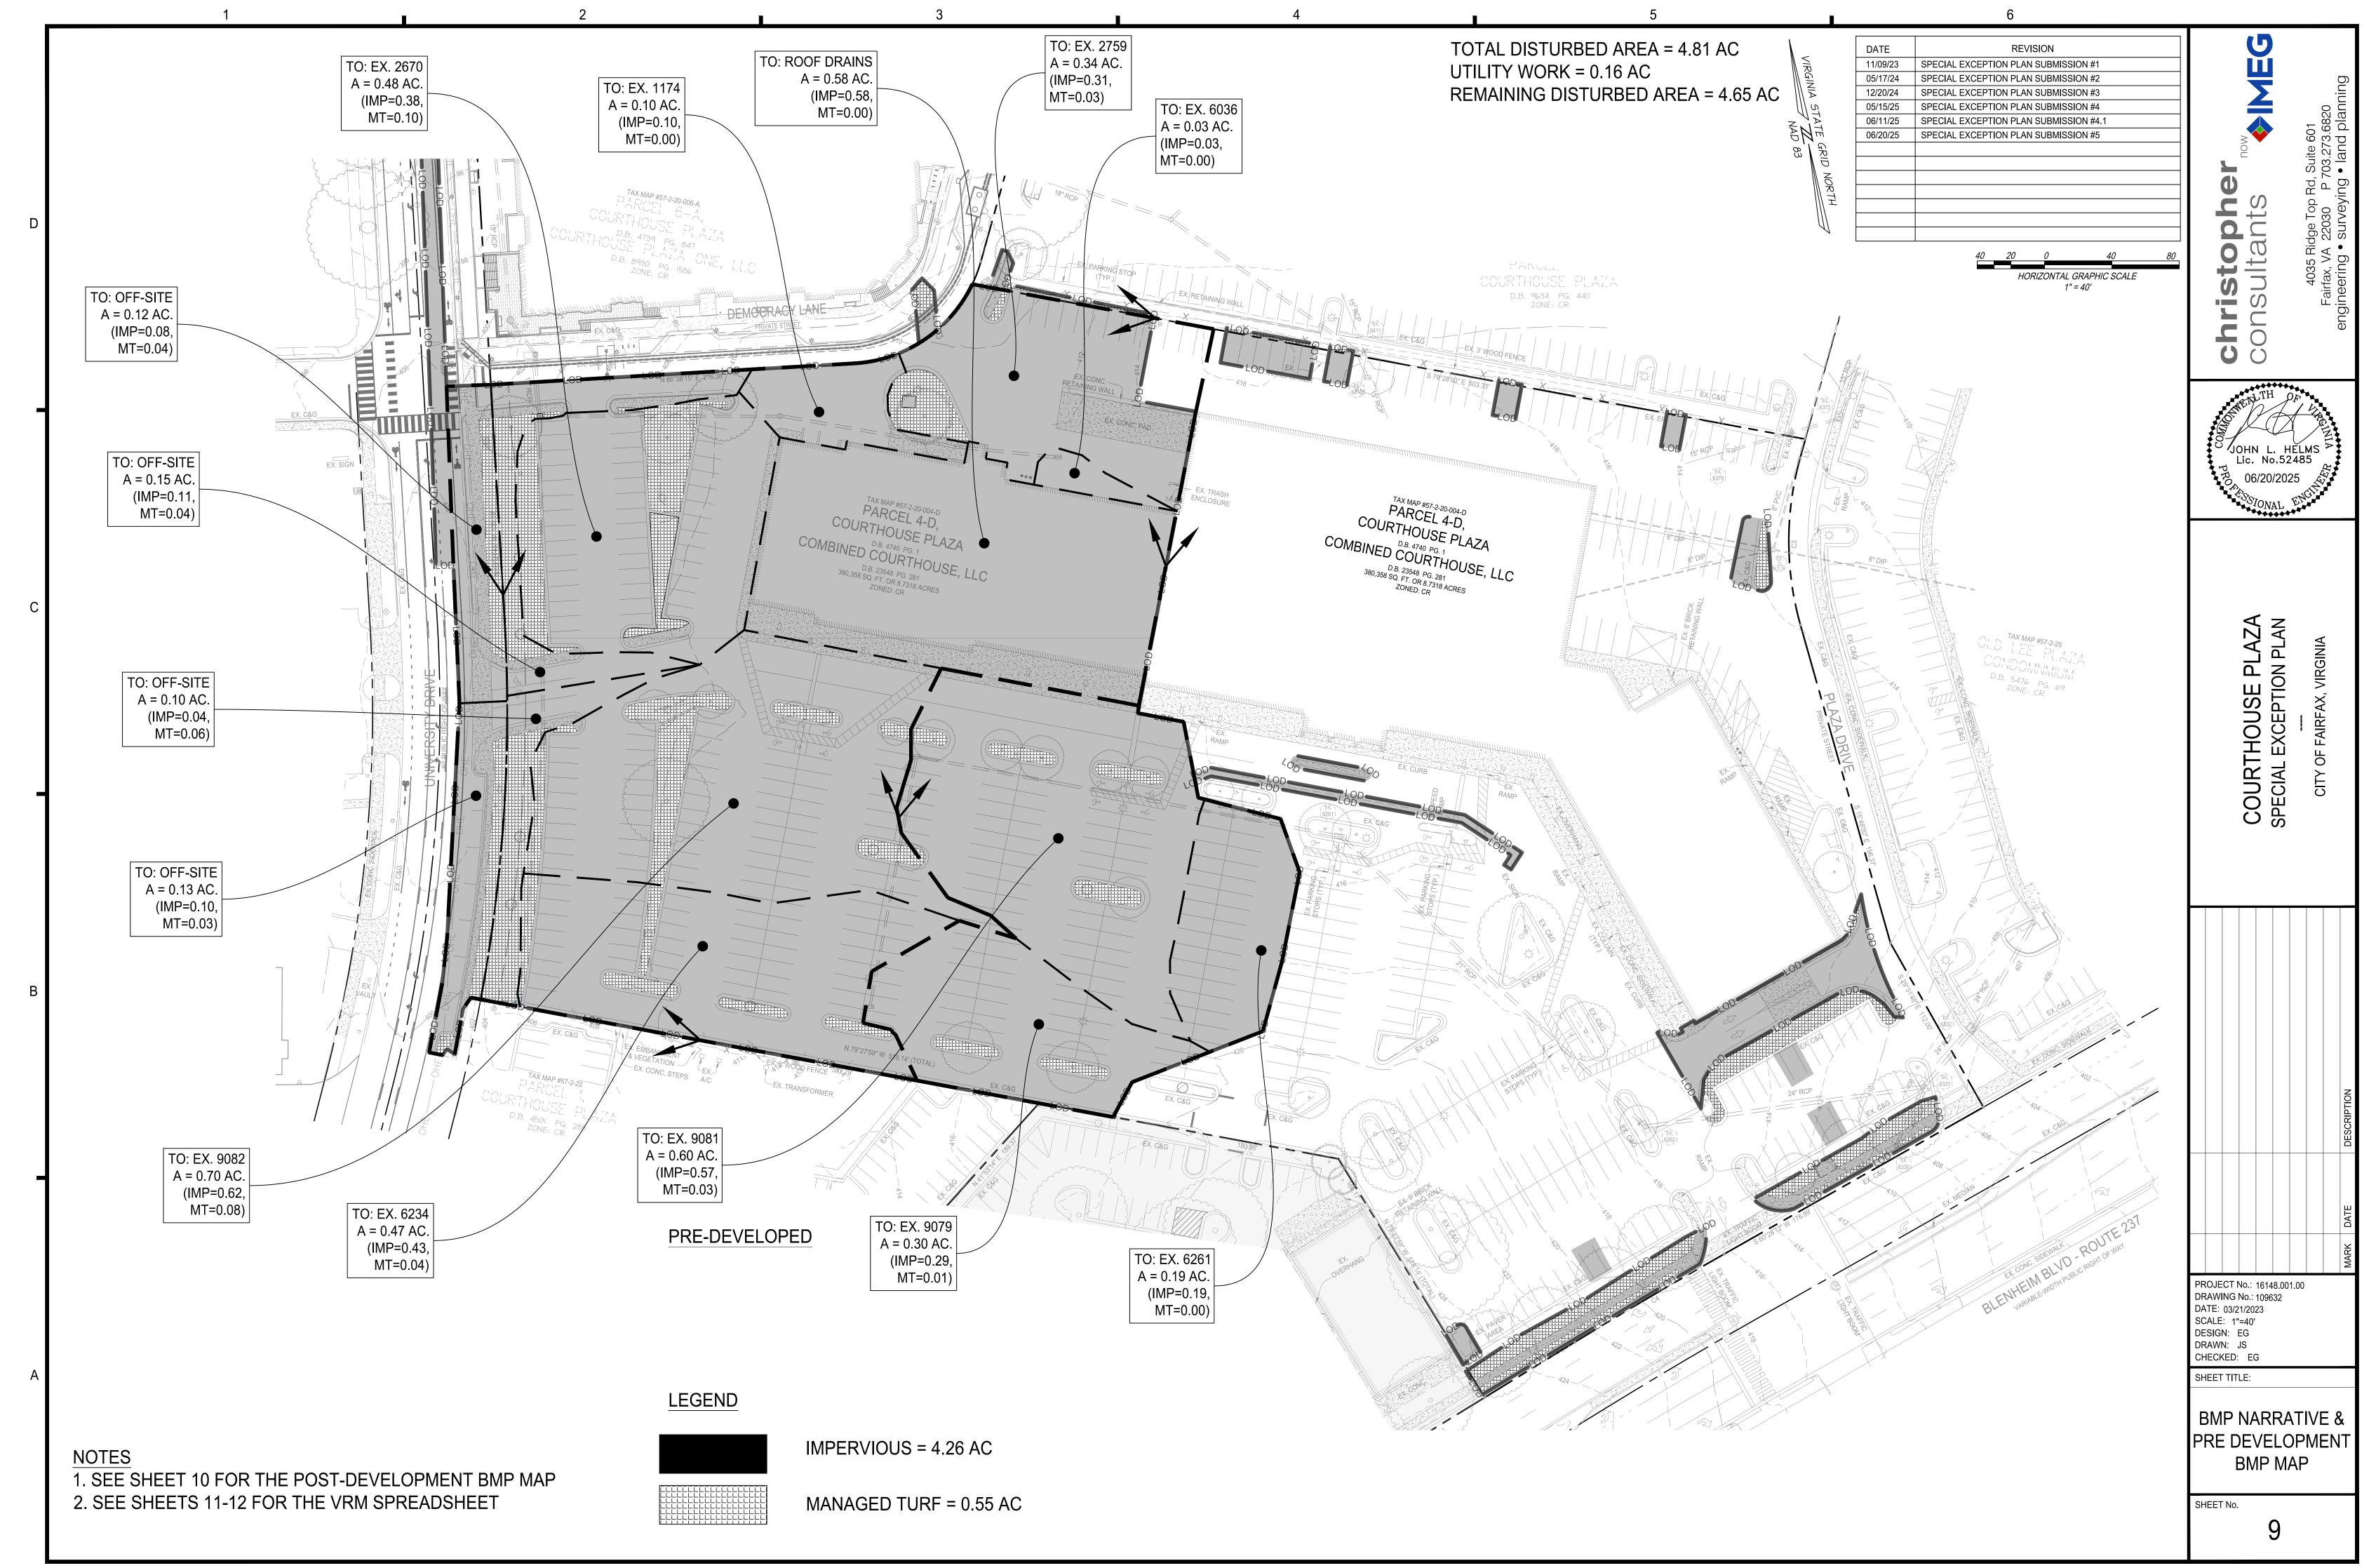



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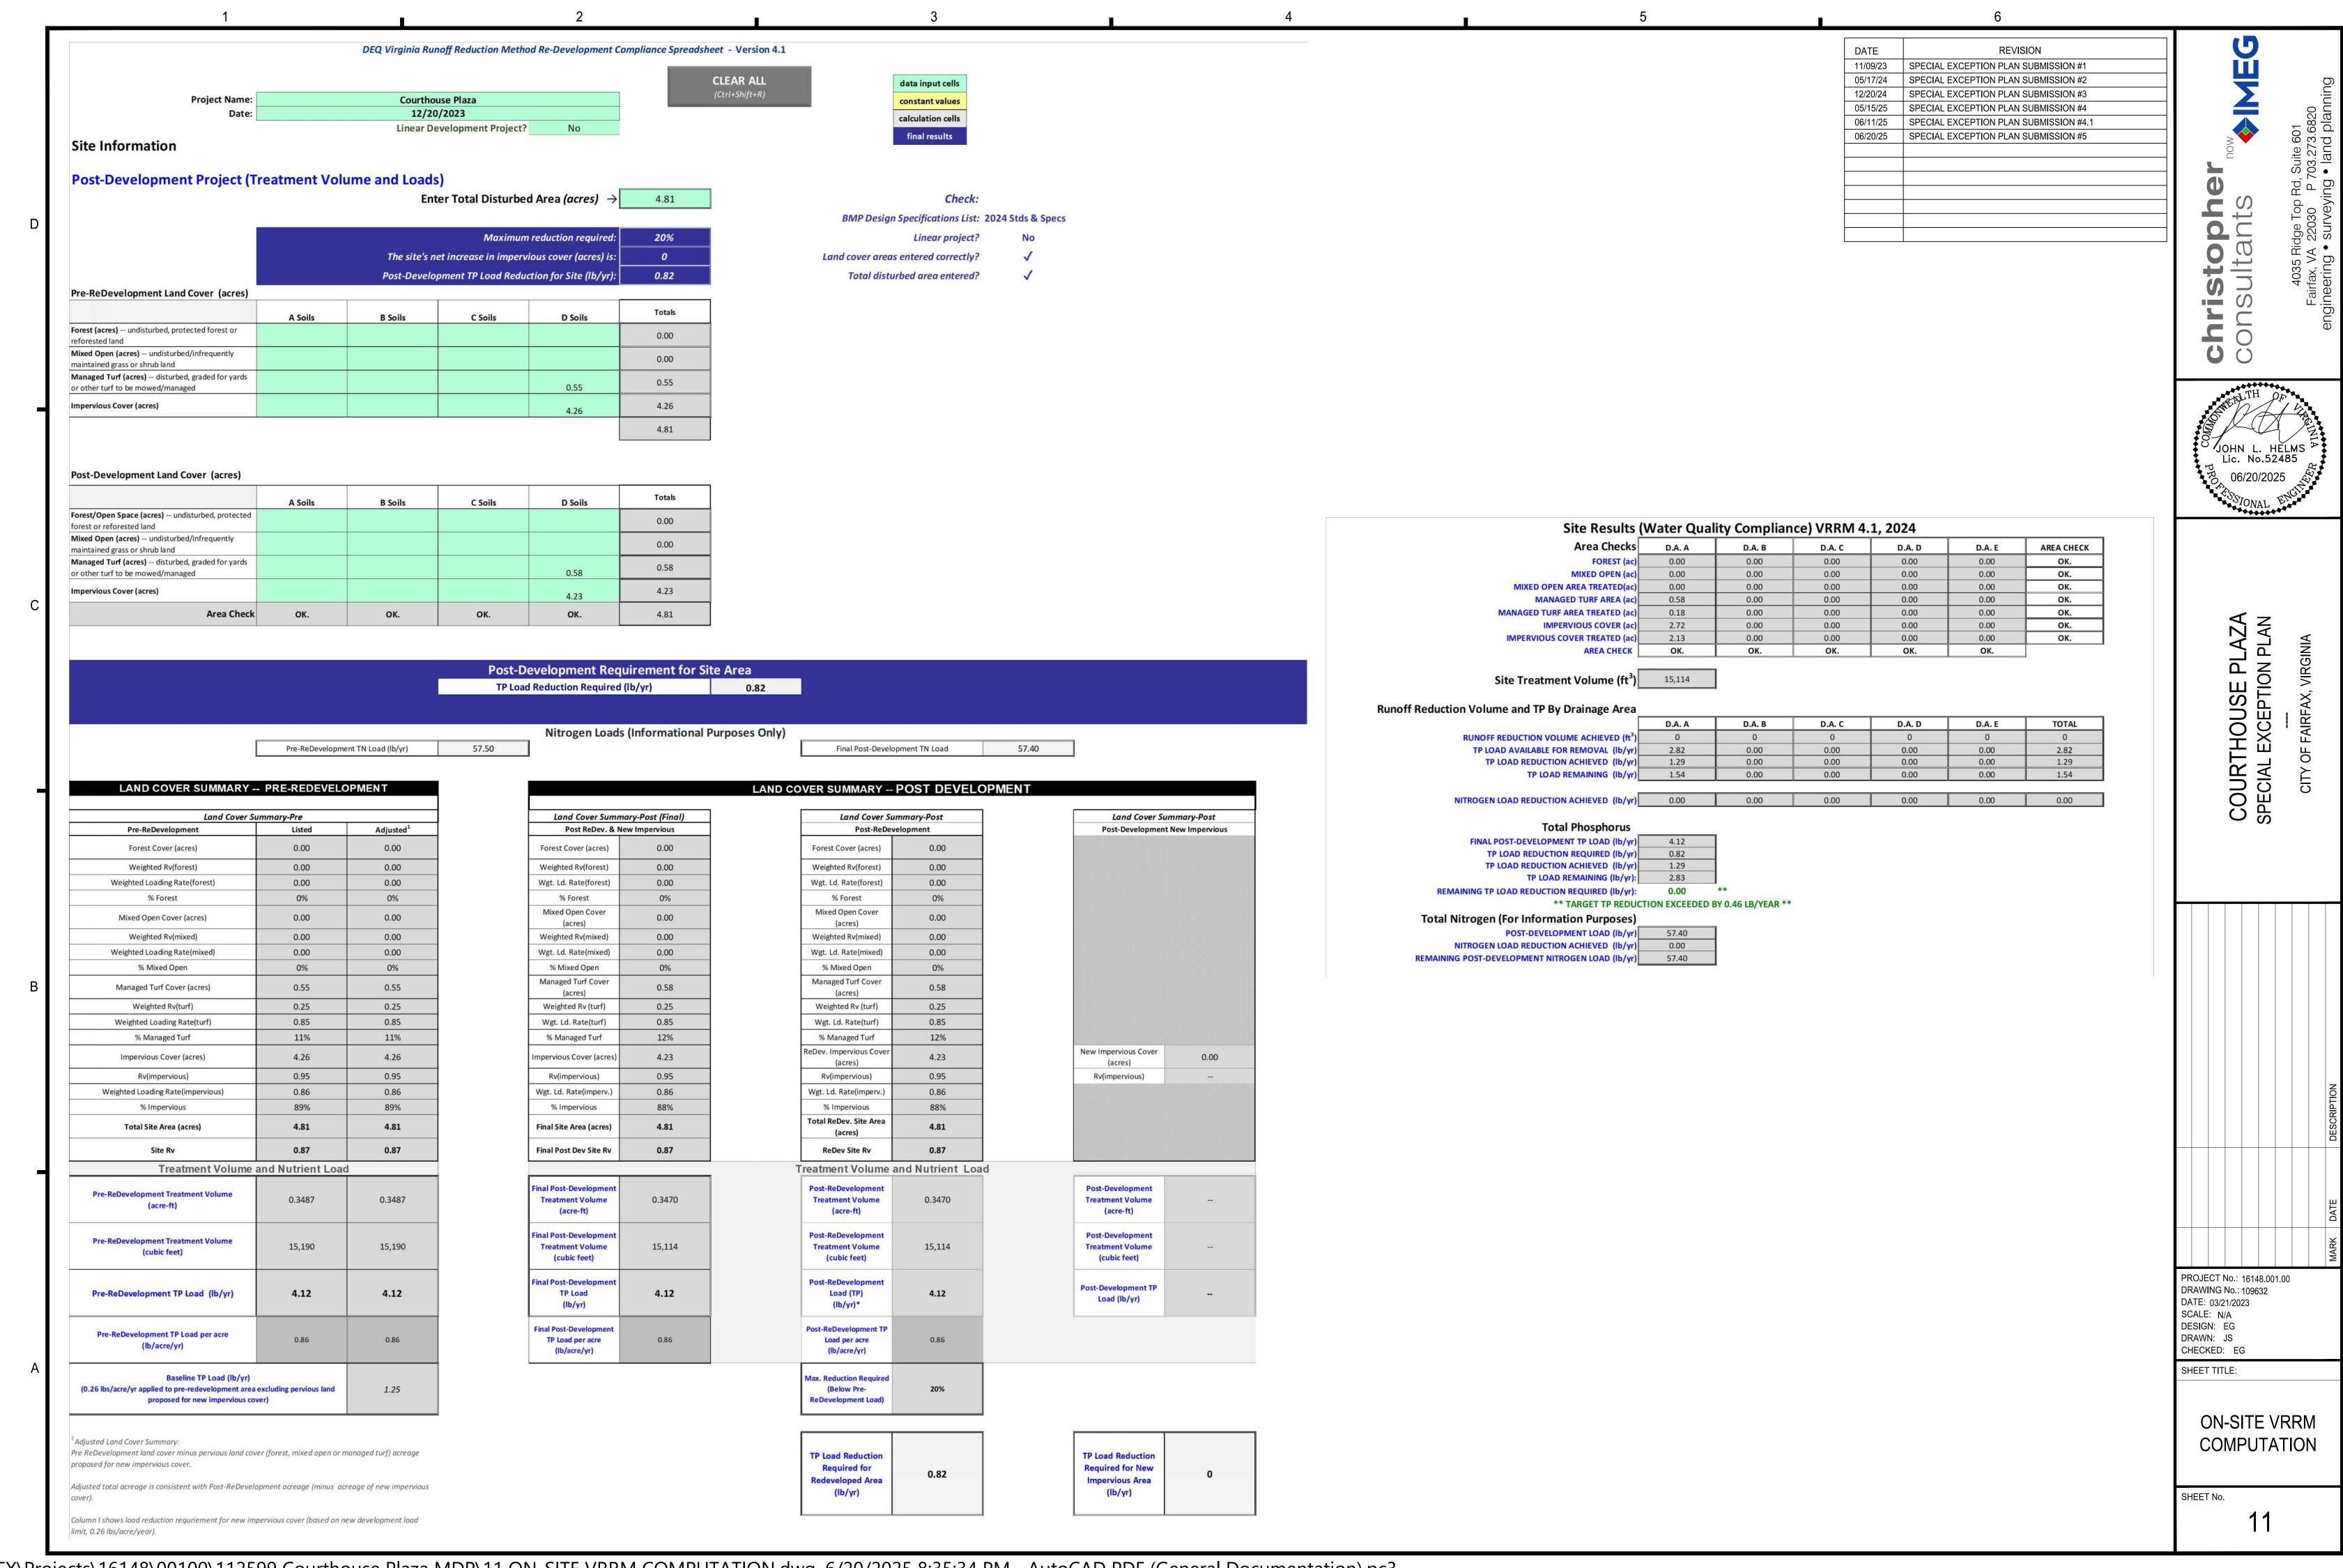


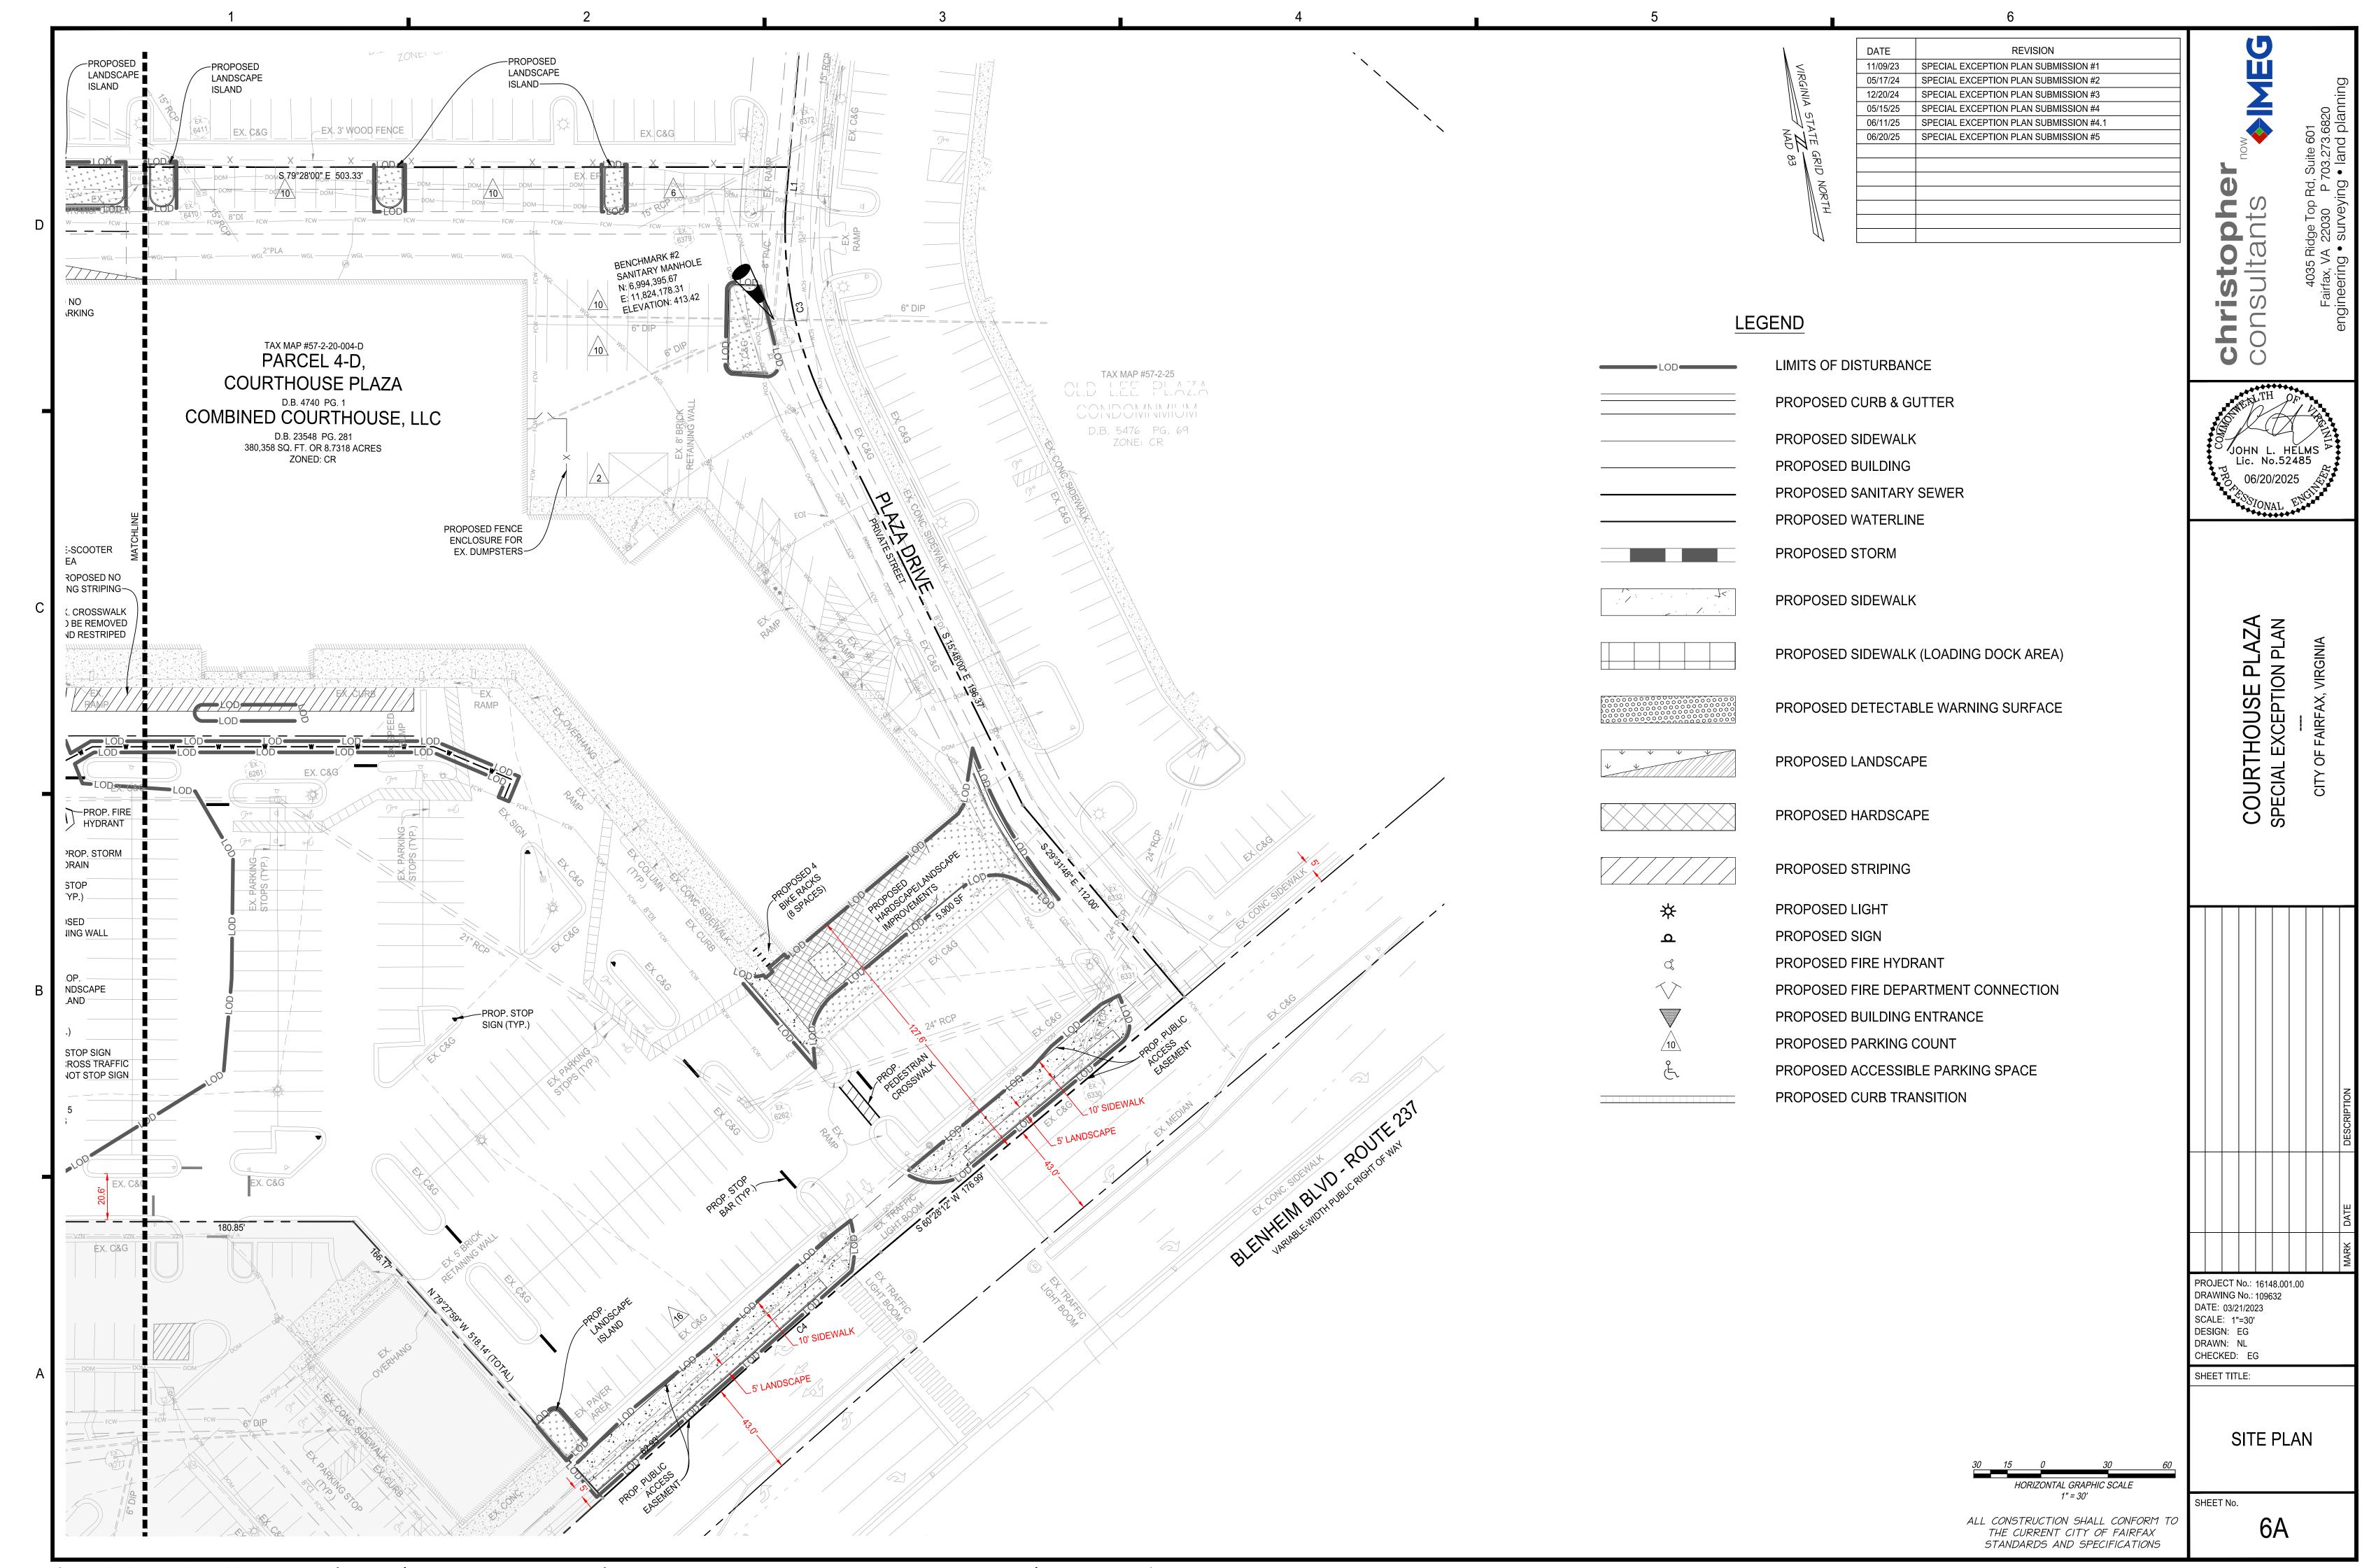



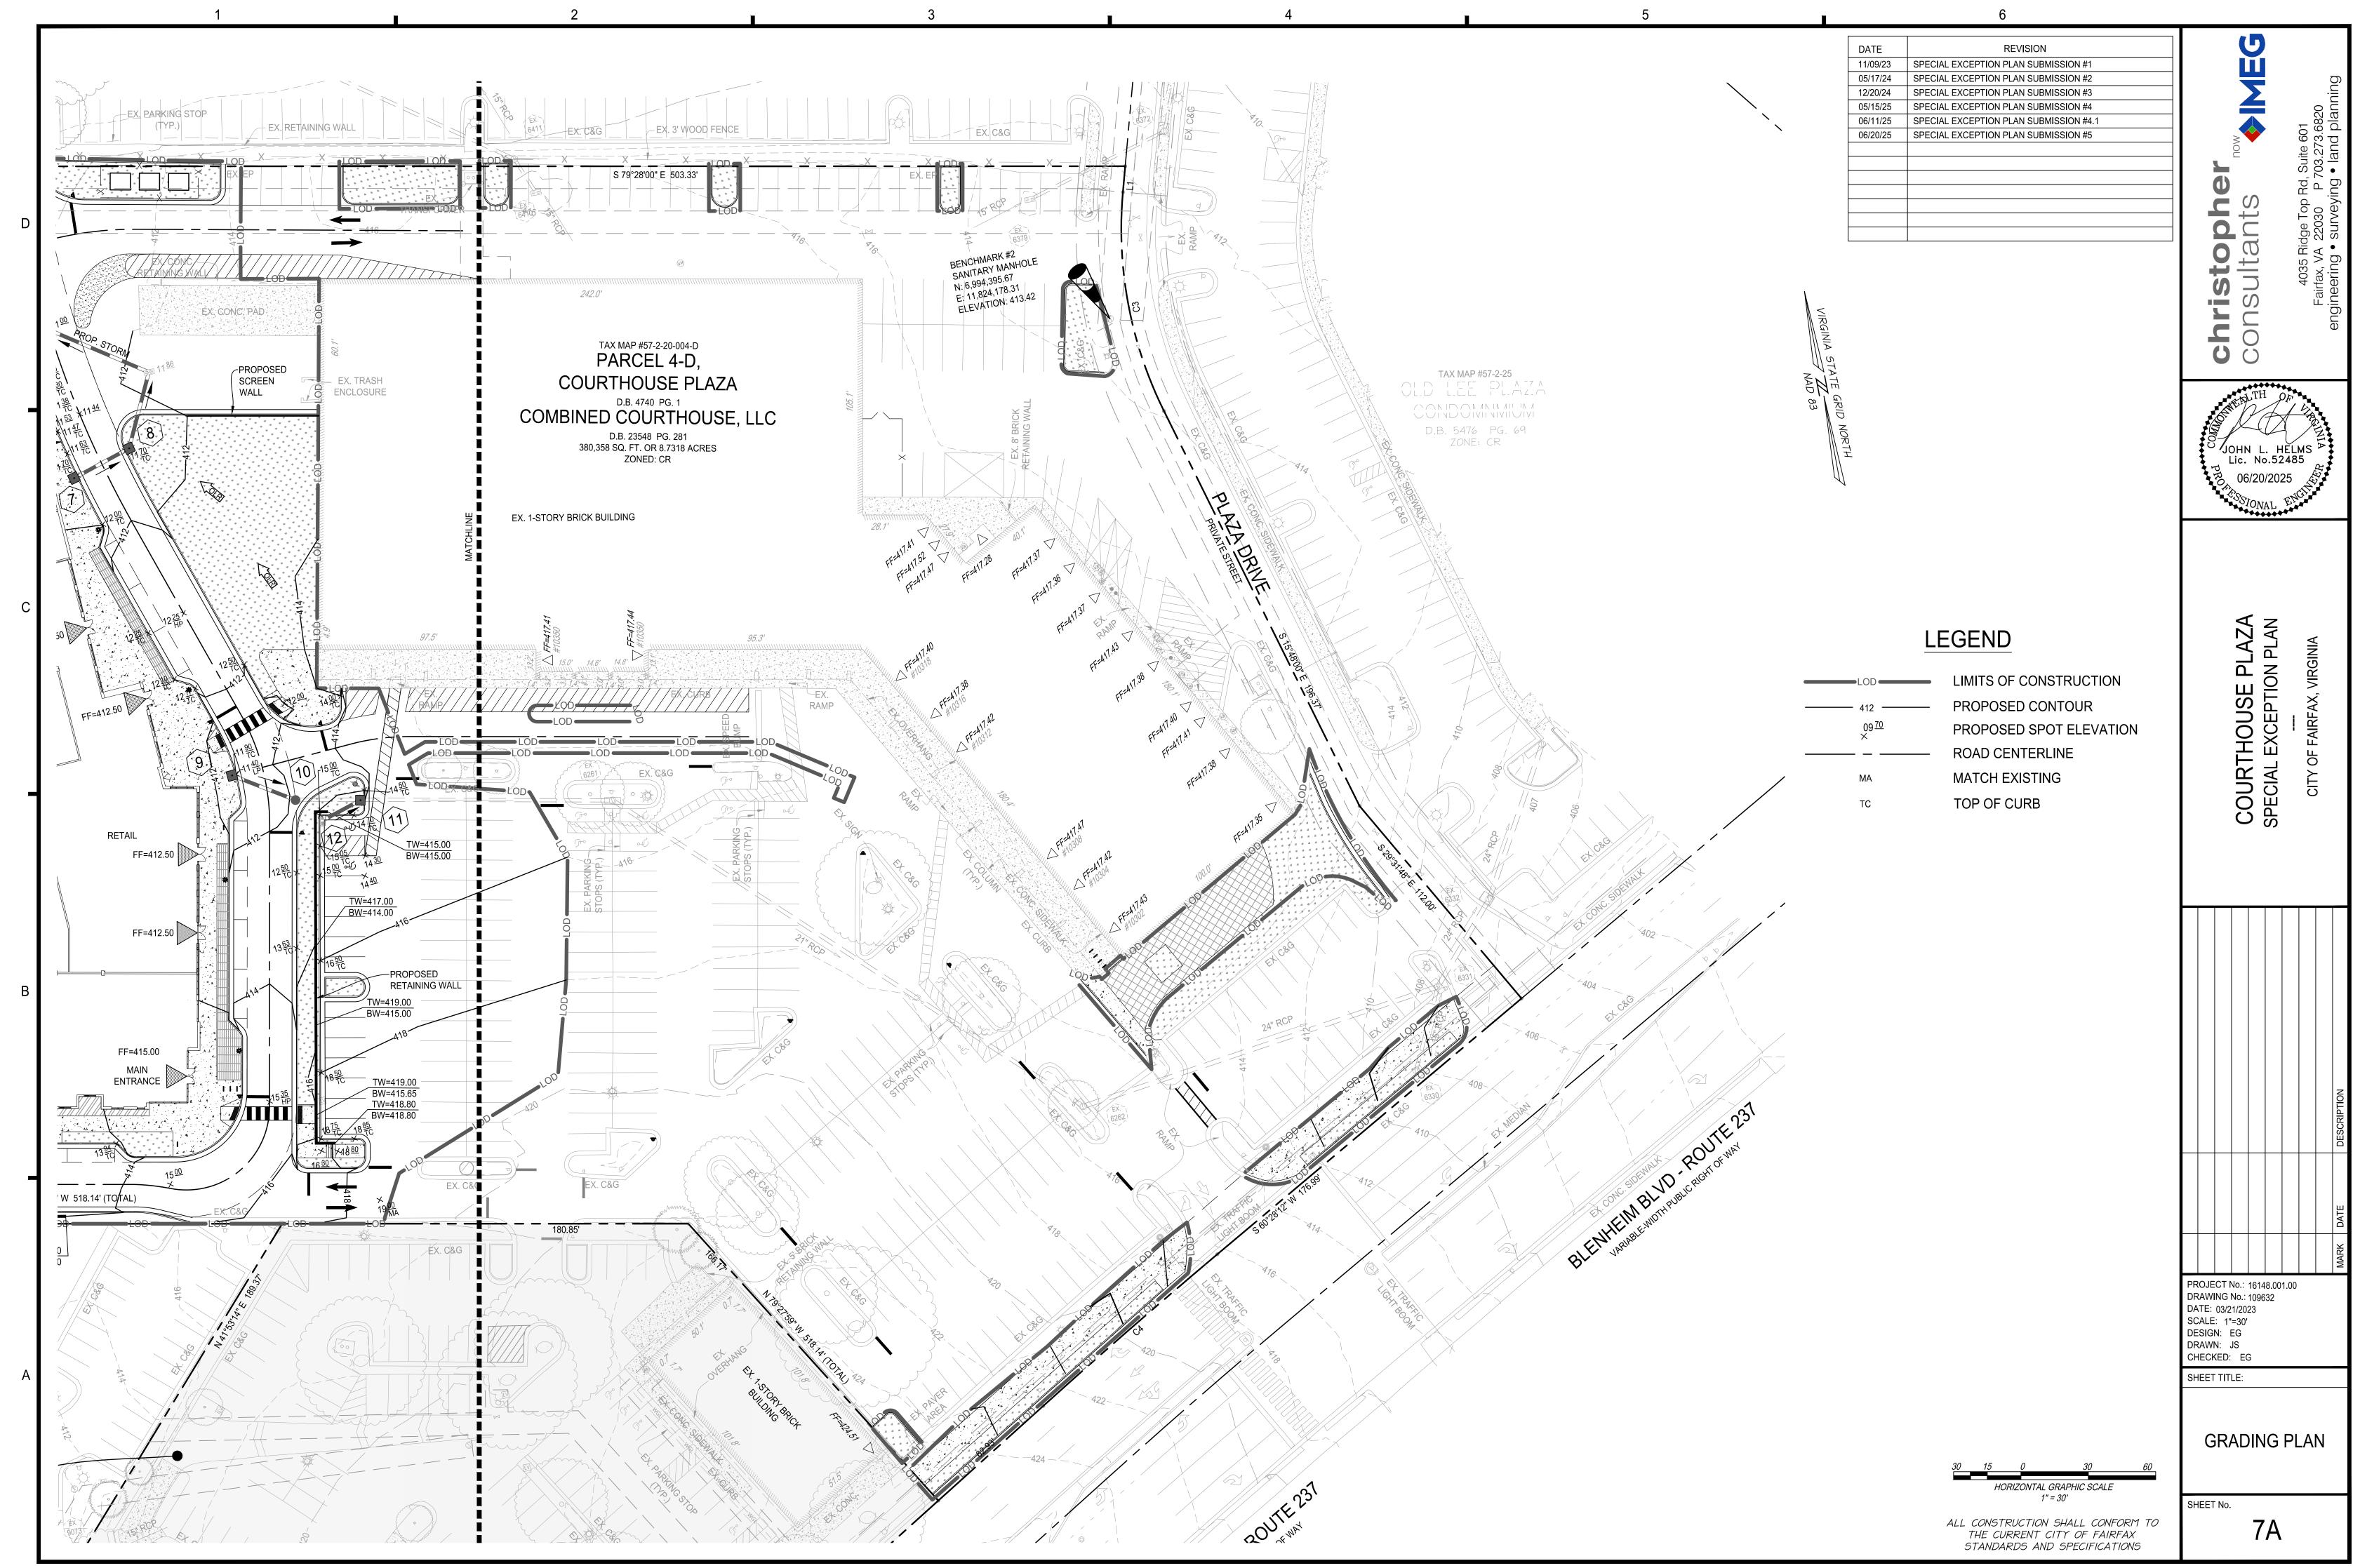

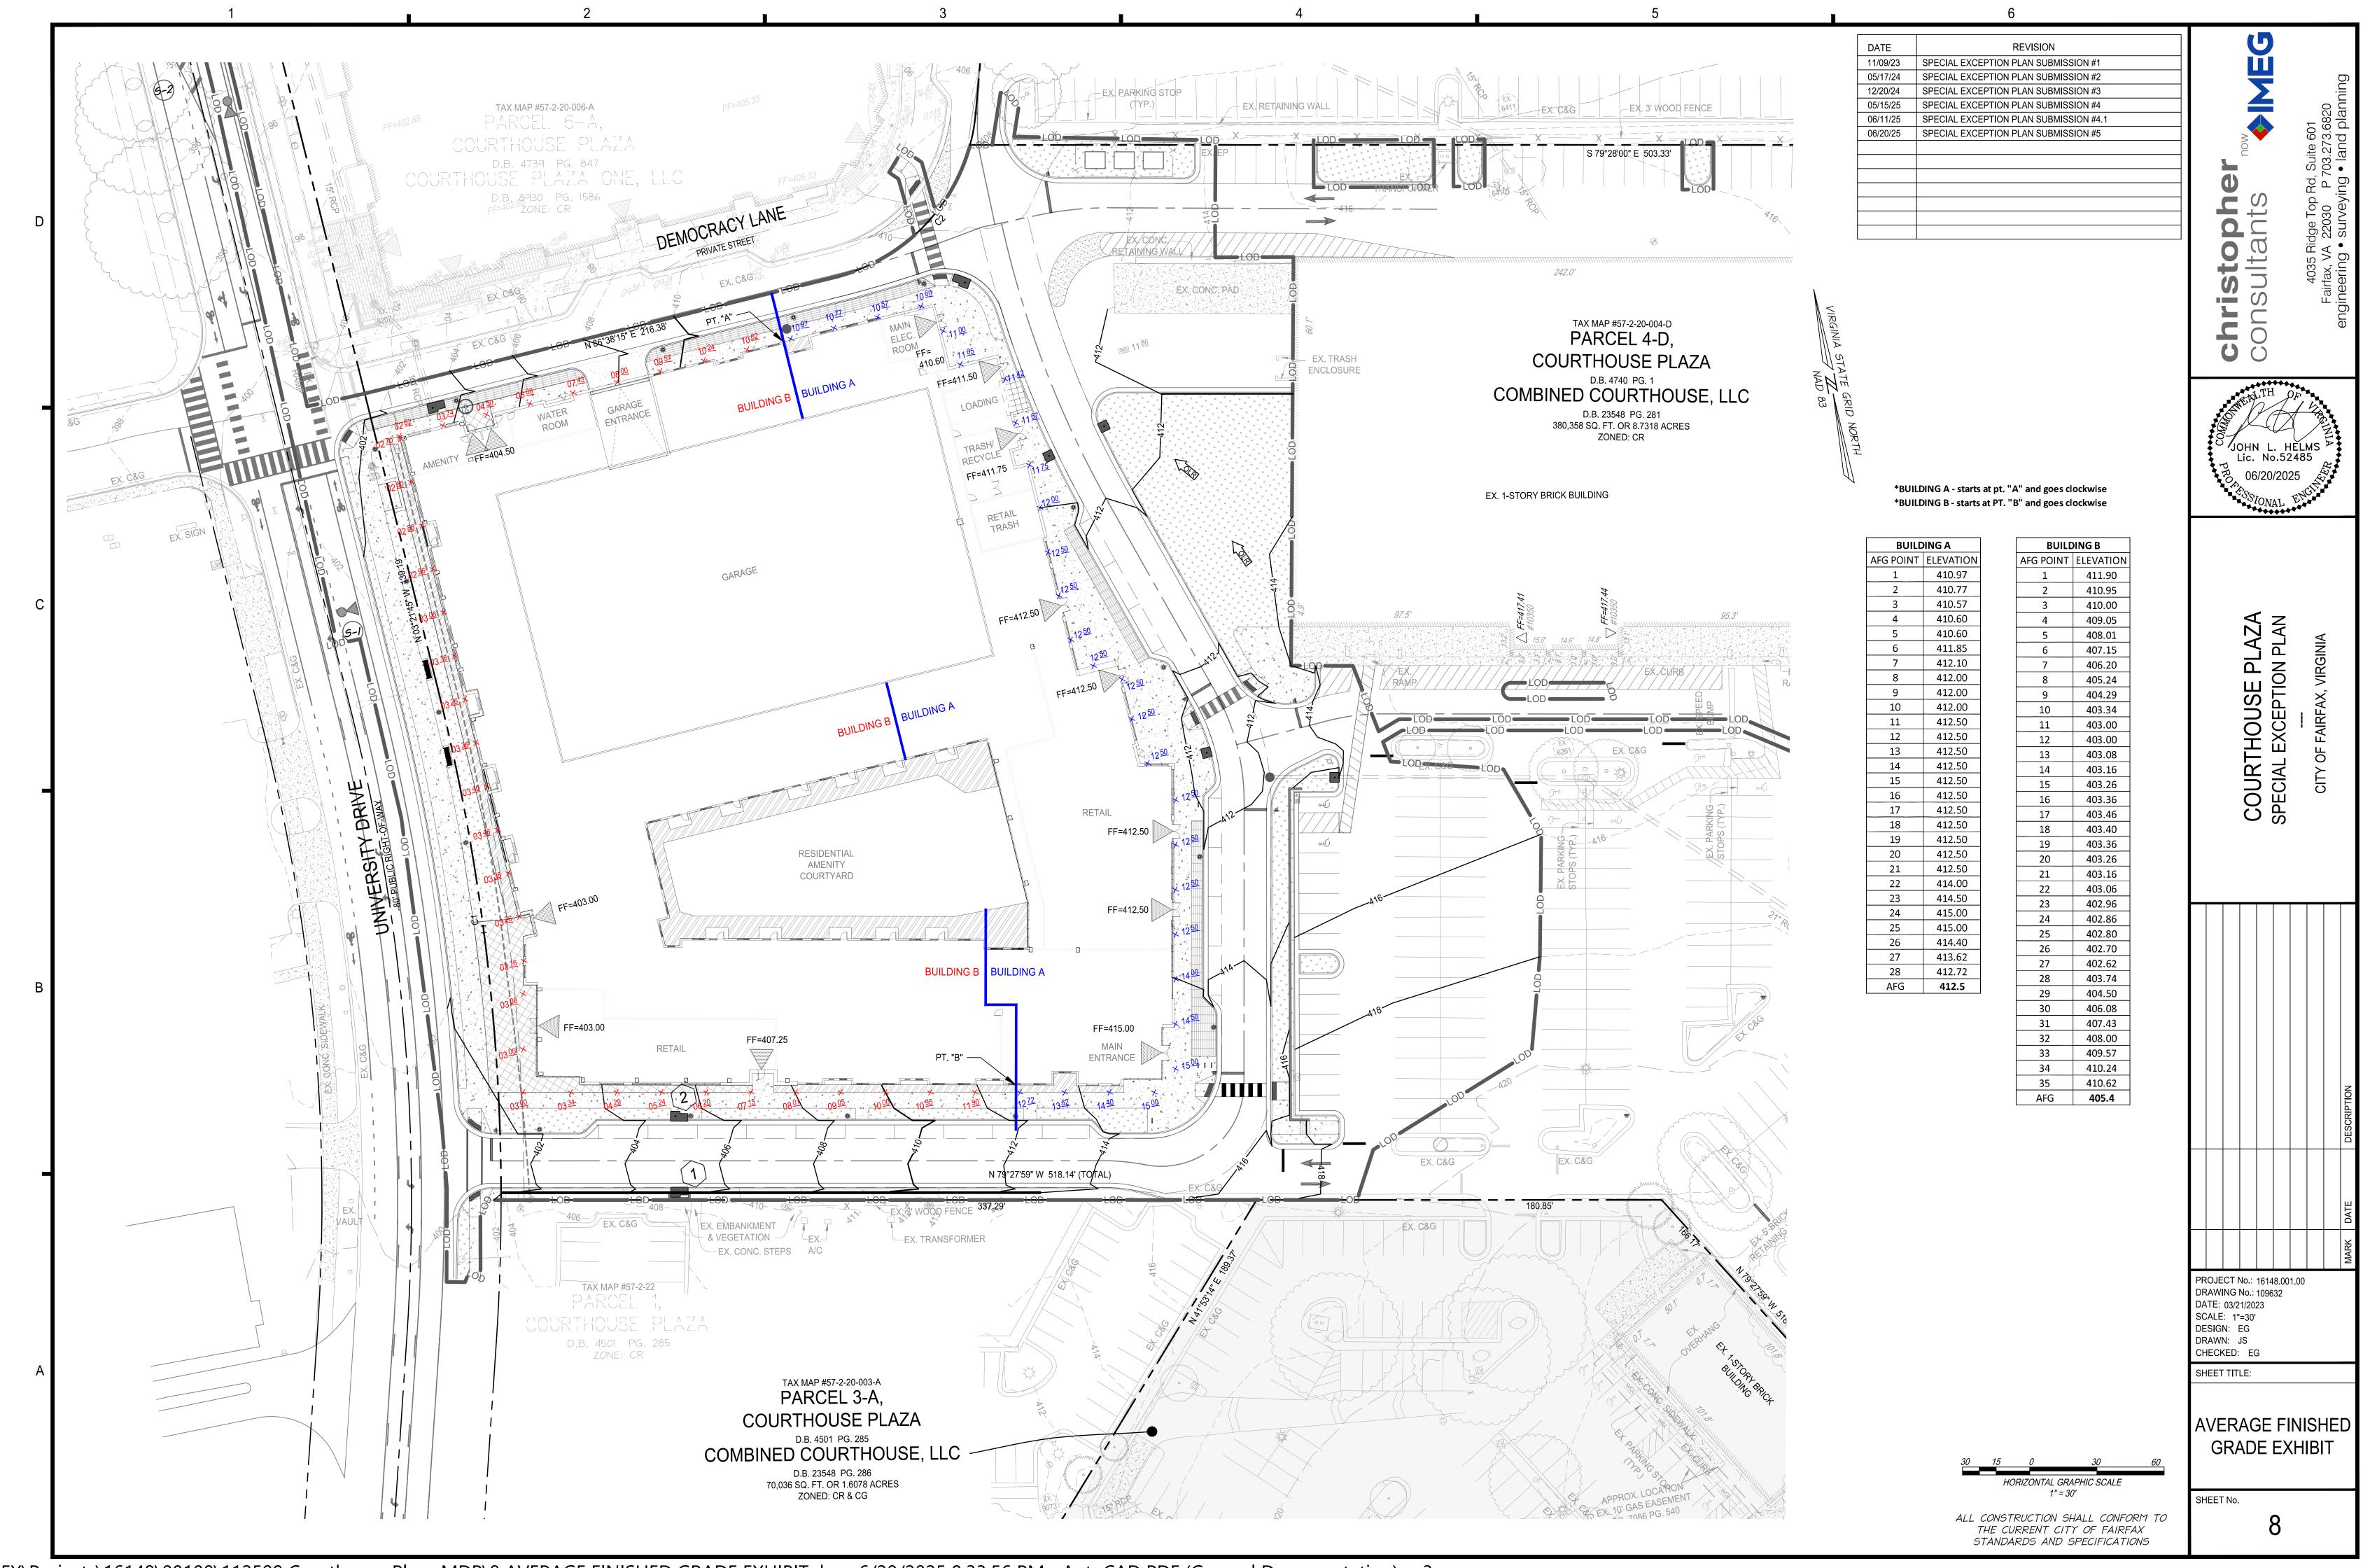

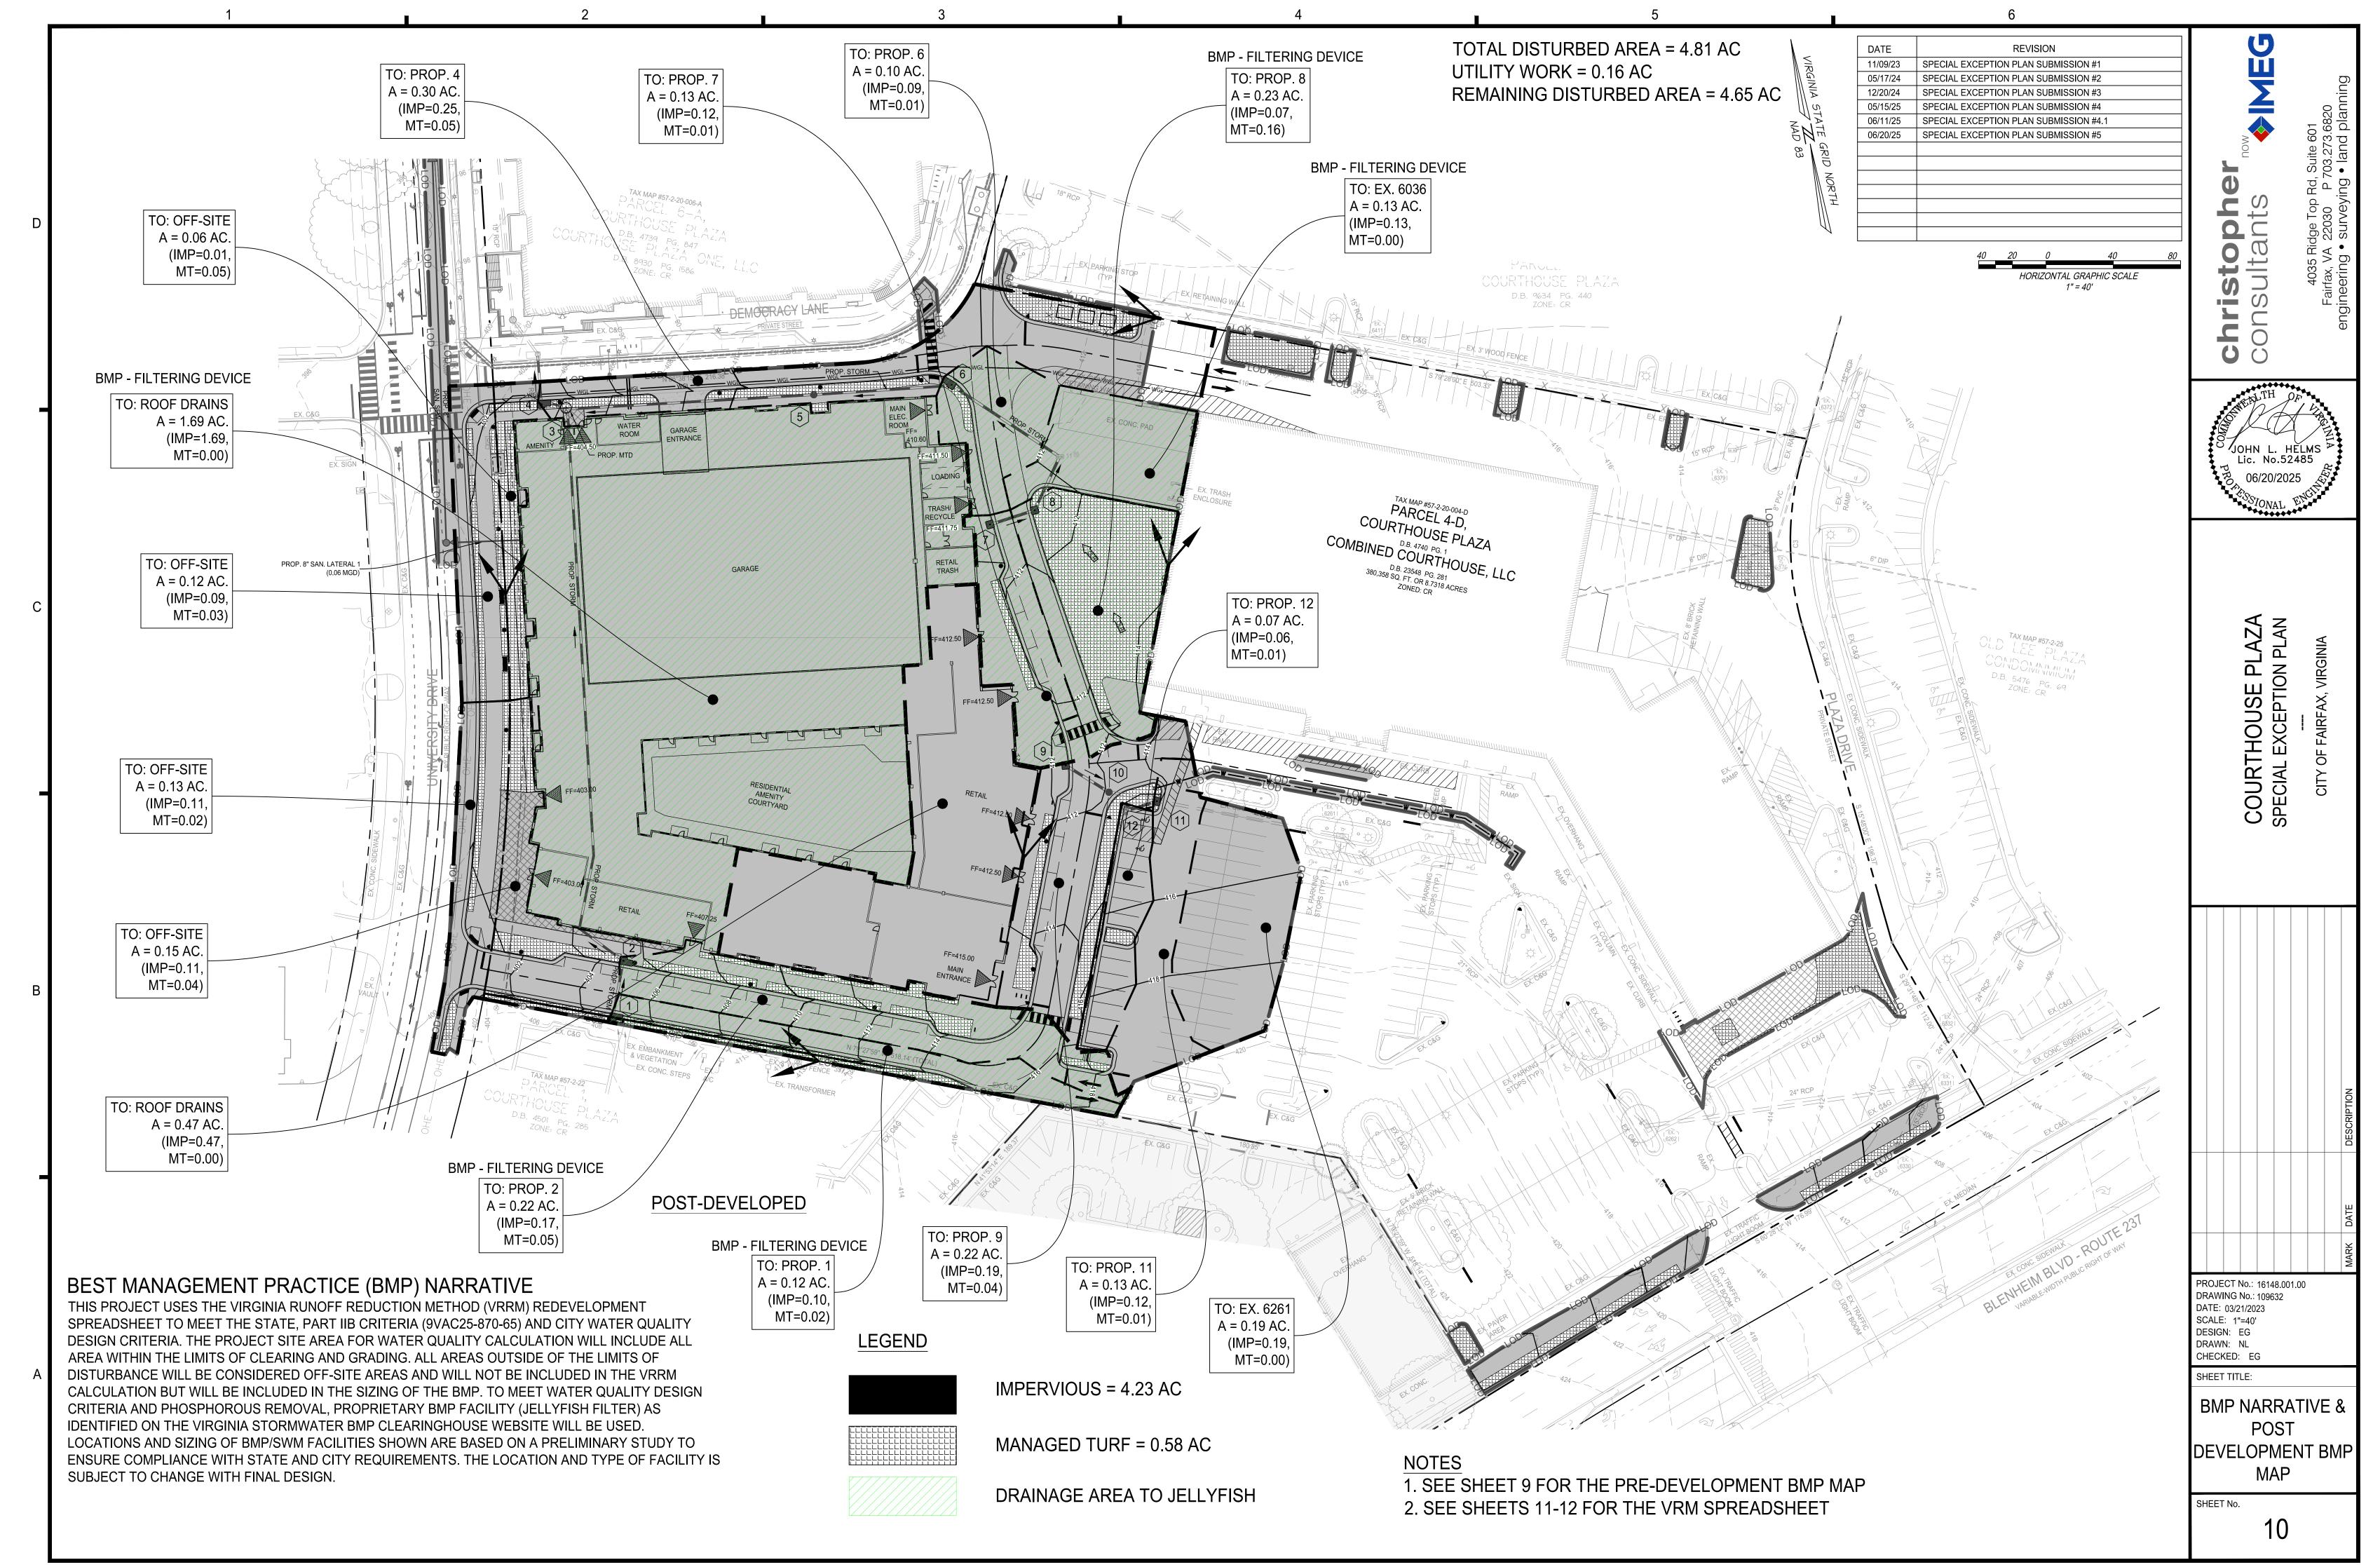

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REVISION DATE Drainage Area A SPECIAL EXCEPTION PLAN SUBMISSION #1 VRRM 4.1, 2024 SPECIAL EXCEPTION PLAN SUBMISSION #2 SPECIAL EXCEPTION PLAN SUBMISSION #3 Drainage Area A Land Cover (acres) SPECIAL EXCEPTION PLAN SUBMISSION #4 SPECIAL EXCEPTION PLAN SUBMISSION #4.1 Composite A Soils **B** Soils C Soils D Soils Totals CLEAR BMP AREAS SPECIAL EXCEPTION PLAN SUBMISSION #5 Loading P **Land Cover Rv** 0.00 0.00 0.00 Forest (acres) 0.00 0.00 0.00 Mixed Open (acres) 0.25 0.85 Managed Turf (acres) 0.58 0.58 Total Phosphorus Available for Removal in D.A. A (lb/yr) 2.82 Impervious Cover (acres) 2.72 0.95 0.86 2.72 9,906 Total 3.30 Post Development Treatment Volume in D.A. A (ft³) Stormwater Best Management Practices (RR = Runoff Reduction) --Select from dropdown lists--**Phosphorus** Untreated Volume from Remaining **Total BMP Phosphorus** Remaining Runoff Mixed Open | Managed Turf **Impervious** Phosphorus **Phosphorus** Downstream Practice to be **Practice** Runoff Volume Reduction **Treatment** Removed By **Credit Area Credit Area Cover Credit** Upstream Removal Phosphorus **Employed** Load to Upstream Credit (%) Practice (ft³) Efficiency (%) Practice (lb) Area (acres) (acres) (acres) Volume (ft³) Load (lb) Practices (lb) Practice (lb) 16. Manufactured Treatment Devices (no RR) 16.b. Manufactured Treatment Device-7,509 7,509 0.18 2.13 0.00 1.98 1.29 0.69 **Filtering** JOHN L. HELMS Lic. No.52485 COURTHOUSE PLAZA SPECIAL EXCEPTION PLAN PROJECT No.: 16148.001.00 DRAWING No.: 109632 DATE: 03/21/2023 SCALE: N/A DESIGN: EG DRAWN: JS CHECKED: EG SHEET TITLE: **ON-SITE VRRM** COMPUTATION

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BMP MAINTENANCE AGREEMENT NOTE:

THE BMP FACILITY IS TO BE PRIVATELY MAINTAINED. THE APPLICANT SHALL EXECUTE A MAINTENANCE SERVICE CONTRACT WITH A PRIVATE CONTRACTOR FOR A MINIMUM OF THREE YEARS. A COPY OF THE CONTRACT SHALL BE PLACED IN THE BMP OPERATION AND MAINTENANCE MANUAL. PRIOR TO ISSUANCE OF THE CERTIFICATE OF OCCUPANCY, A COPY OF THE CONTRACT SHALL BE SUBMITTED TO THE COUNTY. THE APPLICANT SHALL PREPARE AN OWNER'S OPERATION AND MAINTENANCE MANUAL FOR ALL THE BEST MANAGEMENT PRACTICES (BMPS) USED ON SITE. THE MANUAL SHALL INCLUDED AT MINIMUM: AN EXPLANATION OF THE FUNCTIONS AND OPERATIONS OF THE BMP(S); DRAWINGS AND DIAGRAMS OF THE BMP(S) AND ANY SUPPORTING UTILITIES; CATALOG CUTS ON MAINTENANCE REQUIREMENTS; MANUFACTURER CONTACT NAMES AND PHONE NUMBERS; A COPY OF THE EXECUTED MAINTENANCE SERVICE CONTRACT; AND A COPY OF THE MAINTENANCE AGREEMENT WITH THE CITY. PRIOR TO THE ISSUANCE OF THE CERTIFICATE OF OCCUPANCY, A COPY OF THE OPERATION AND MAINTENANCE MANUAL SHALL BE SUBMITTED TO THE CITY ON A DIGITAL MEDIA.

DESIGN PROFESSIONAL INSPECTION NOTE

THE STORMWATER BEST MANAGEMENT PRACTICES (BMPS) REQUIRED FOR THIS PROJECT SHALL BE CONSTRUCTED AND INSTALLED UNDER THE DIRECT SUPERVISION OF THE DESIGN PROFESSIONAL OR HIS DESIGNATED REPRESENTATIVE. PRIOR TO ISSUANCE OF THE CERTIFICATE OF OCCUPANCY, THE DESIGN PROFESSIONAL SHALL SUBMIT A WRITTEN CERTIFICATION TO THE DIRECTOR OF T&ES THAT THE BMPS ARE: A. CONSTRUCTED AND INSTALLED AS DESIGNED AND IN ACCORDANCE WITH THE APPROVED FINAL SITE PLAN.


B. CLEAN AND FREE OF DEBRIS, SOIL, AND LITTER BY EITHER HAVING BEEN INSTALLED OR BROUGHT INTO SERVICE AFTER SITE WAS STABILIZED. C. ALL REPORTING OF SPECIFICATIONS, MATERIAL TESTING, CONSTRUCTION AND INSTALLATION SHALL BE SENT TO THE URBAN FOREST MANAGEMENT DIVISION FOR REVIEW FOR COMPLIANCE WITH PROFFER 00 (ZO-00-000.00)

PROPRIETARY PRODUCT NOTES:


THE CONTRACTOR SHALL CONTACT THE MANUFACTURER AND OBTAIN THE MOST CURRENT SPECIFICATIONS AND INSTALLATION GUIDELINES PRIOR TO INITIATING WORK AND REVIEW CONFORMANCE WITH PLAN SPECIFICATIONS AND GUIDELINES. ANY DISCREPANCIES OR CHANGES SHALL BE BROUGHT TO THE ATTENTION OF ENGINEER OR OWNER FOR NEEDED ACTION. THE CONTRACTOR SHOULD HAVE THE SUPPLIER OVERSEE AND INSPECT THE INSTALLATION OF THE SYSTEM.

IMEG CERTIFIES THAT THIS SHEET SPECIFIES A PRODUCT PRODUCED AND DESIGNED BY OTHERS. THIS PLAN HAS BEEN DESIGNED TO INCORPORATE THE PRODUCT INTO THE SITE DESIGN IN A MANNER CONSISTENT WITH THE INTENDED USE OF THE PRODUCT. SEE PLANS, PROFILES, AND SCHEMATIC DETAILS INCLUDED WITH THIS PLAN FOR SITE SPECIFIC INFORMATION APPLICABLE TO ITS USE ON THIS SITE. THE PRODUCT MANUFACTURER IS RESPONSIBLE FOR PROVIDING CURRENT SPECIFICATIONS FOR THE INSTALLATION AND USE OF THE PRODUCT.

DATE	REVISION
11/09/23	SPECIAL EXCEPTION PLAN SUBMISSION #1
05/17/24	SPECIAL EXCEPTION PLAN SUBMISSION #2
12/20/24	SPECIAL EXCEPTION PLAN SUBMISSION #3
05/15/25	SPECIAL EXCEPTION PLAN SUBMISSION #4
06/11/25	SPECIAL EXCEPTION PLAN SUBMISSION #4.1
06/20/25	SPECIAL EXCEPTION PLAN SUBMISSION #5

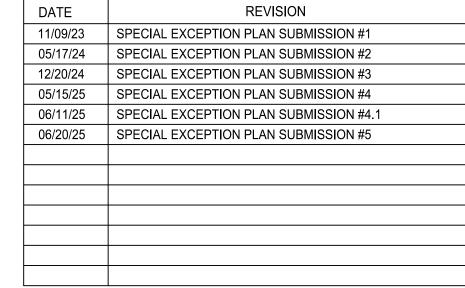



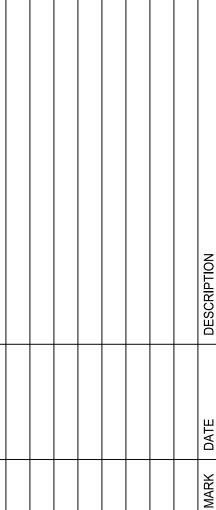

PROJECT No.: 16148.001.00 DRAWING No.: 109632 DATE: 03/21/2023 SCALE: 1"=50' DESIGN: EG


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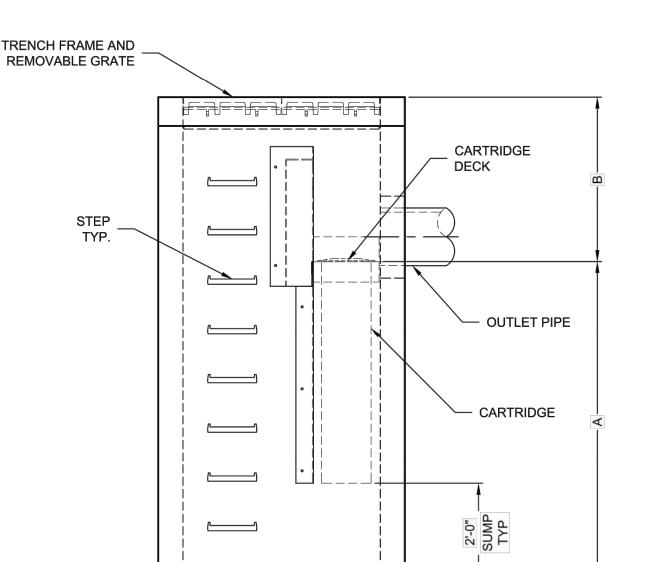
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BMP NOTES &

DETAILS


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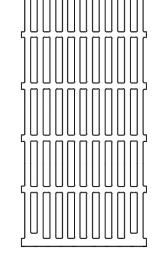





ELEVATION VIEW

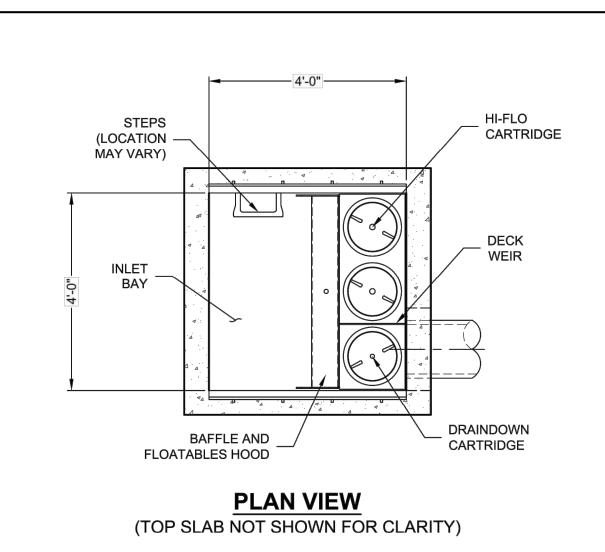JELLYFISH DESIGN NOTES JELLYFISH TREATMENT CAPACITY IS A FUNCTION OF THE CARTRIDGE LENGTH AND THE NUMBER OF CARTRIDGES. THE STANDARD SURFACE INLET STYLE WITH TRENCH GRATE AND COVER IS SHOWN. ALTERNATE CURB INLET OR PIPE INLET OPTIONS ARE AVAILABLE. PEAK CONVEYANCE CAPACITY TO BE DETERMINED BY ENGINEER OF RECORD. CARTRIDGE SELECTION CARTRIDGE LENGTH 40" OUTLET INVERT TO STRUCTURE INVERT (A) 6'-6" 5'-4" 4'-3" 3'-3" FLOW RATE HIGH-FLO / DRAINDOWN (CFS) (PER CART) 0.178 / 0.089 0.133 / 0.067 0.089 / 0.045 0.049 / 0.025 MAX. TREATMENT (CFS) 0.45 0.33 0.12 0.22 OUTLET INVERT TO RIM (MIN) (B) 3'-4" 3'-4"



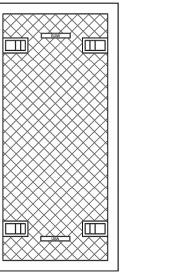

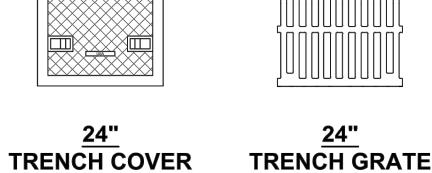

PIPE DATA:	I.E.	MAT'L	DIA	SLOPE	% HGL
INLET #1	*	*	*	*	*
INLET #2	*	*	*	*	*
OUTLET	*	*	*	*	*
SEE GENERAL NOTES 6-7 FOR INLET AND OUTLET HYDRAULIC AND SIZING REQUIREMENTS.					
RIM ELEVATION *					
ANTI-FLOTA	WID.	ГН	HEIGHT		
* *					*
NOTES/SPECIAL REQUIREMENTS:					
* PER ENGINEER OF RECORD					

SITE SPECIFIC

DATA REQUIREMENTS

STRUCTURE ID

PEAK FLOW RATE (cfs)

CARTRIDGE LENGTH

WATER QUALITY FLOW RATE (cfs)

RETURN PERIOD OF PEAK FLOW (yrs) # OF CARTRIDGES REQUIRED (HF / DD)

CONTECH TO PROVIDE ALL MATERIALS UNLESS NOTED OTHERWISE

- 2. FOR SITE SPECIFIC DRAWINGS WITH DETAILED STRUCTURE DIMENSIONS AND WEIGHT, PLEASE CONTACT YOUR CONTECH ENGINEERED SOLUTIONS REPRESENTATIVE. www.ContechES.com
- 3. JELLYFISH WATER QUALITY STRUCTURE SHALL BE IN ACCORDANCE WITH ALL DESIGN DATA AND INFORMATION CONTAINED IN THIS DRAWING. CONTRACTOR TO CONFIRM STRUCTURE MEETS REQUIREMENTS OF PROJECT.
- 4. STRUCTURE SHALL MEET AASHTO HS-20 OR PER APPROVING JURISDICTION REQUIREMENTS, WHICHEVER IS MORE STRINGENT, ASSUMING EARTH COVER OF 0', AND GROUNDWATER ELEVATION AT, OR BELOW, THE OUTLET PIPE INVERT ELEVATION. ENGINEER OF RECORD TO CONFIRM ACTUAL
- GROUNDWATER ELEVATION. CASTINGS SHALL MEET AASHTO M306 LOAD RATING AND BE CAST WITH THE CONTECH LOGO. 5. STRUCTURE SHALL BE PRECAST CONCRETE CONFORMING TO ASTM C-857, ASTM C-918, AND AASHTO LOAD FACTOR DESIGN METHOD.
- 6. OUTLET PIPE INVERT IS EQUAL TO THE CARTRIDGE DECK ELEVATION.
- 7. THE OUTLET PIPE DIAMETER FOR NEW INSTALLATIONS IS RECOMMENDED TO BE ONE PIPE SIZE LARGER THAN THE INLET PIPE (WHERE
- APPLICABLE) AT EQUAL OR GREATER SLOPE. 8. NO PRODUCT SUBSTITUTIONS SHALL BE ACCEPTED UNLESS SUBMITTED 10 DAYS PRIOR TO PROJECT BID DATE, OR AS DIRECTED BY THE
- ENGINEER OF RECORD.


- A. ANY SUB-BASE, BACKFILL DEPTH, AND/OR ANTI-FLOTATION PROVISIONS ARE SITE-SPECIFIC DESIGN CONSIDERATIONS AND SHALL BE SPECIFIED
- B. CONTRACTOR TO PROVIDE EQUIPMENT WITH SUFFICIENT LIFTING AND REACH CAPACITY TO LIFT AND SET THE STRUCTURE. C. CONTRACTOR WILL INSTALL AND LEVEL THE STRUCTURE, SEALING THE JOINTS, LINE ENTRY AND EXIT POINTS (NON-SHRINK GROUT WITH
- APPROVED WATERSTOP OR FLEXIBLE BOOT)
- D. CARTRIDGE INSTALLATION, BY CONTECH, SHALL OCCUR ONLY AFTER SITE HAS BEEN STABILIZED AND THE JELLYFISH UNIT IS CLEAN AND FREE OF DEBRIS. CONTACT CONTECH TO COORDINATE CARTRIDGE INSTALLATION WITH SITE STABILIZATION.



JELLYFISH JFSI0404 STANDARD DETAIL SURFACE INLET CONFIGURATION

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OTHER INTERNATIONAL PATENTS PENDING

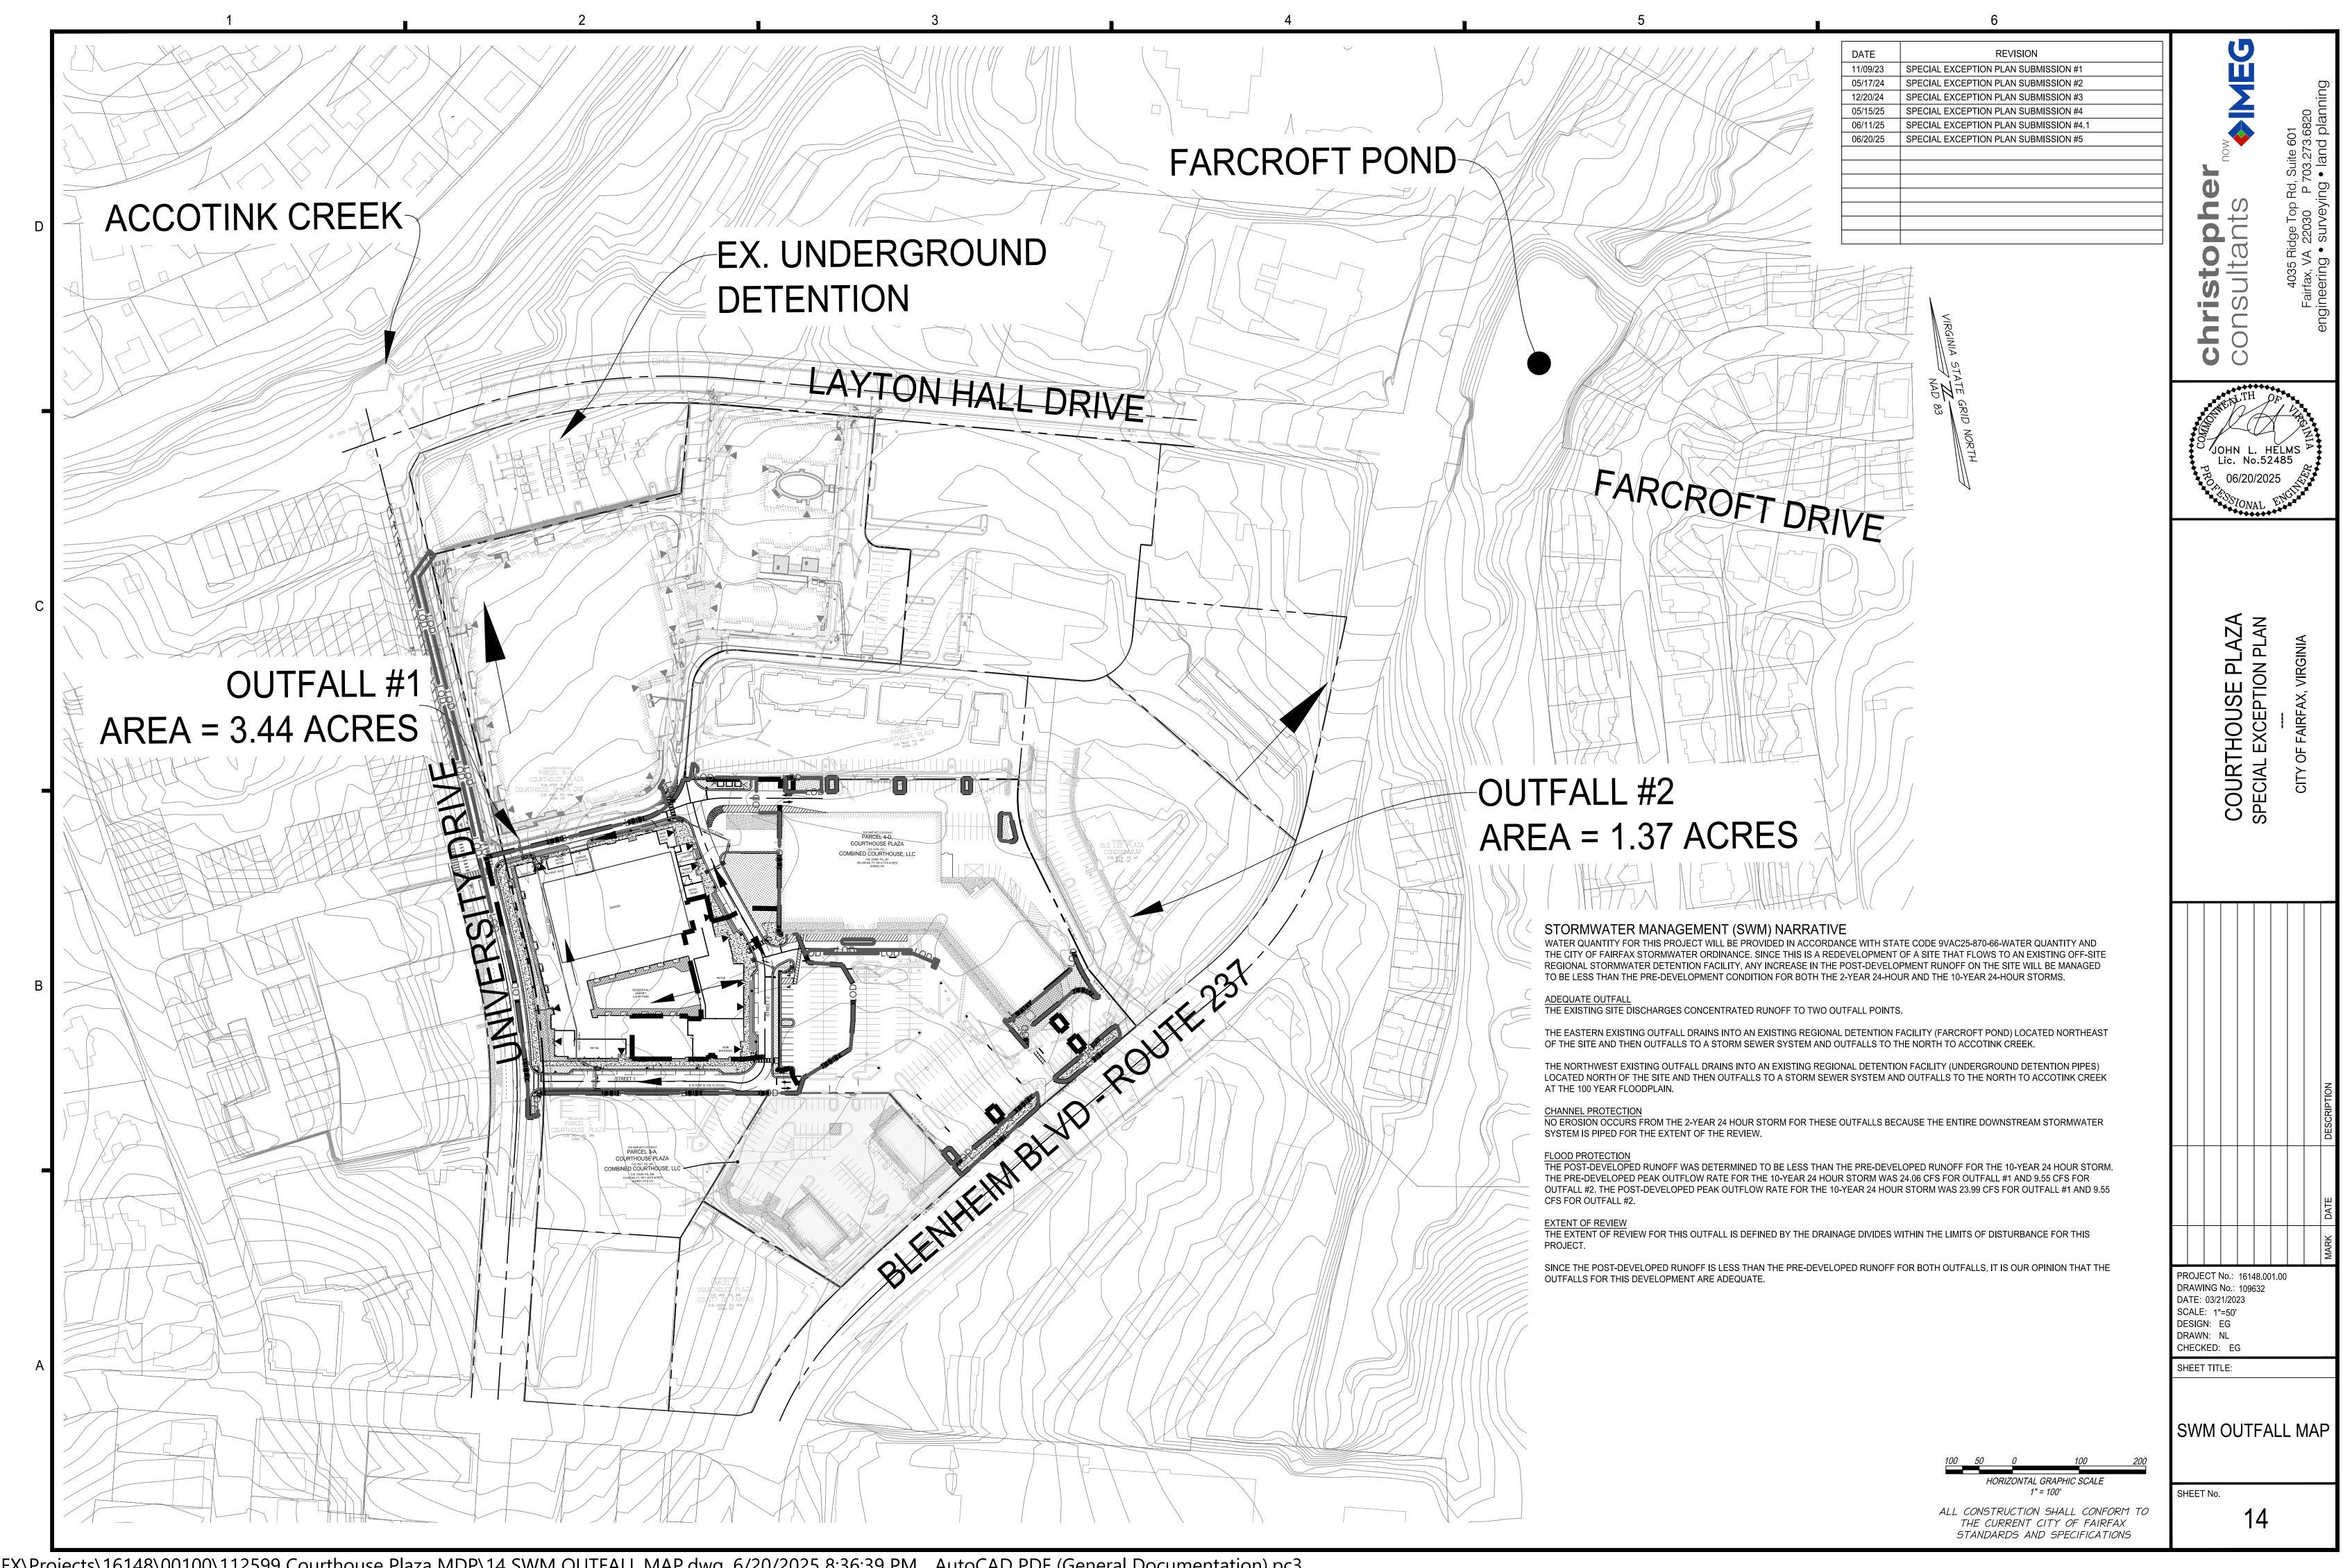

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OUTFALL #1

OUTFALL #1 PRE-DEVELOPMENT

Hyd. No. 1			
Pre-Outfall 1			
Hydrograph type Storm frequency Time interval Drainage area Basin Slope Tc method Total precip. Storm duration	= SCS Runoff = 1 yrs = 2 min = 3.450 ac = 0.0 % = User = 2.70 in = 24 hrs	Peak discharge Time to peak Hyd. volume Curve number Hydraulic length Time of conc. (Tc) Distribution Shape factor	= 12.01 cfs = 11.93 hrs = 26,502 cuft = 96* = 0 ft = 5.00 min = Type II = 484
* Composite (Area/CN) = [(3.04	0 x 98) + (0.410 x 80)] / 3.450		
Hyd. No. 1			
Pre-Outfall 1			
Hydrograph type Storm frequency Time interval Drainage area Basin Slope Tc method Total precip. Storm duration	= SCS Runoff = 2 yrs = 2 min = 3.450 ac = 0.0 % = User = 3.20 in = 24 hrs	Peak discharge Time to peak Hyd. volume Curve number Hydraulic length Time of conc. (Tc) Distribution Shape factor	= 14.44 cfs = 11.93 hrs = 32,277 cuft = 96* = 0 ft = 5.00 min = Type II = 484
* Composite (Area/CN) = [(3.04	0 x 98) + (0.410 x 80)] / 3.450		
Hyd. No. 1 Pre-Outfall 1			
Hydrograph type Storm frequency Time interval Drainage area Basin Slope Tc method Total precip. Storm duration	= SCS Runoff = 10 yrs = 2 min = 3.450 ac = 0.0 % = User = 5.20 in = 24 hrs	Peak discharge Time to peak Hyd. volume Curve number Hydraulic length Time of conc. (Tc) Distribution Shape factor	= 24.06 cfs = 11.93 hrs = 55,550 cuft = 96* = 0 ft = 5.00 min = Type II = 484

OUTFALL #1 POST-DEVELOPMENT

Hyd. No. 3			
Post-Outfall 1			
Hydrograph type Storm frequency Time interval Drainage area Basin Slope Tc method Total precip. Storm duration	= SCS Runoff = 1 yrs = 2 min = 3.440 ac = 0.0 % = User = 2.70 in = 24 hrs	Peak discharge Time to peak Hyd. volume Curve number Hydraulic length Time of conc. (Tc) Distribution Shape factor	= 11.97 cfs = 716 min = 26,425 cuft = 96* = 0 ft = 5.00 min = Type II = 484
* Composite (Area/CN) = [(3.040	0 x 98) + (0.400 x 80)] / 3.440		
Hyd. No. 3			
Post-Outfall 1			
Hydrograph type Storm frequency Time interval Drainage area Basin Slope Tc method Total precip. Storm duration	= SCS Runoff = 2 yrs = 2 min = 3.440 ac = 0.0 % = User = 3.20 in = 24 hrs	Peak discharge Time to peak Hyd. volume Curve number Hydraulic length Time of conc. (Tc) Distribution Shape factor	= 14.40 cfs = 716 min = 32,183 cuft = 96* = 0 ft = 5.00 min = Type II = 484
* Composite (Area/CN) = [(3.040	0 x 98) + (0.400 x 80)] / 3.440		
Hyd. No. 3 Post-Outfall 1			
Hydrograph type Storm frequency Time interval Drainage area Basin Slope Tc method Total precip. Storm duration	= SCS Runoff = 10 yrs = 2 min = 3.440 ac = 0.0 % = User = 5.20 in = 24 hrs	Peak discharge Time to peak Hyd. volume Curve number Hydraulic length Time of conc. (Tc) Distribution Shape factor	= 23.99 cfs = 716 min = 55,389 cuft = 96* = 0 ft = 5.00 min = Type II = 484

OUTFALL #2


OUTFALL #2 PRE-DEVLOPMENT


Hyd. No. 2			
Pre-Outfall 2			
Hydrograph type	= SCS Runoff	Peak discharge	= 4.768 cfs
Storm frequency	= 1 yrs	Time to peak	= 11.93 hrs
Time interval	= 2 min	Hyd. volume	= 10,524 cuft
Drainage area	= 1.370 ac	Curve number	= 96*
Basin Slope	= 0.0 %	Hydraulic length	= 0 ft
Tc method	= User	Time of conc. (Tc)	
Total precip.	= 2.70 in	Distribution	= Type II
Storm duration	= 24 hrs	Shape factor	= 484
* Composite (Area/CN) = [(1.22	0 x 98) + (0.140 x 80)] / 1.370		
Hyd. No. 2			
Pre-Outfall 2			
Hydrograph type	= SCS Runoff	Peak discharge	= 5.733 cfs
Storm frequency	= 2 yrs	Time to peak	= 11.93 hrs
Time interval	= 2 min	Hyd. volume	= 12,817 cuft
Drainage area	= 1.370 ac	Curve number	= 96*
Basin Slope	= 0.0 %	Hydraulic length	= 0 ft
Tc method	= User	Time of conc. (Tc)	
Total precip.	= 3.20 in	Distribution	= Type II
Storm duration	= 24 hrs	Shape factor	= 484
* Composite (Area/CN) = [(1.22	0 x 98) + (0.140 x 80)] / 1.370		
Hyd. No. 2			
Pre-Outfall 2			
Hydrograph type	= SCS Runoff	Peak discharge	= 9.553 cfs
Storm frequency	= 10 yrs	Time to peak	= 11.93 hrs
Time interval	= 2 min	Hyd. volume	= 22,059 cuft
Drainage area	= 1.370 ac	Curve number	= 96*
Basin Slope	= 0.0 %	Hydraulic length	= 0 ft
Tc method	= User	Time of conc. (Tc)	= 5.00 min
Total precip.	= 5.20 in	Distribution	= Type II
Storm duration	= 24 hrs	Shape factor	= 484
e interval nage area in Slope nethod al precip.	= 2 min = 1.370 ac = 0.0 % = User = 5.20 in	Hyd. volume Curve number Hydraulic length Time of conc. (Tc) Distribution	= 22,059 cuft = 96* = 0 ft = 5.00 min = Type II

OUTFALL #2 POST-DEVELOPMENT Hyd. No. 4


* Composite (Area/CN) = [(1.220 x 98) + (0.140 x 80)] / 1.370

Hydrograph type	= SCS Runoff	Peak discharge	= 4.768 cfs
	= 1 yrs	Time to peak	= 716 min
Time interval	= 2 min	Hyd. volume	= 10,524 cuft
Drainage area	= 1.370 ac	Curve number	= 96*
Basin Slope	= 0.0 %	Hydraulic length	= 0 ft
Tc method	= User	Time of conc. (Tc)	
Total precip.	= 2.70 in	Distribution Shape factor	= Type II
Storm duration	= 24 hrs	Shape factor	= 484
* Composite (Area/CN) = [(1.20	0 x 98) + (0.170 x 80)] / 1.370		
Hyd. No. 4			
Post-Outfall 2			
Hydrograph type	= SCS Runoff	Peak discharge	= 5.733 cfs
Storm frequency	= 2 yrs	Time to peak	= 716 min
Time interval	= 2 min	Hyd. volume	= 12,817 cuft
Drainage area	= 1.370 ac	Curve number	= 96*
Drainage area Basin Slope	= 0.0 %	Hydraulic length	
i c metnoa	= User	Time of conc. (Tc)	
Total precip.	= 3.20 in	Distribution	= Type II
Storm duration	= 24 hrs	Shape factor	= 484
* Composite (Area/CN) = [(1.20	0 x 98) + (0.170 x 80)] / 1.370		
Hyd. No. 4			
Post-Outfall 2			
Hydrograph type	= SCS Runoff	Peak discharge	= 9.553 cfs
Storm frequency	= 10 yrs	Time to peak	= 716 min
Time interval	= 2 min	Hyd. volume	= 22,059 cuft
Drainage area	= 1.370 ac	Curve number	= 96*
Basin Slope	= 0.0 %	Hydraulic length	= 0 ft
Tc method	= User	Time of conc. (Tc)	= 5.00 min
Total precip. Storm duration	= 5.20 in	Distribution	= Type II
	= 24 hrs	Shape factor	= 484

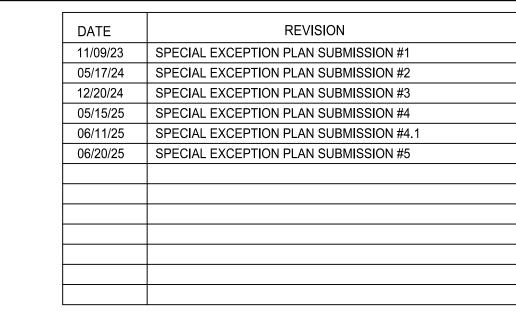

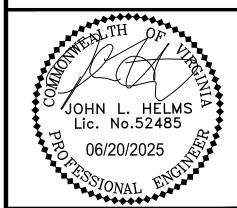


COURTHOUSE PLAZA SPECIAL EXCEPTION PLAN

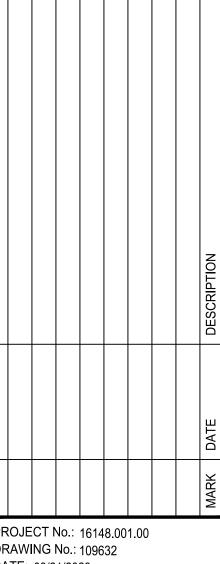

PROJECT No.: 16148.001.00 DRAWING No.: 109632 DATE: 03/21/2023 SCALE: 1"=50' DESIGN: EG DRAWN: NL CHECKED: EG


SHEET TITLE:

PRE AND POST HYDROGRAPHS

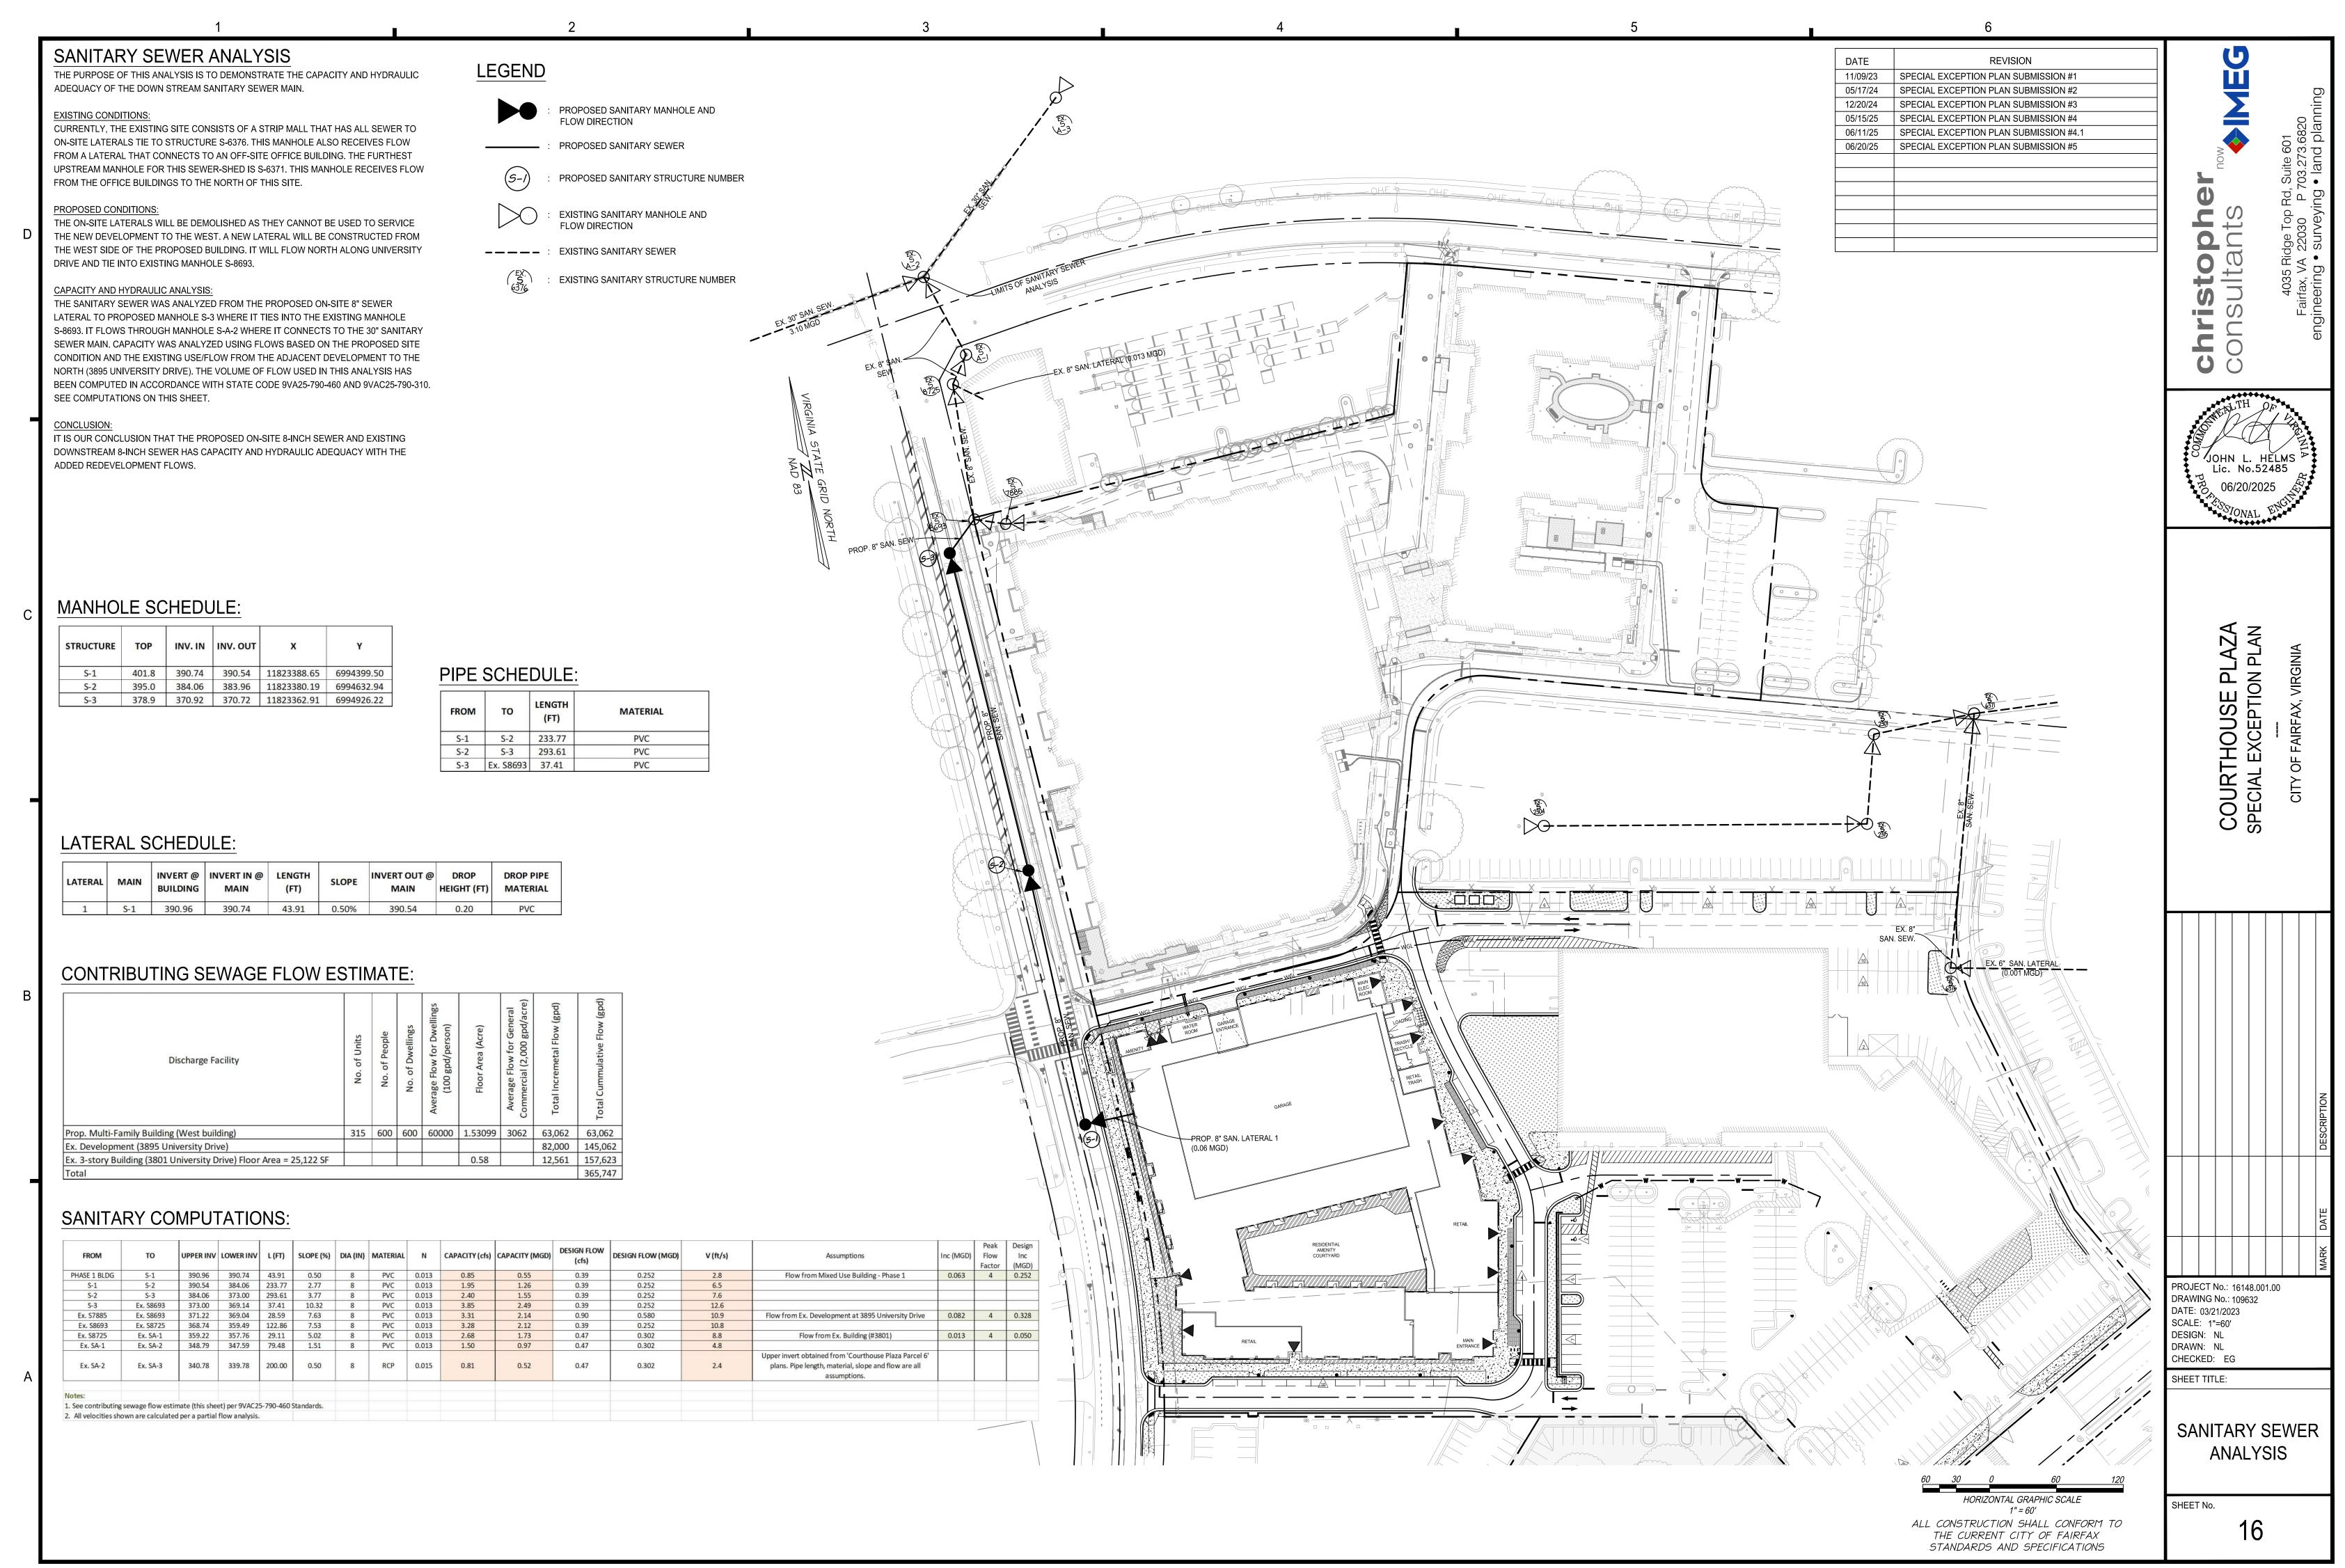



REVISION SPECIAL EXCEPTION PLAN SUBMISSION #1 THIS SHEET IS FOR INFORMATIONAL PURPOSES ONLY! SPECIAL EXCEPTION PLAN SUBMISSION #2 SPECIAL EXCEPTION PLAN SUBMISSION #3 SPECIAL EXCEPTION PLAN SUBMISSION #4 SPECIAL EXCEPTION PLAN SUBMISSION #4.1 SPECIAL EXCEPTION PLAN SUBMISSION #5 TOTAL DISTURBED = 6.13 Ac. OR 267,022 SF **REVISION** ALL CONSTRUCTION SHALL CONFORM TO 12-04-19 FSP #1 CERTIFICATION NOTE: THE CURRENT FAIRFAX CITY AND VIRGINIA 04-10-19 FSP #2 DEPARTMENT OF TRANSPORTATION 04-18-19 FCWA #2 THE APPLICANT SHALL PROVIDE CERTIFICATIONS PER PFM SECTION 5.3.3.5-A THROUGH 5.3.3.5-J. STANDARDS AND SPECIFICATIONS -07-19 BUILDING PERMIT REV. I **LEGEND** 2-25-20 SIGNATURE SET : PROPOSED SANITARY MANHOLE AND FLOW DIRECTION PROPOSED SANITARY STRUCTURE NUMBER SANITARY SEWER ANALYSIS ---- : EX. SANITARY SEWER THE PURPOSE OF THIS ANALYSIS IS TO DEMONSTRATE THE CAPACITY AND HYDRAULIC ADEQUACY OF THE DOWN STREAM SANITARY SEWER MAIN. 3.10 MGD EX. SANITARY STRUCTURE NUMBER (SEE SHEET CI6.2 FOR FLOW CURRENTLY, THE EXISTING SITE CONSISTS OF 6 SMALL OFFICE BUILDINGS THAT ALL SEWER TO ON-SITE LATERALS THAT TIE TO STRUCTURE S-8693. THIS <u>ANALYSIS OF EXISTING 30" SEWER:</u> MANHOLE IS THE FURTHEST UPSTREAM FOR THIS THE ANALYSIS OF THE THIS EXISTING SEWER 7, COURTHOUSE PLAZA SEWER-SHED AND NO OTHER BUILDINGS/DEVELOPMENTS IS SHOWN FOR INFORMATIONAL PURPOSES ONLY. TIE INTO THIS MANHOLE. FROM THIS MANHOLE, THE THE FLOW ASSUMPTIONS ARE BASED ON SAN. SEW. 8-INCH SEWER FLOWS TO THE NORTH TO A 30-INCH D.B. 4501 PG. 285 DOCTORS INVESTMENT GROUP, LLC ! CALCULATIONS FROM THE 'PAUL VI' PLAN. SEWER MAIN. THE ONLY OTHER CONTRIBUTING FLOWS PLAZA ON PLAN REFER TO SHEET CI6.2 FOR SEWER FLOWS AND ARE FROM THE 3801 UNIVERSITY DRIVE BUILDING. AREA. THE FLOWS FROM THE AREAS DENOTED D.B. 22024 PG. 2167 AS 'NORTH' AND 'SOUTH' WERE ESTIMATED EX. 8" SAN. LATERAL BASED ON SIZE OF THE SEWER SHED AS A (0.013 MGD) THE ON-SITE LATERALS WILL BE DEMOLISHED TO MAKE RATIO TO THE FLOW CALCULATED FOR THE ROOM FOR THE NEW BUILDING. NEW LATERALS WILL BE CONSTRUCTED ALONG THE NORTH OF THE BUILDING FLOWING EAST TO WEST AND TIE TO THE EXISTING COURTHOUSE PECIAL EXCEPTION #3801 (POSTED) - PAUL VI - 2.16 MGD - 322 Ac. EX. 3 STORY STRUCTURE 5-8693. - NORTH - 0.40 MGD - 60 Ac. PROP. 8" SAN. LATERAL I BRICK BUILDING - SOUTH - 0.54 MGD - 80 Ac. CAPACITY AND HYDRAULIC ANALYSIS: ±9,725 SQ. FT. THE SANITARY SEWER WAS ANALYZED FROM THE ON-SITE THE SLOPE AND PIPE MATERIALS ASSUMED 8" SEWER TO EXISTING MANHOLE S-8693 AND THEN TO FOR THE SEWER WERE WORST CASE SCENARIO, THE NORTH ALONG UNIVERSITY DRIVE (8-INCH SEWER) TO र्भ 02/28/2020 A REINFORCED CONCRETE PIPE AT 0.50%. MANHOLE 5-A-2, WHERE IT CONNECTS TO THE 30-INCH SEWER MAIN. CAPACITY WAS ANALYZED USING FLOWS REFER TO THE SANITARY SEWER CALCULATION BASED ON THE PROPOSED SITE CONDITION AND THE SHOWN BELOW FOR EX. A-2 TO EX. A-3 FOR EXISTING USE/FLOW FROM THE ADJACENT BUILDING TO THE NORTH (3801 UNIVERSITY DRIVE). THE VOLUME OF FLOW USED IN THIS ANALYSIS HAS BEEN COMPUTED IN ACCORDANCE WITH STATE CODE 9VAC25-790-460 AND 8-INCH SEWER AND EXISTING DOWNSTREAM 8-INCH SEWER HAS CAPACITY AND HYDRAULIC ADEQUACY WITH THE PROP. APARTMENT (EAST BUILDING) SANITARY PIPE SCHEDULE: LATERAL SCHEDULE: PROP. APARTMENT (WEST BUILDING) S-3 S-2 140.47 PVC C 900 DR 25 S-2 S-1 88.03 PVC C 900 DR 25 SANITARY MANHOLE SCHEDULE: PROP. 6" DOMESTIC SERVICE-CONTRIBUTING SEWAGE FLOW ESTIMATE: INV OF LATERAL 382.00 | 11823794.9871 | 6994961.9258 INV OF LATERAL 393.50 379.45 379.35 11823678.8608 6994961.8241 392.17 376.25 376.00 11823538.7958 6994951.5356 COURTHOUSE 382.43 374.05 373.55 11823452.0530 6994938.5996 Ex. S7885 381.56 371.75 371.22 11823417.0545 6994942.8386 Ex. S8693 377.89 369.04 368.74 11823389.9833 6994952.0310 SANITARY COMPUTATION **DESIGN FLOW** PROJECT No.: 16148.001.00 V (ft/s) **DRAWING No.: 109632** DATE: 03/21/2023 SCALE: 1"=60' DESIGN: EG DRAWN: JS CHECKED: EG 0.328 SCALE: SEE DWGS. 0.380 Flow from Existing Building (#3801 SHEET TITLE: 347.59 79.48 1.51 8 0.97 0.59 0.380 02-04-2019 per invert obtained from 'Courthouse Plaza Parcel 6' plans. Pipe length, material, slope and flow are all 340.78 339.78 200.00 0.50 30 2.317 SANITARY SEWER assumptions. Refer to sheet C16.2 for flow CHECKED: KMW **ANALYSIS** 1. See contributing sewage flow estimate (this sheet) per 9VAC25-790-460 Standards. 2. All velocities shown are calculated per a partial flow analysis. C16.1 3. GSF of existing 3801 University Drive building is per approved plan called 'Courthouse Plaza - Parcel 7'. 16A


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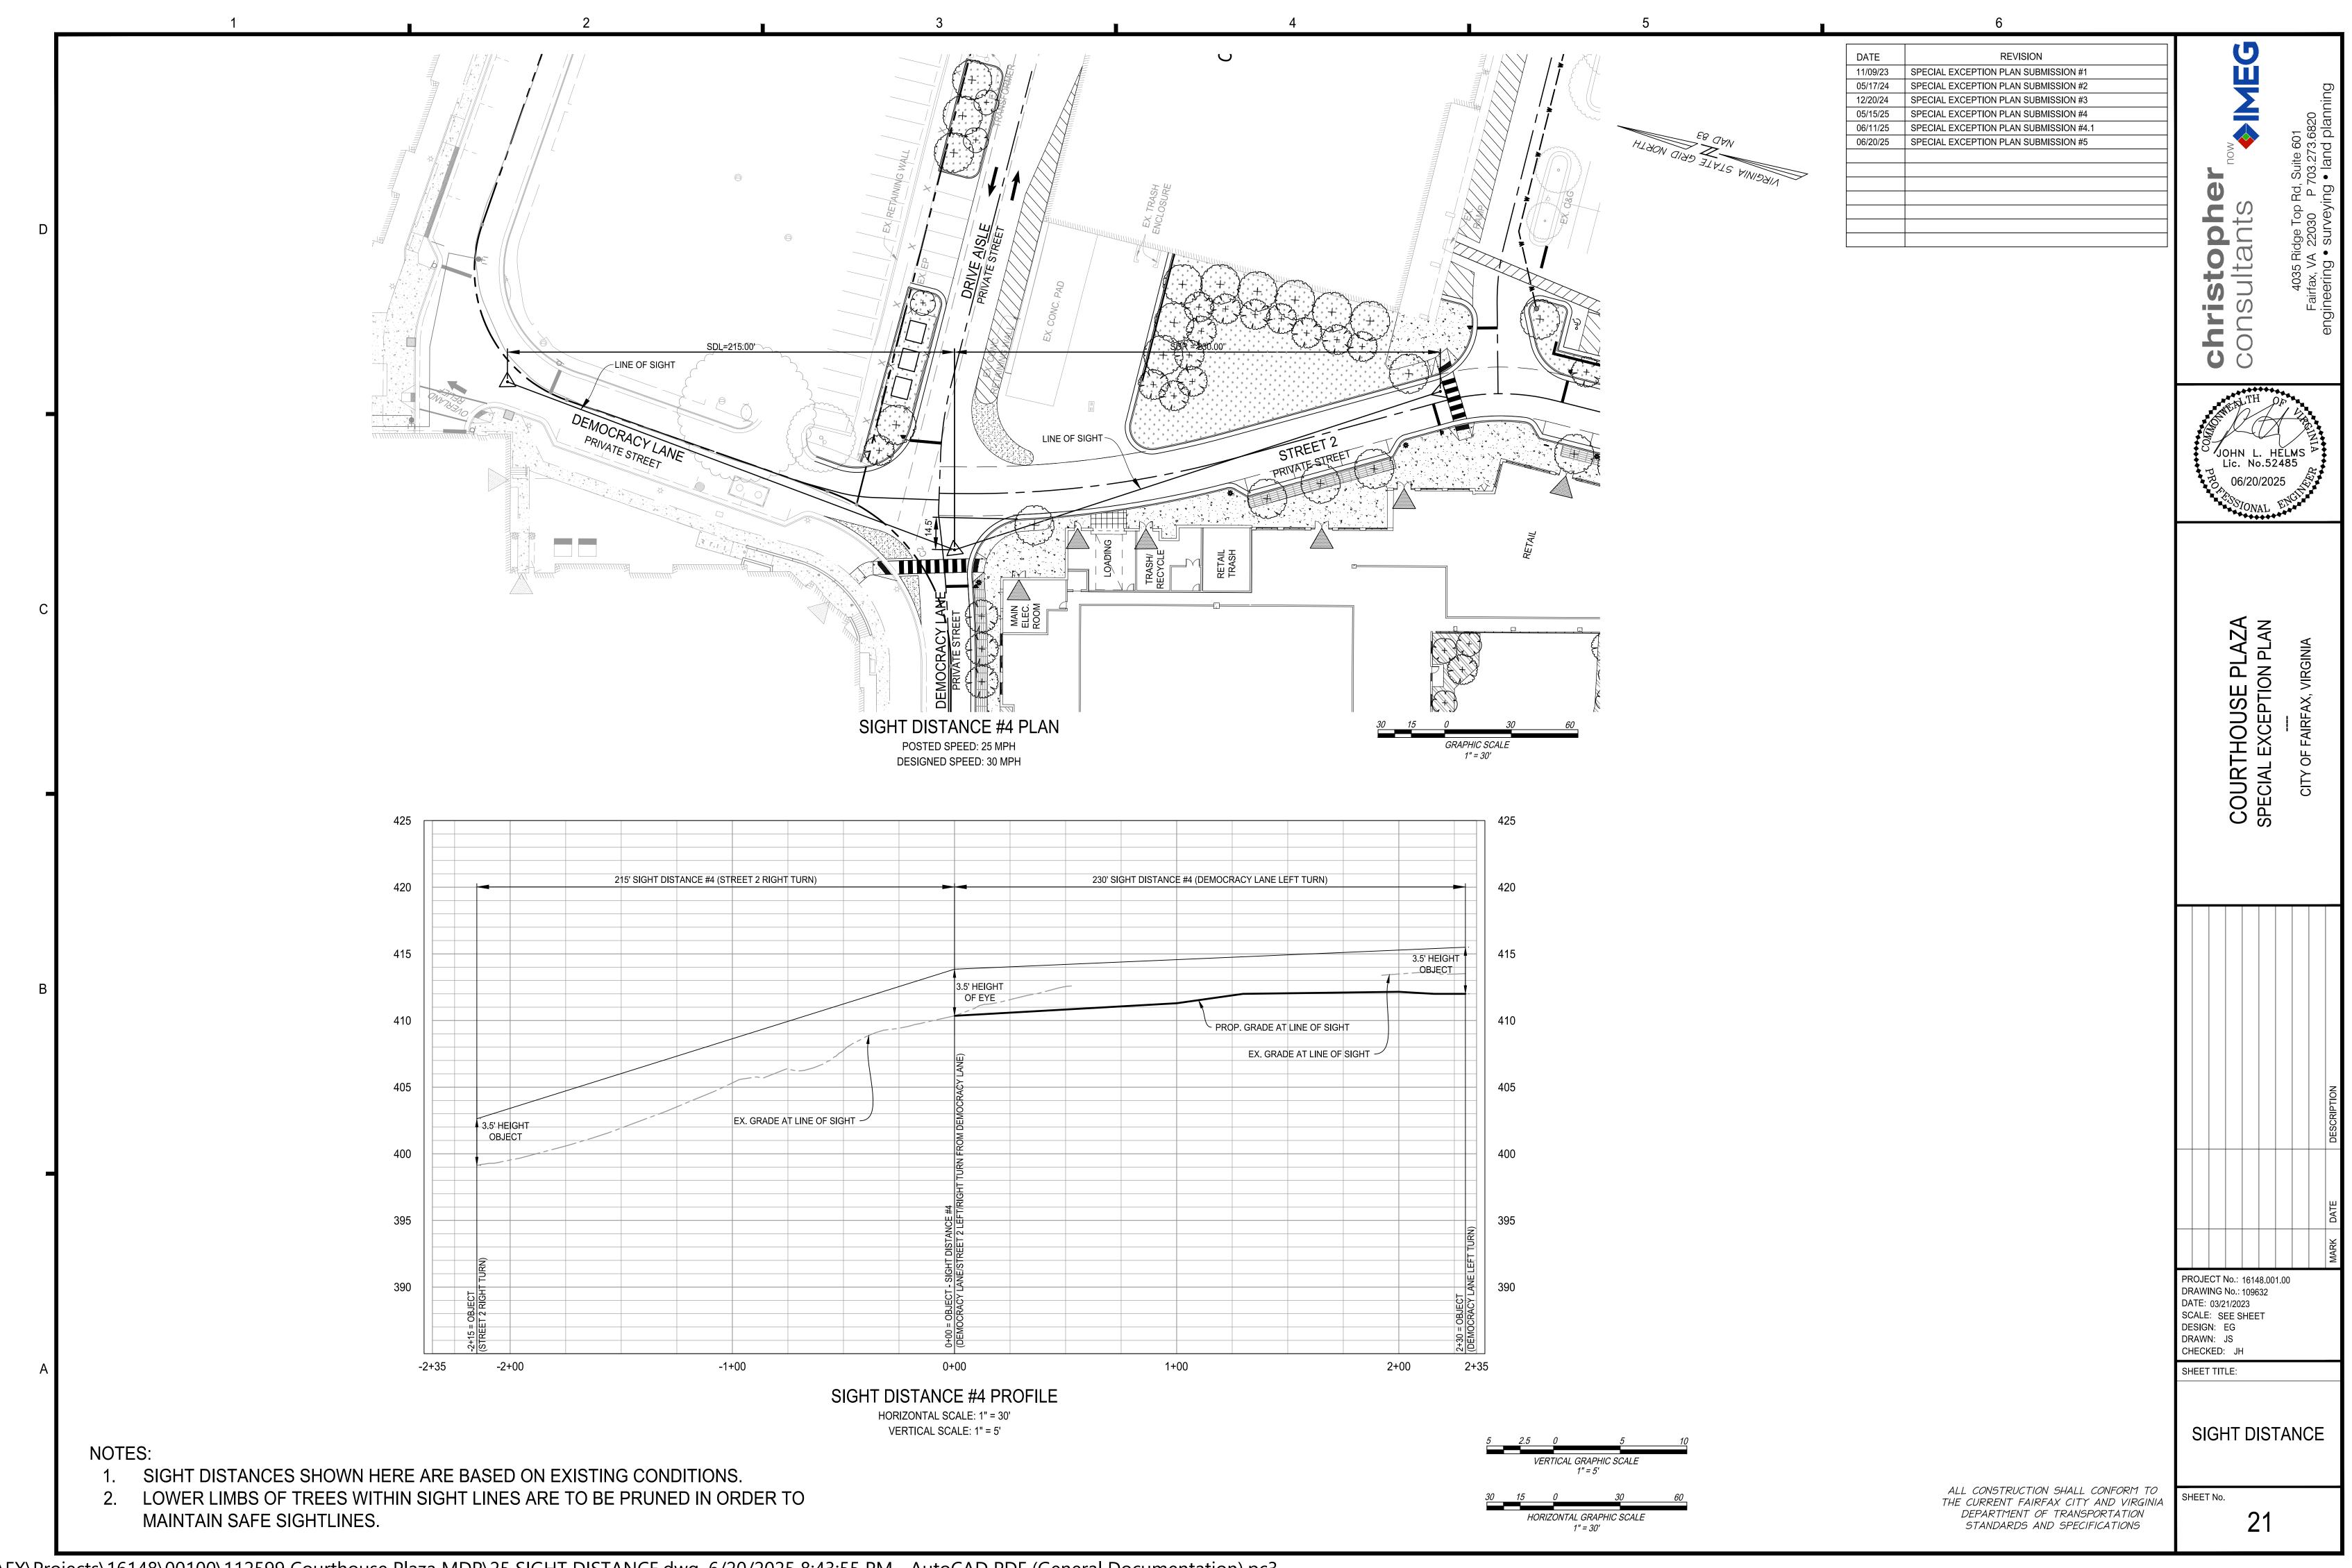


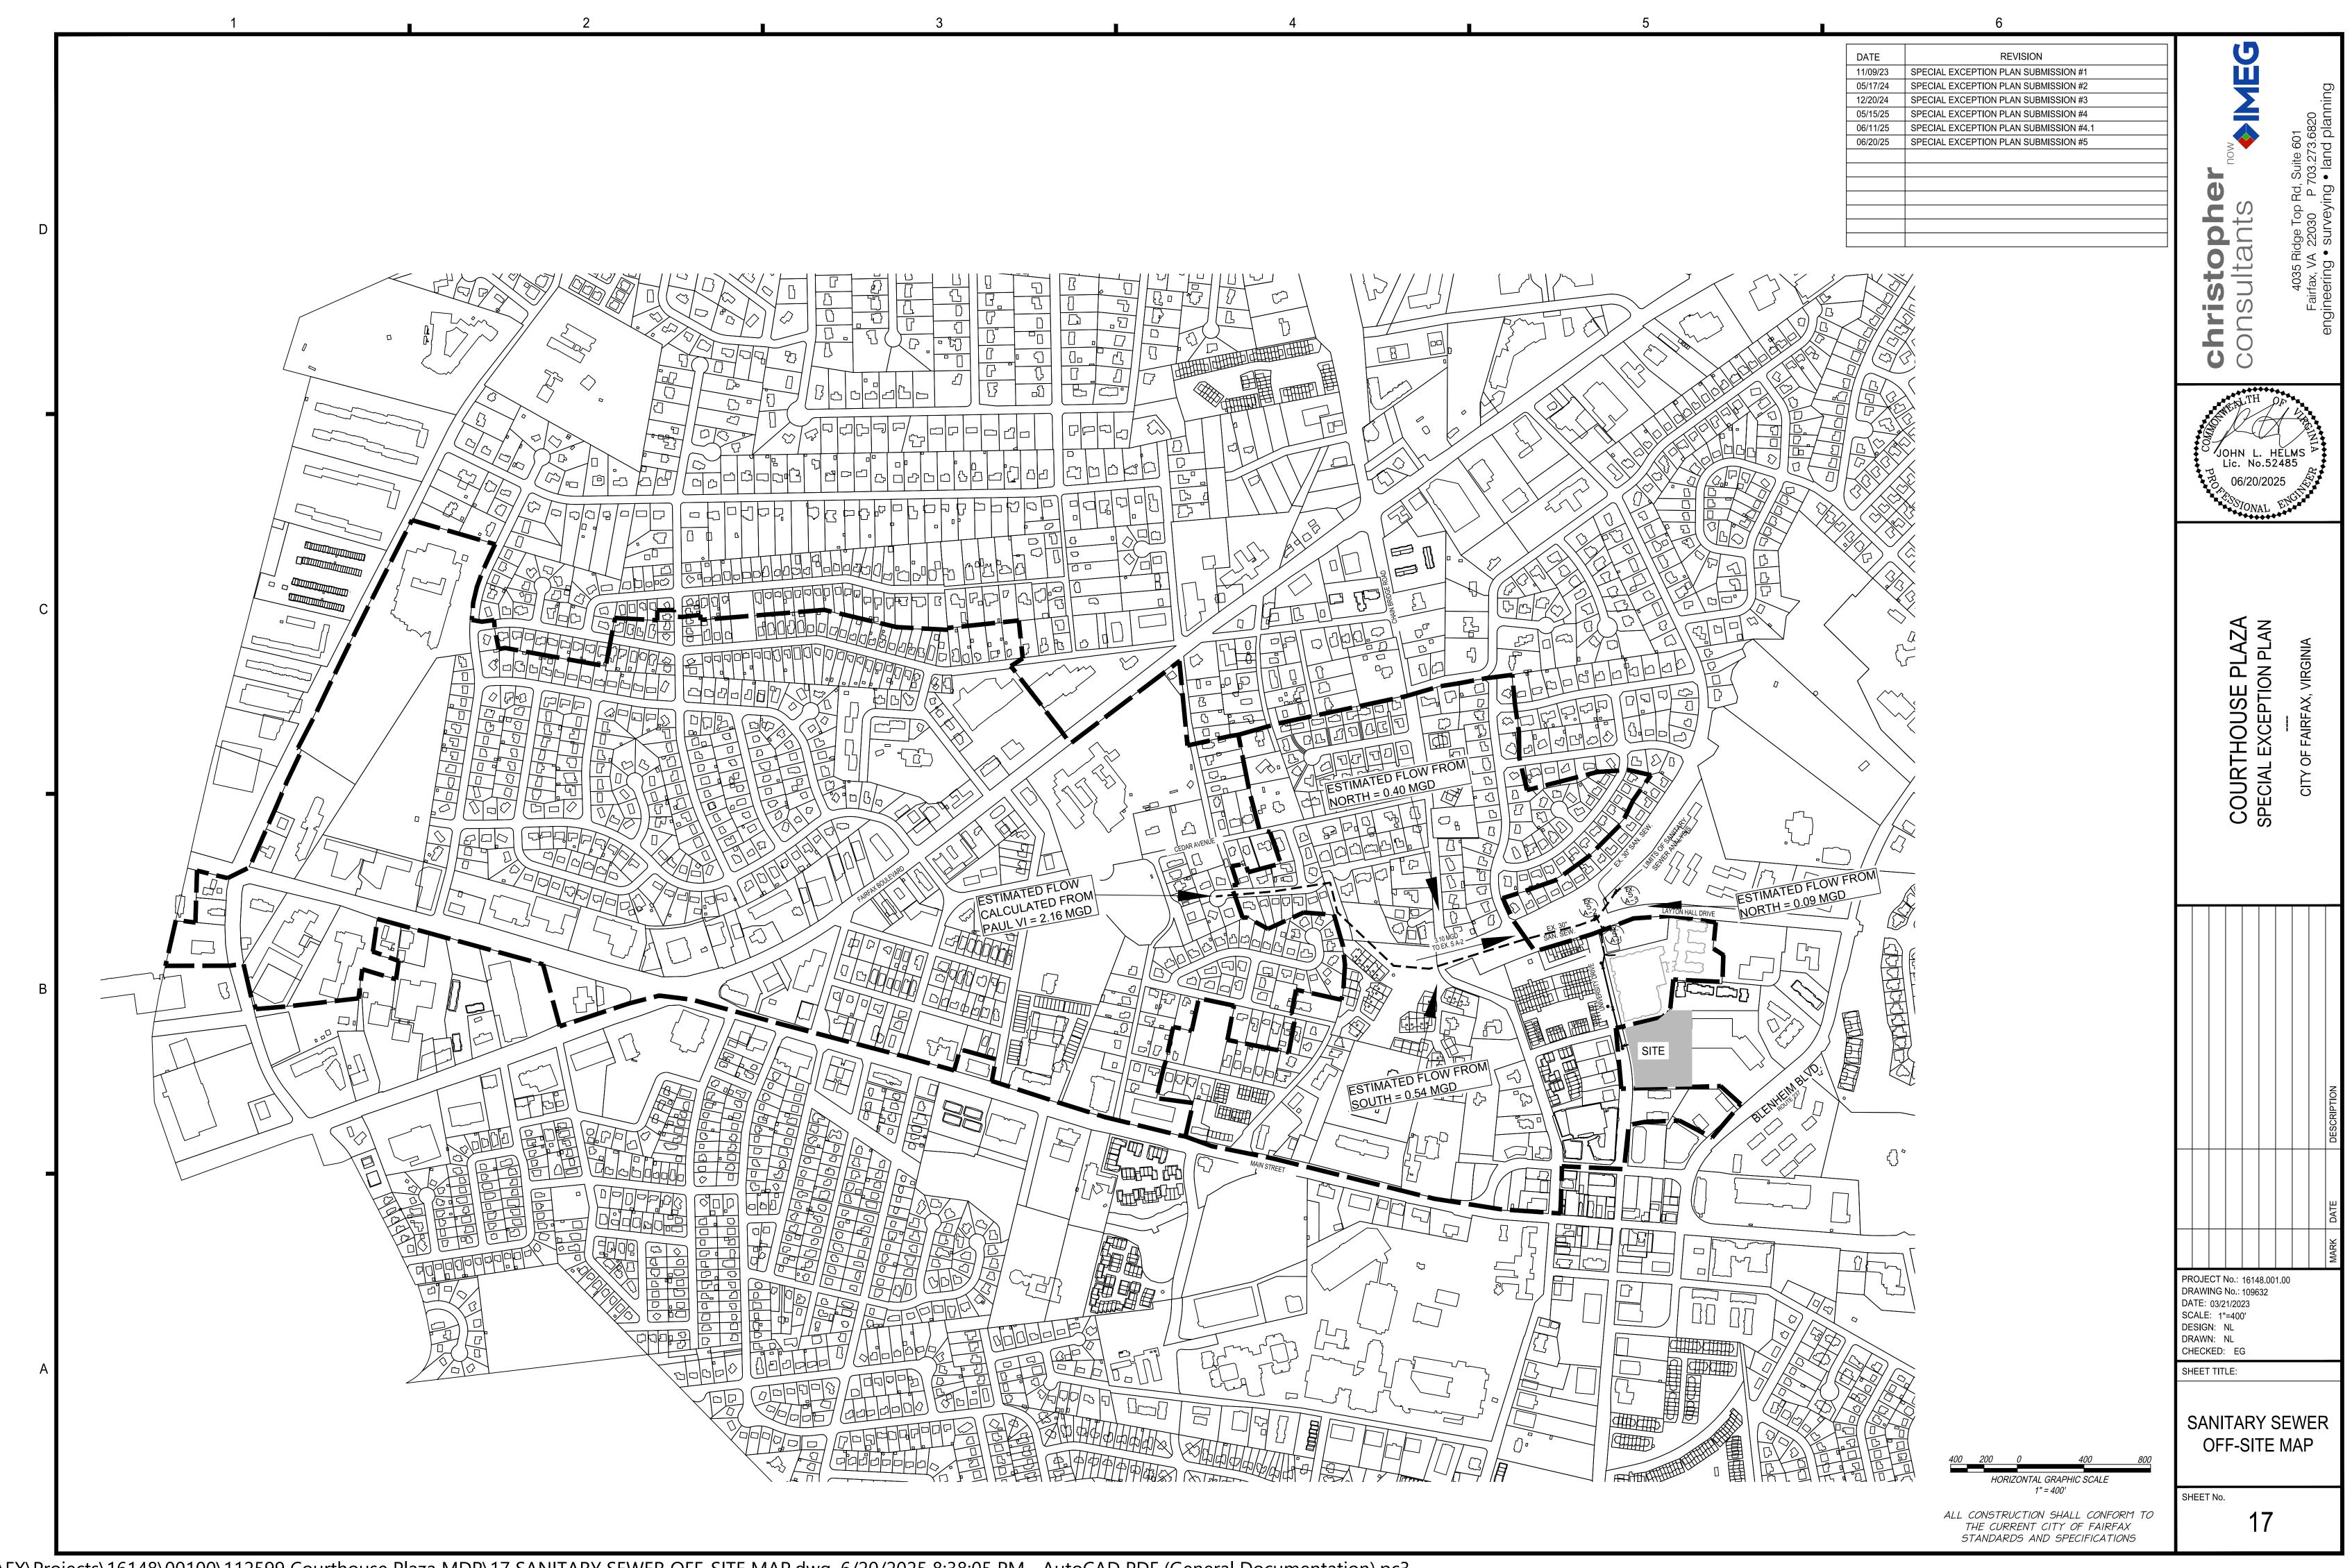
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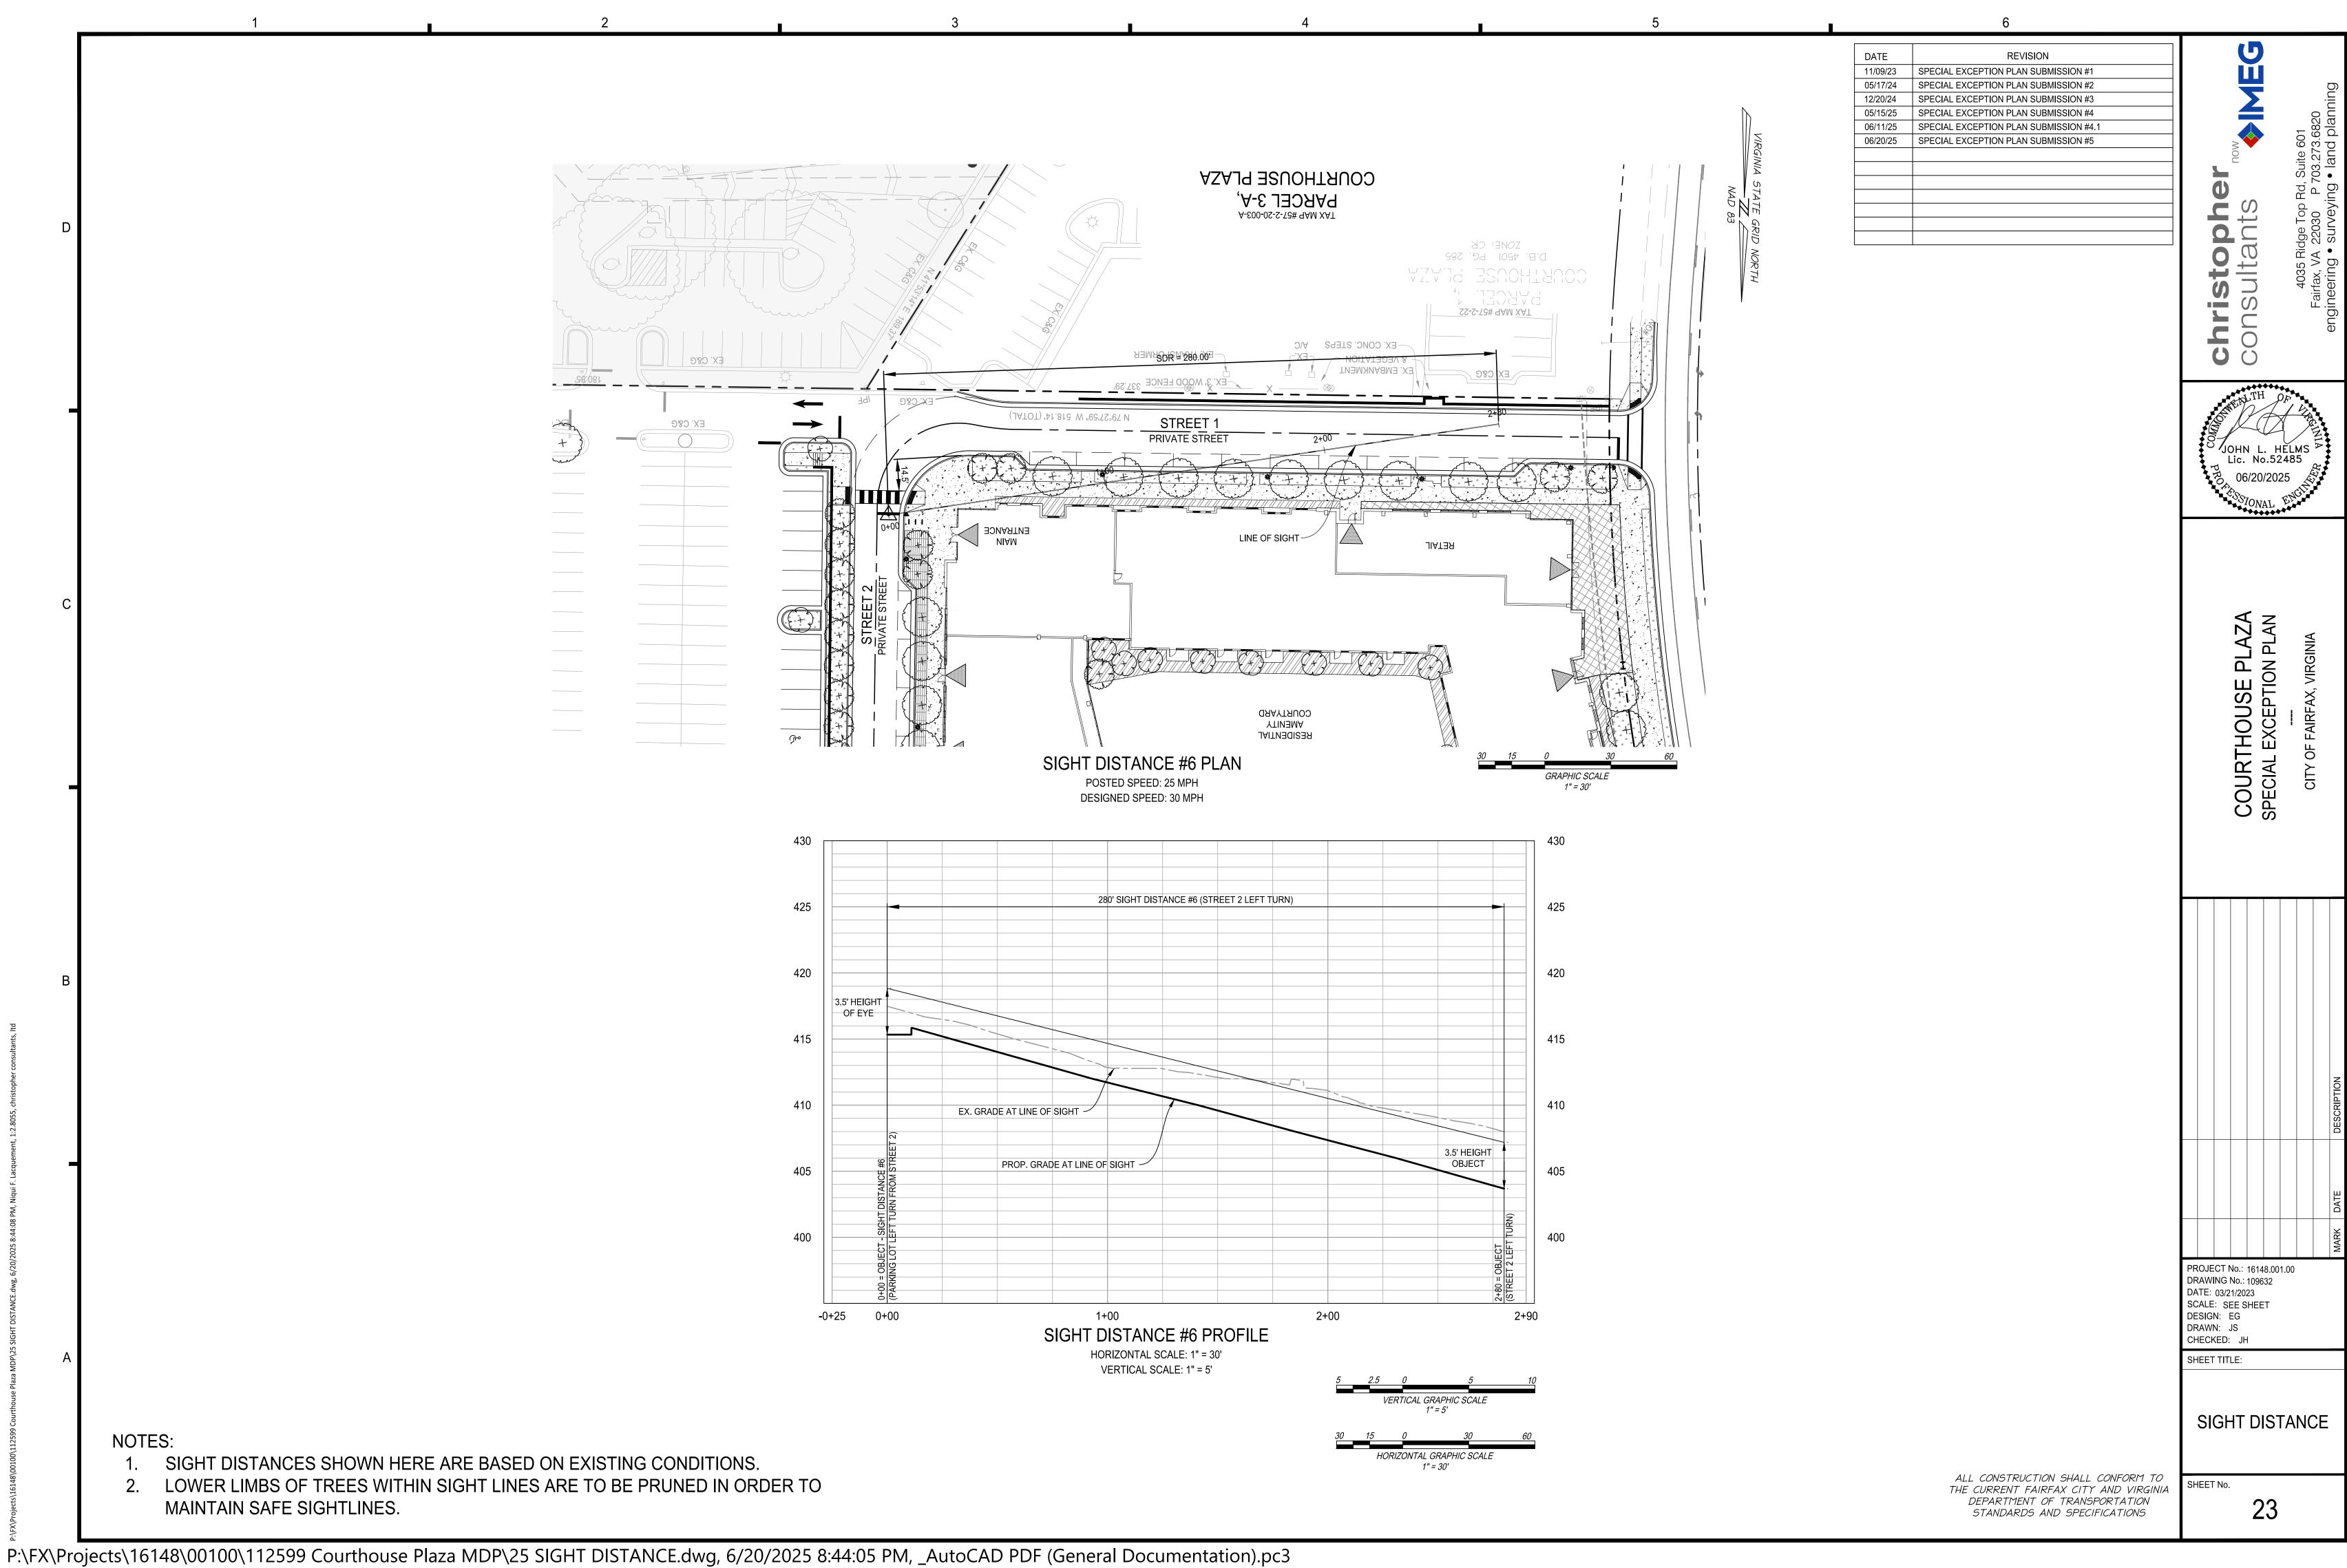





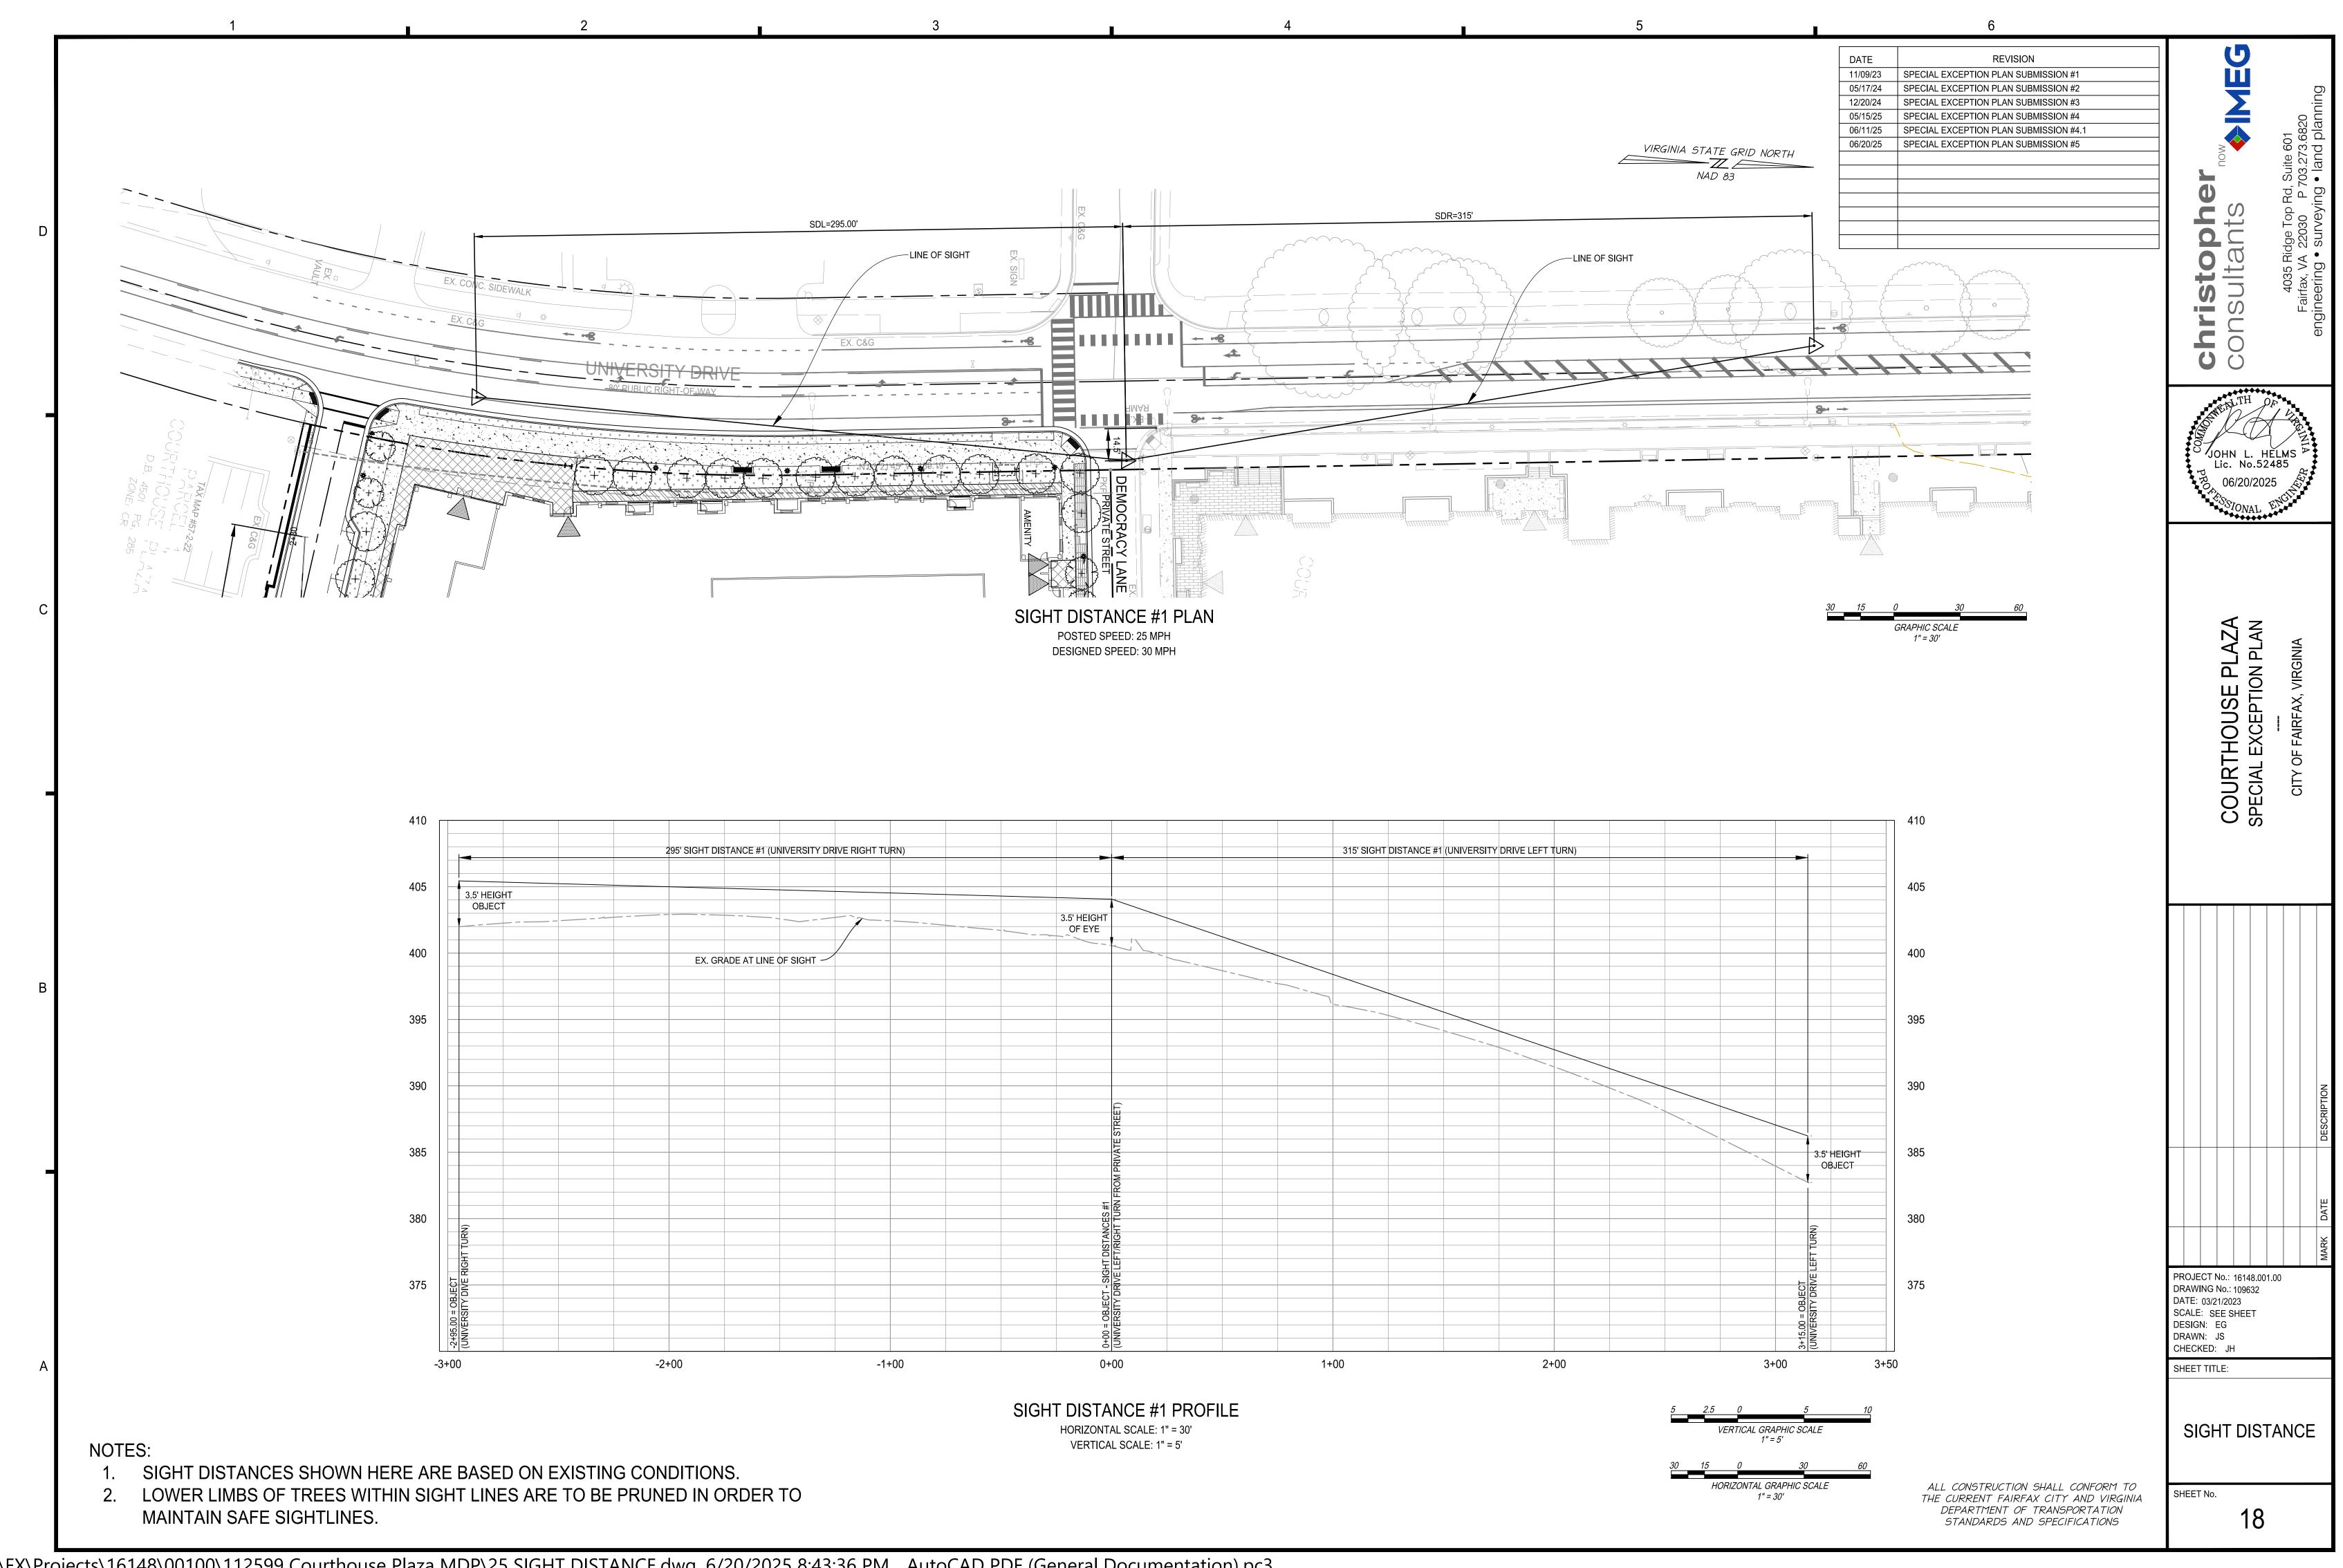


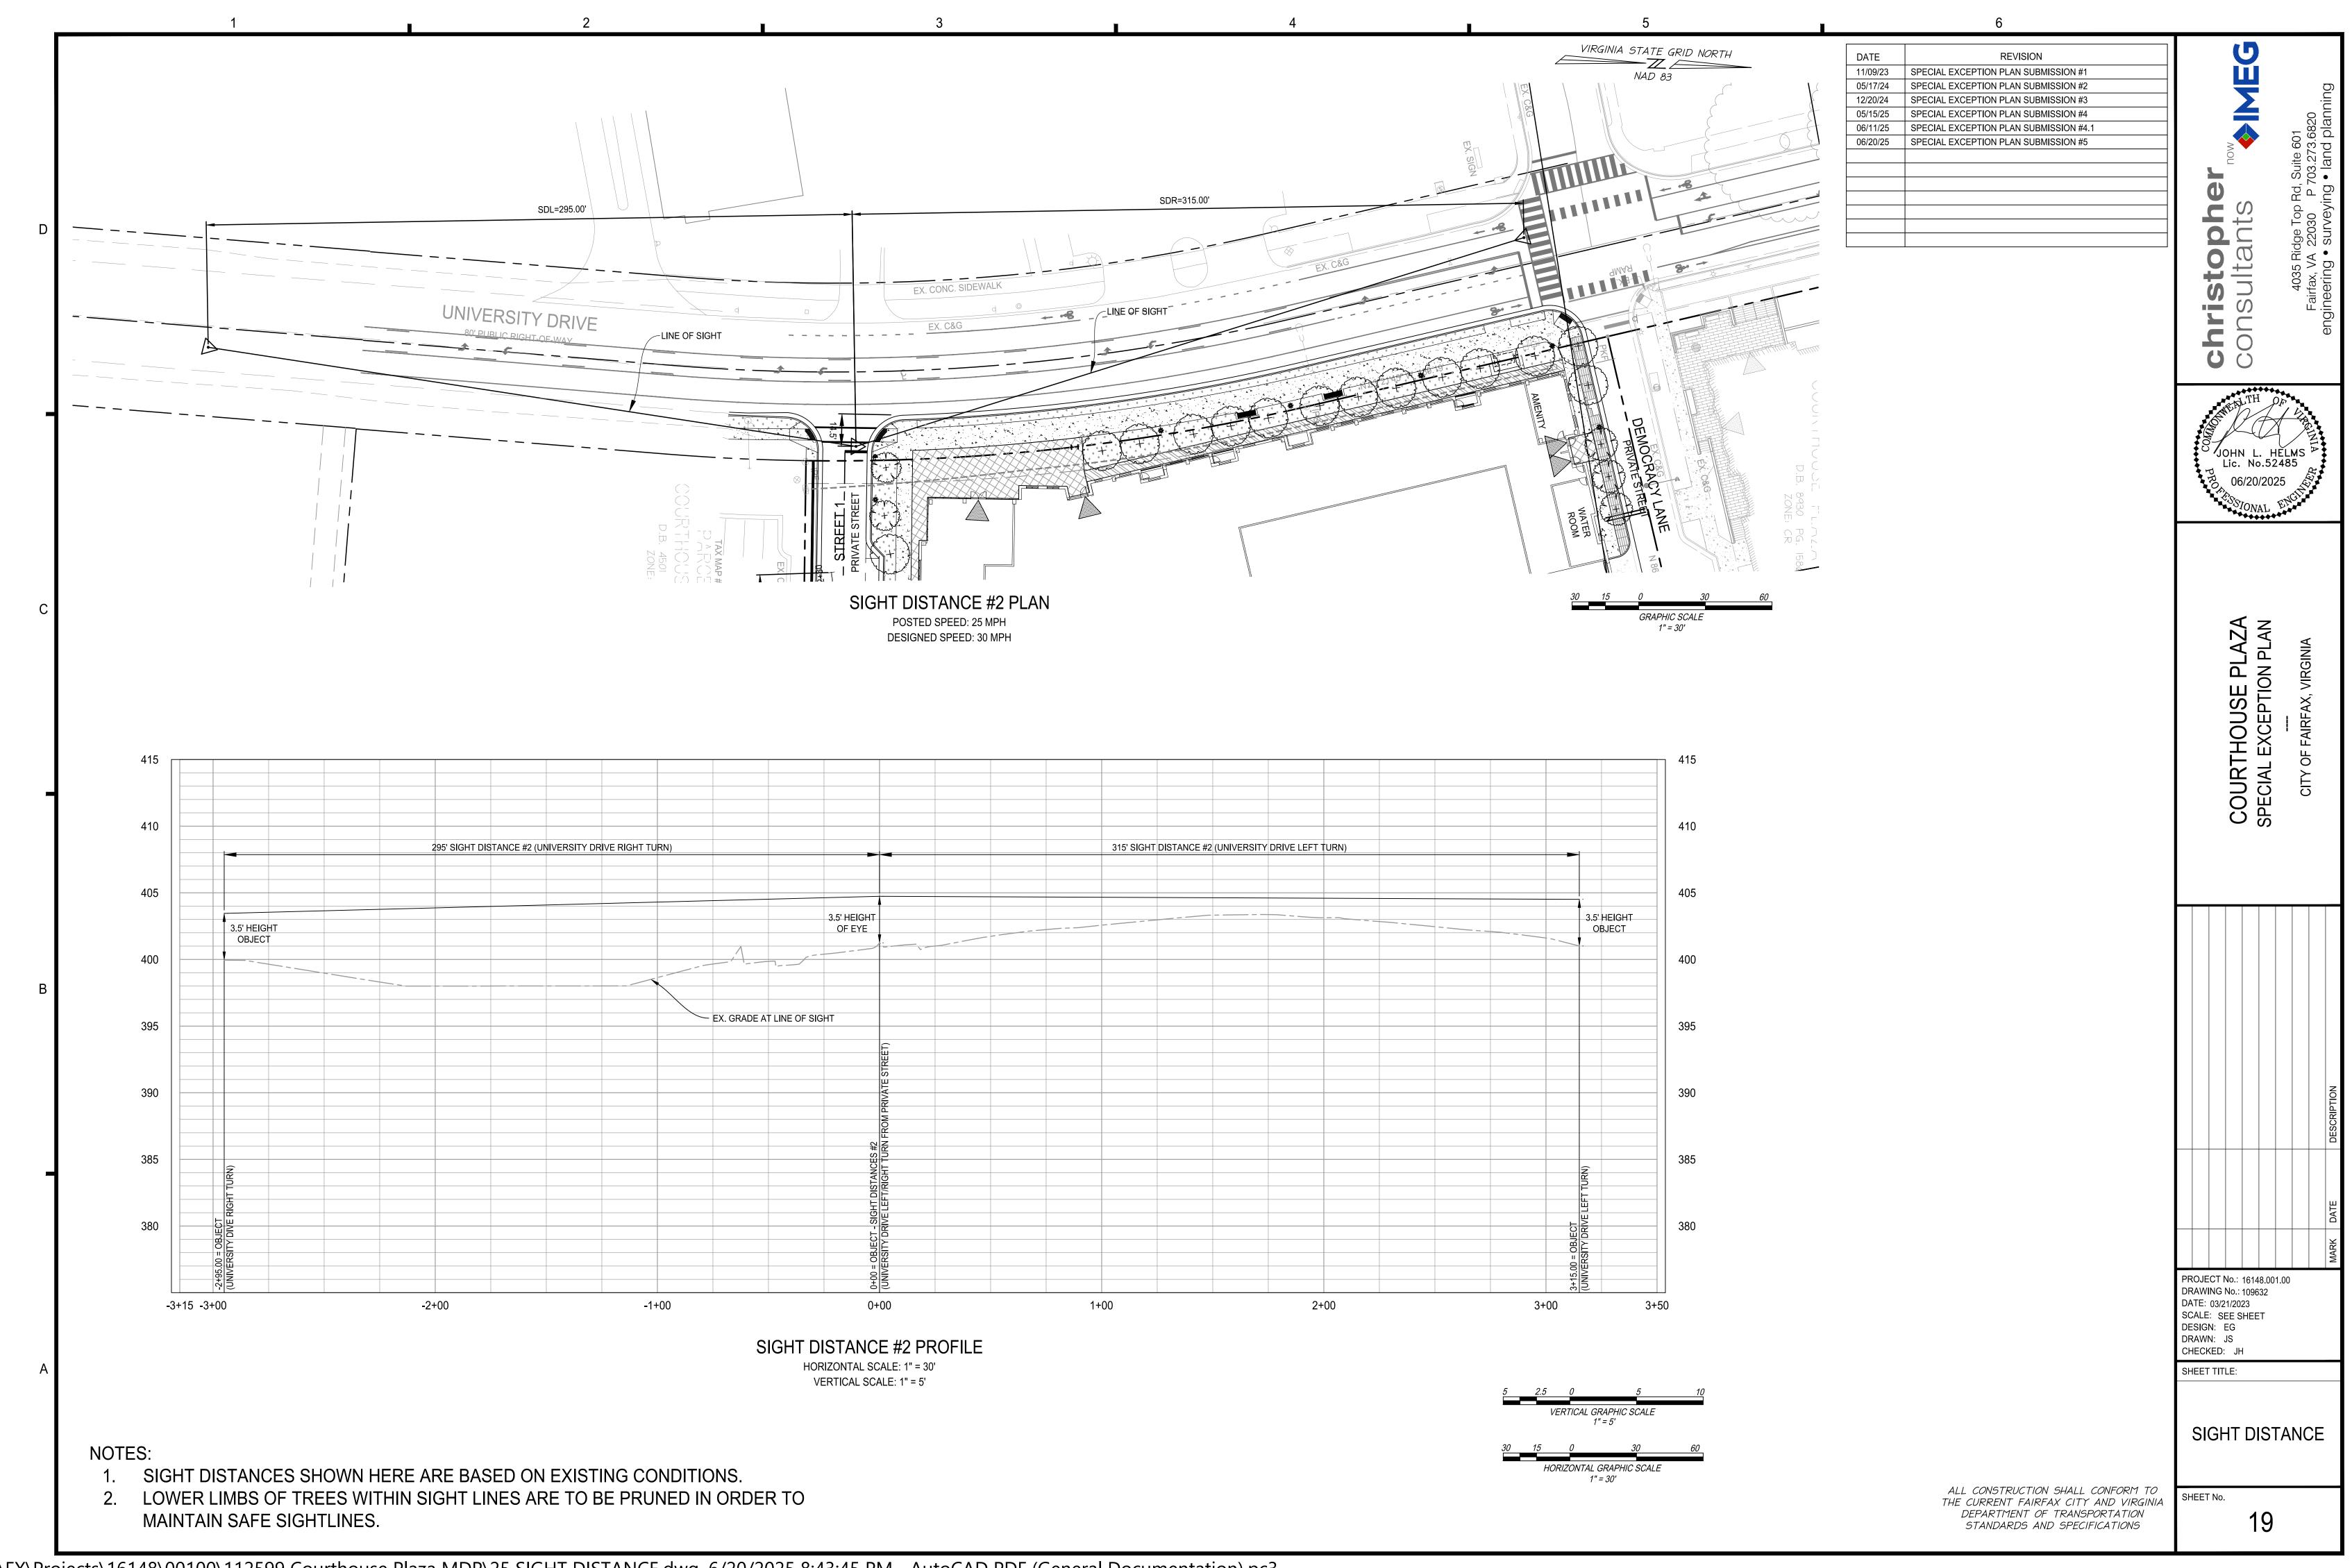


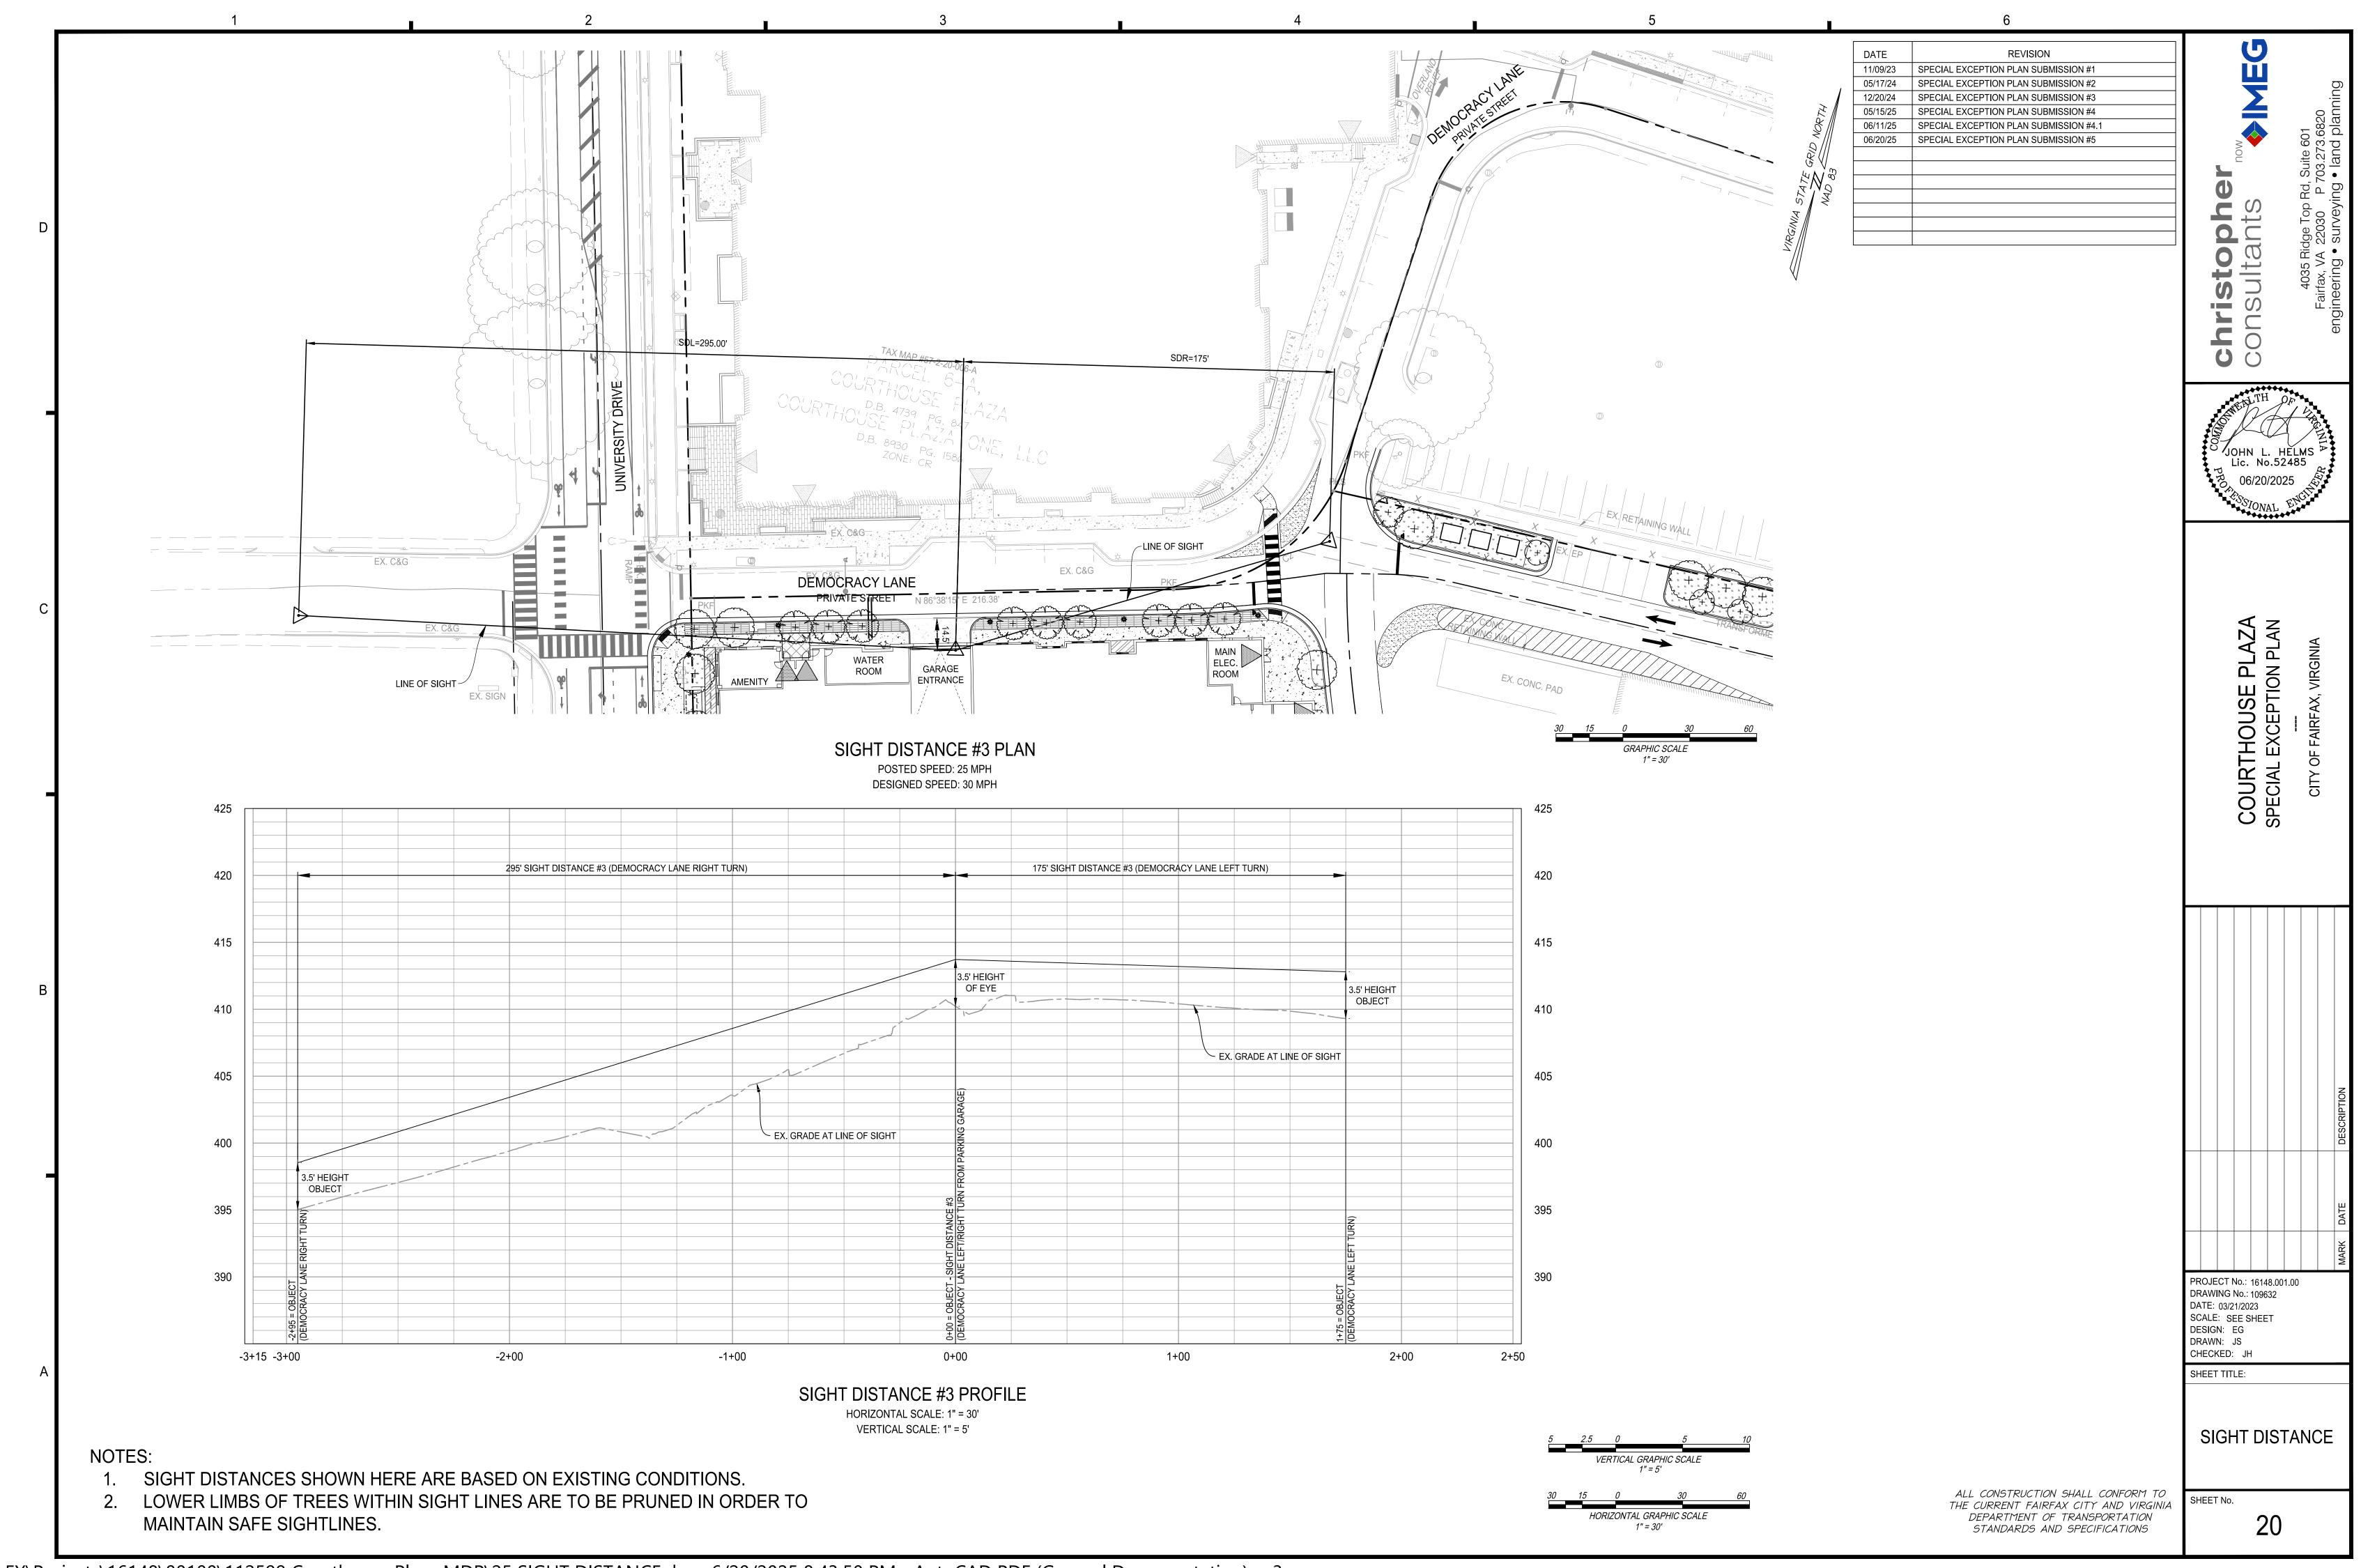

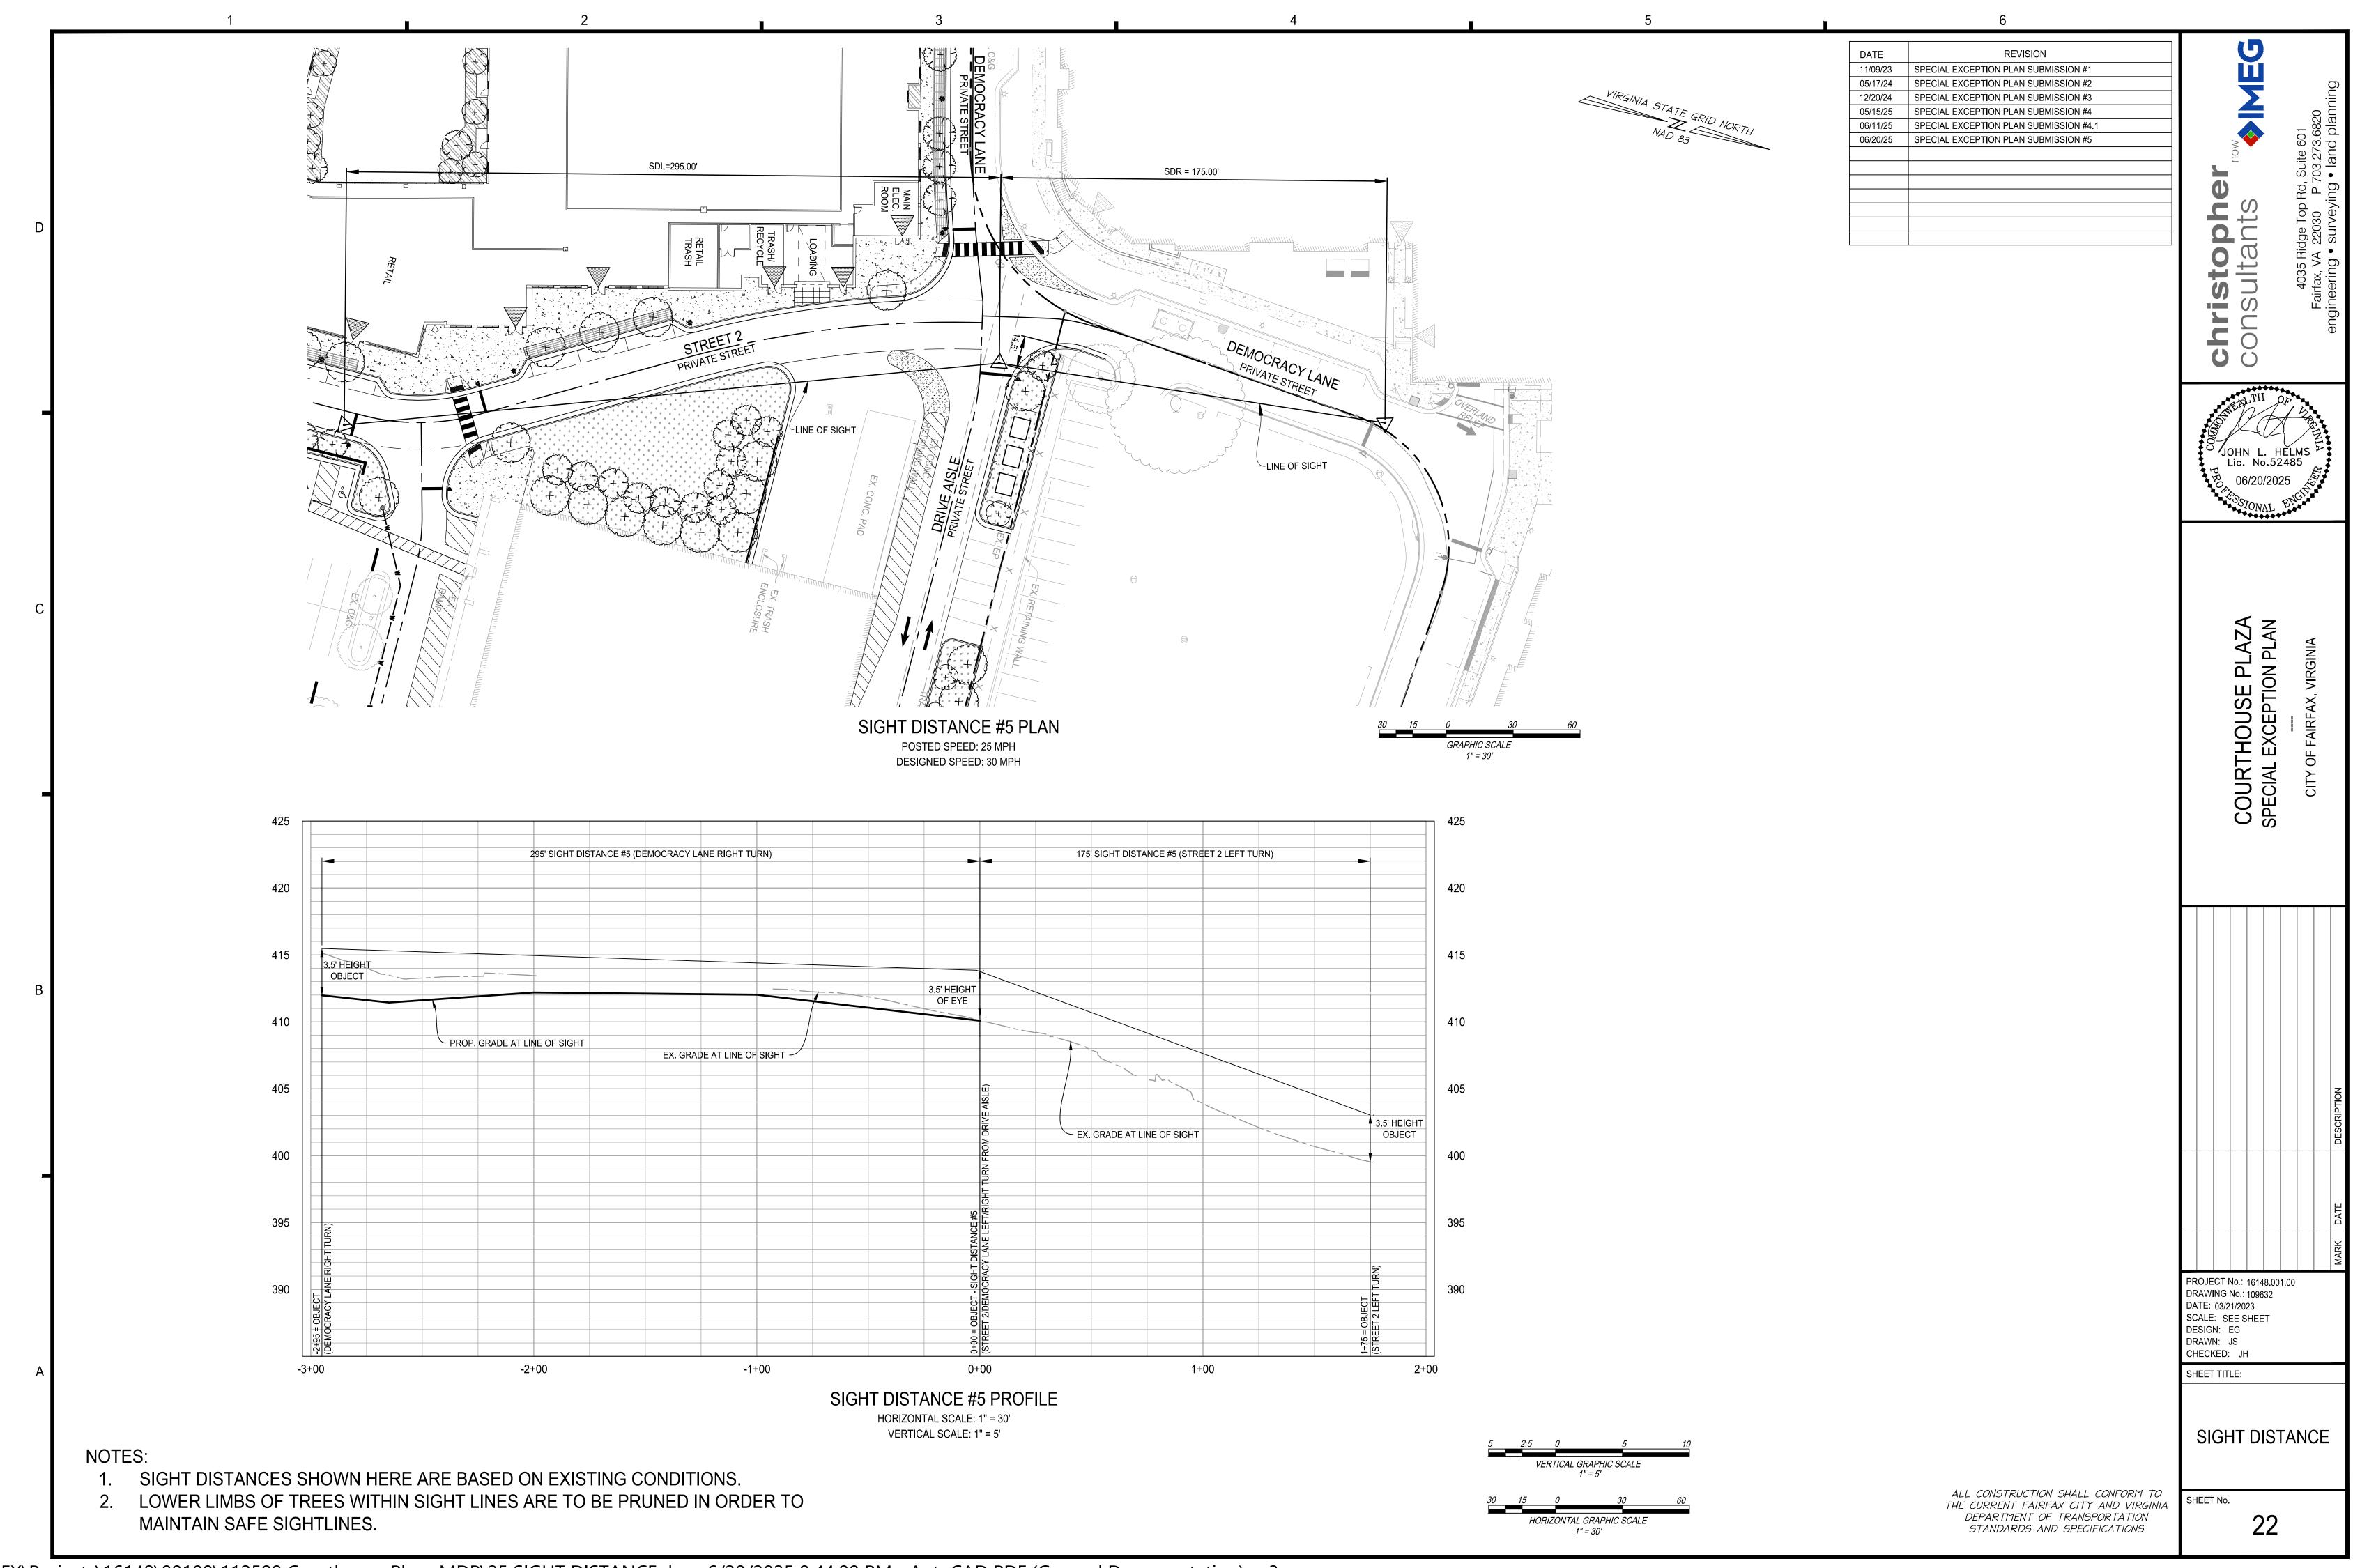


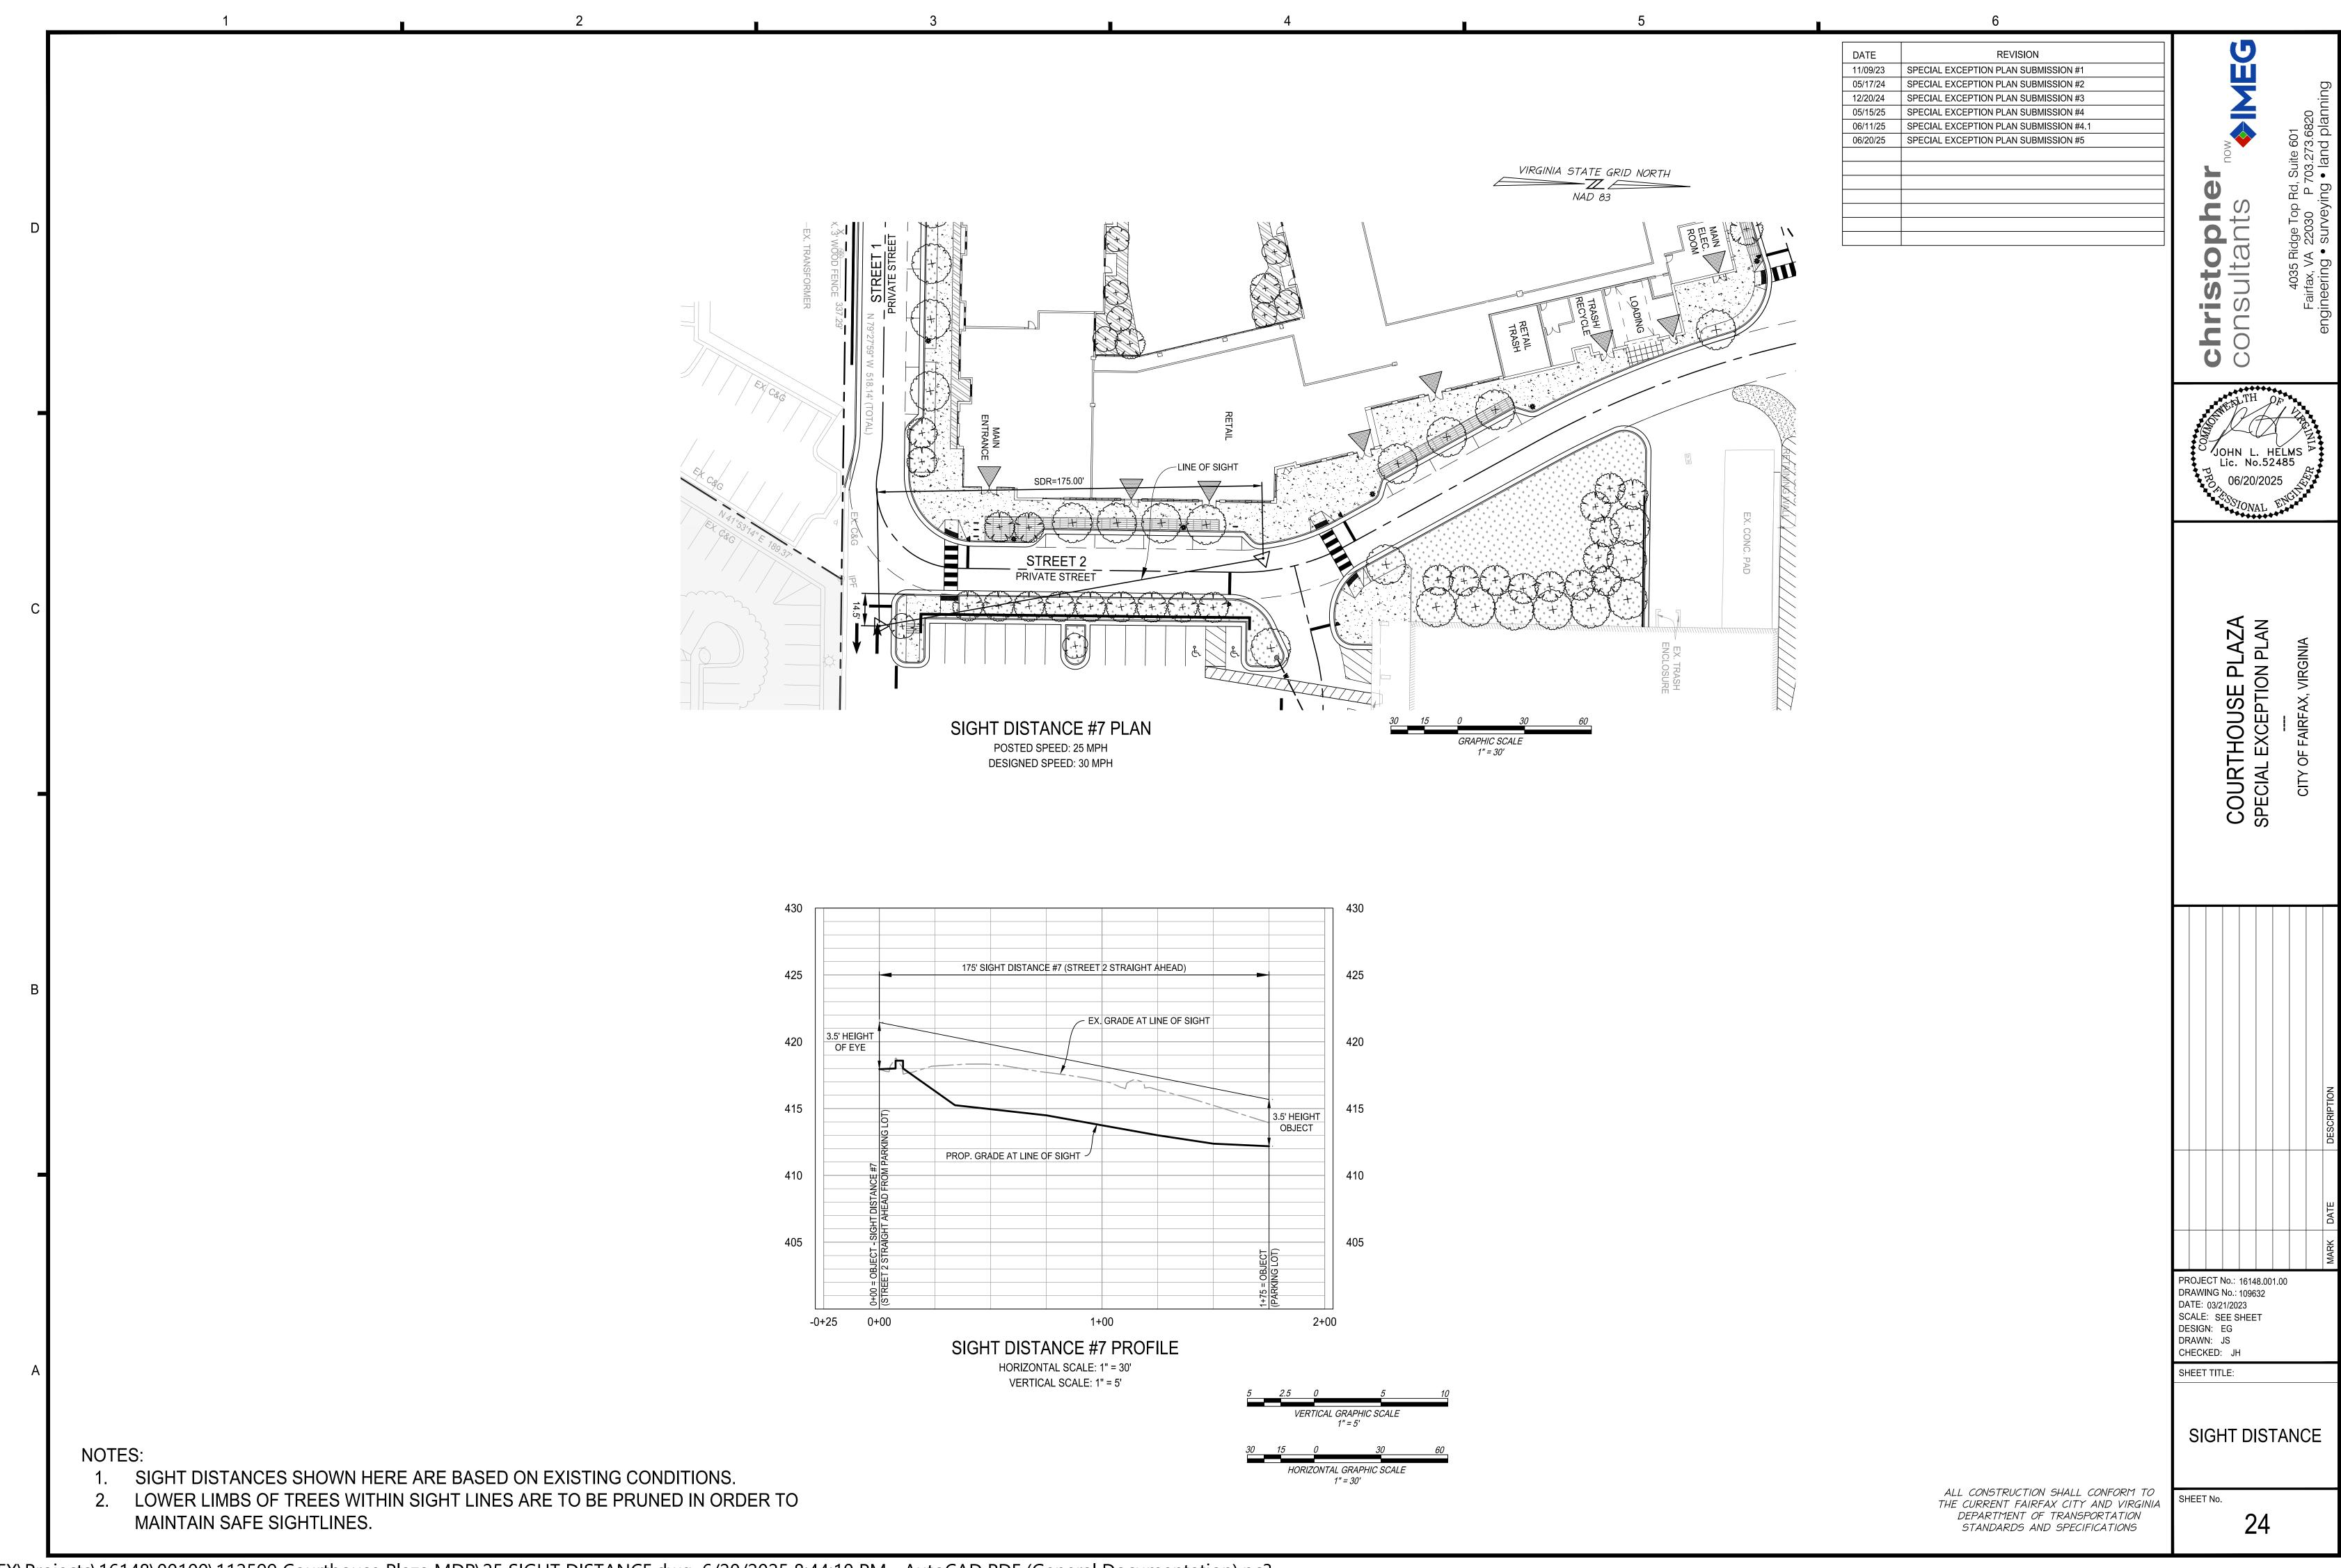


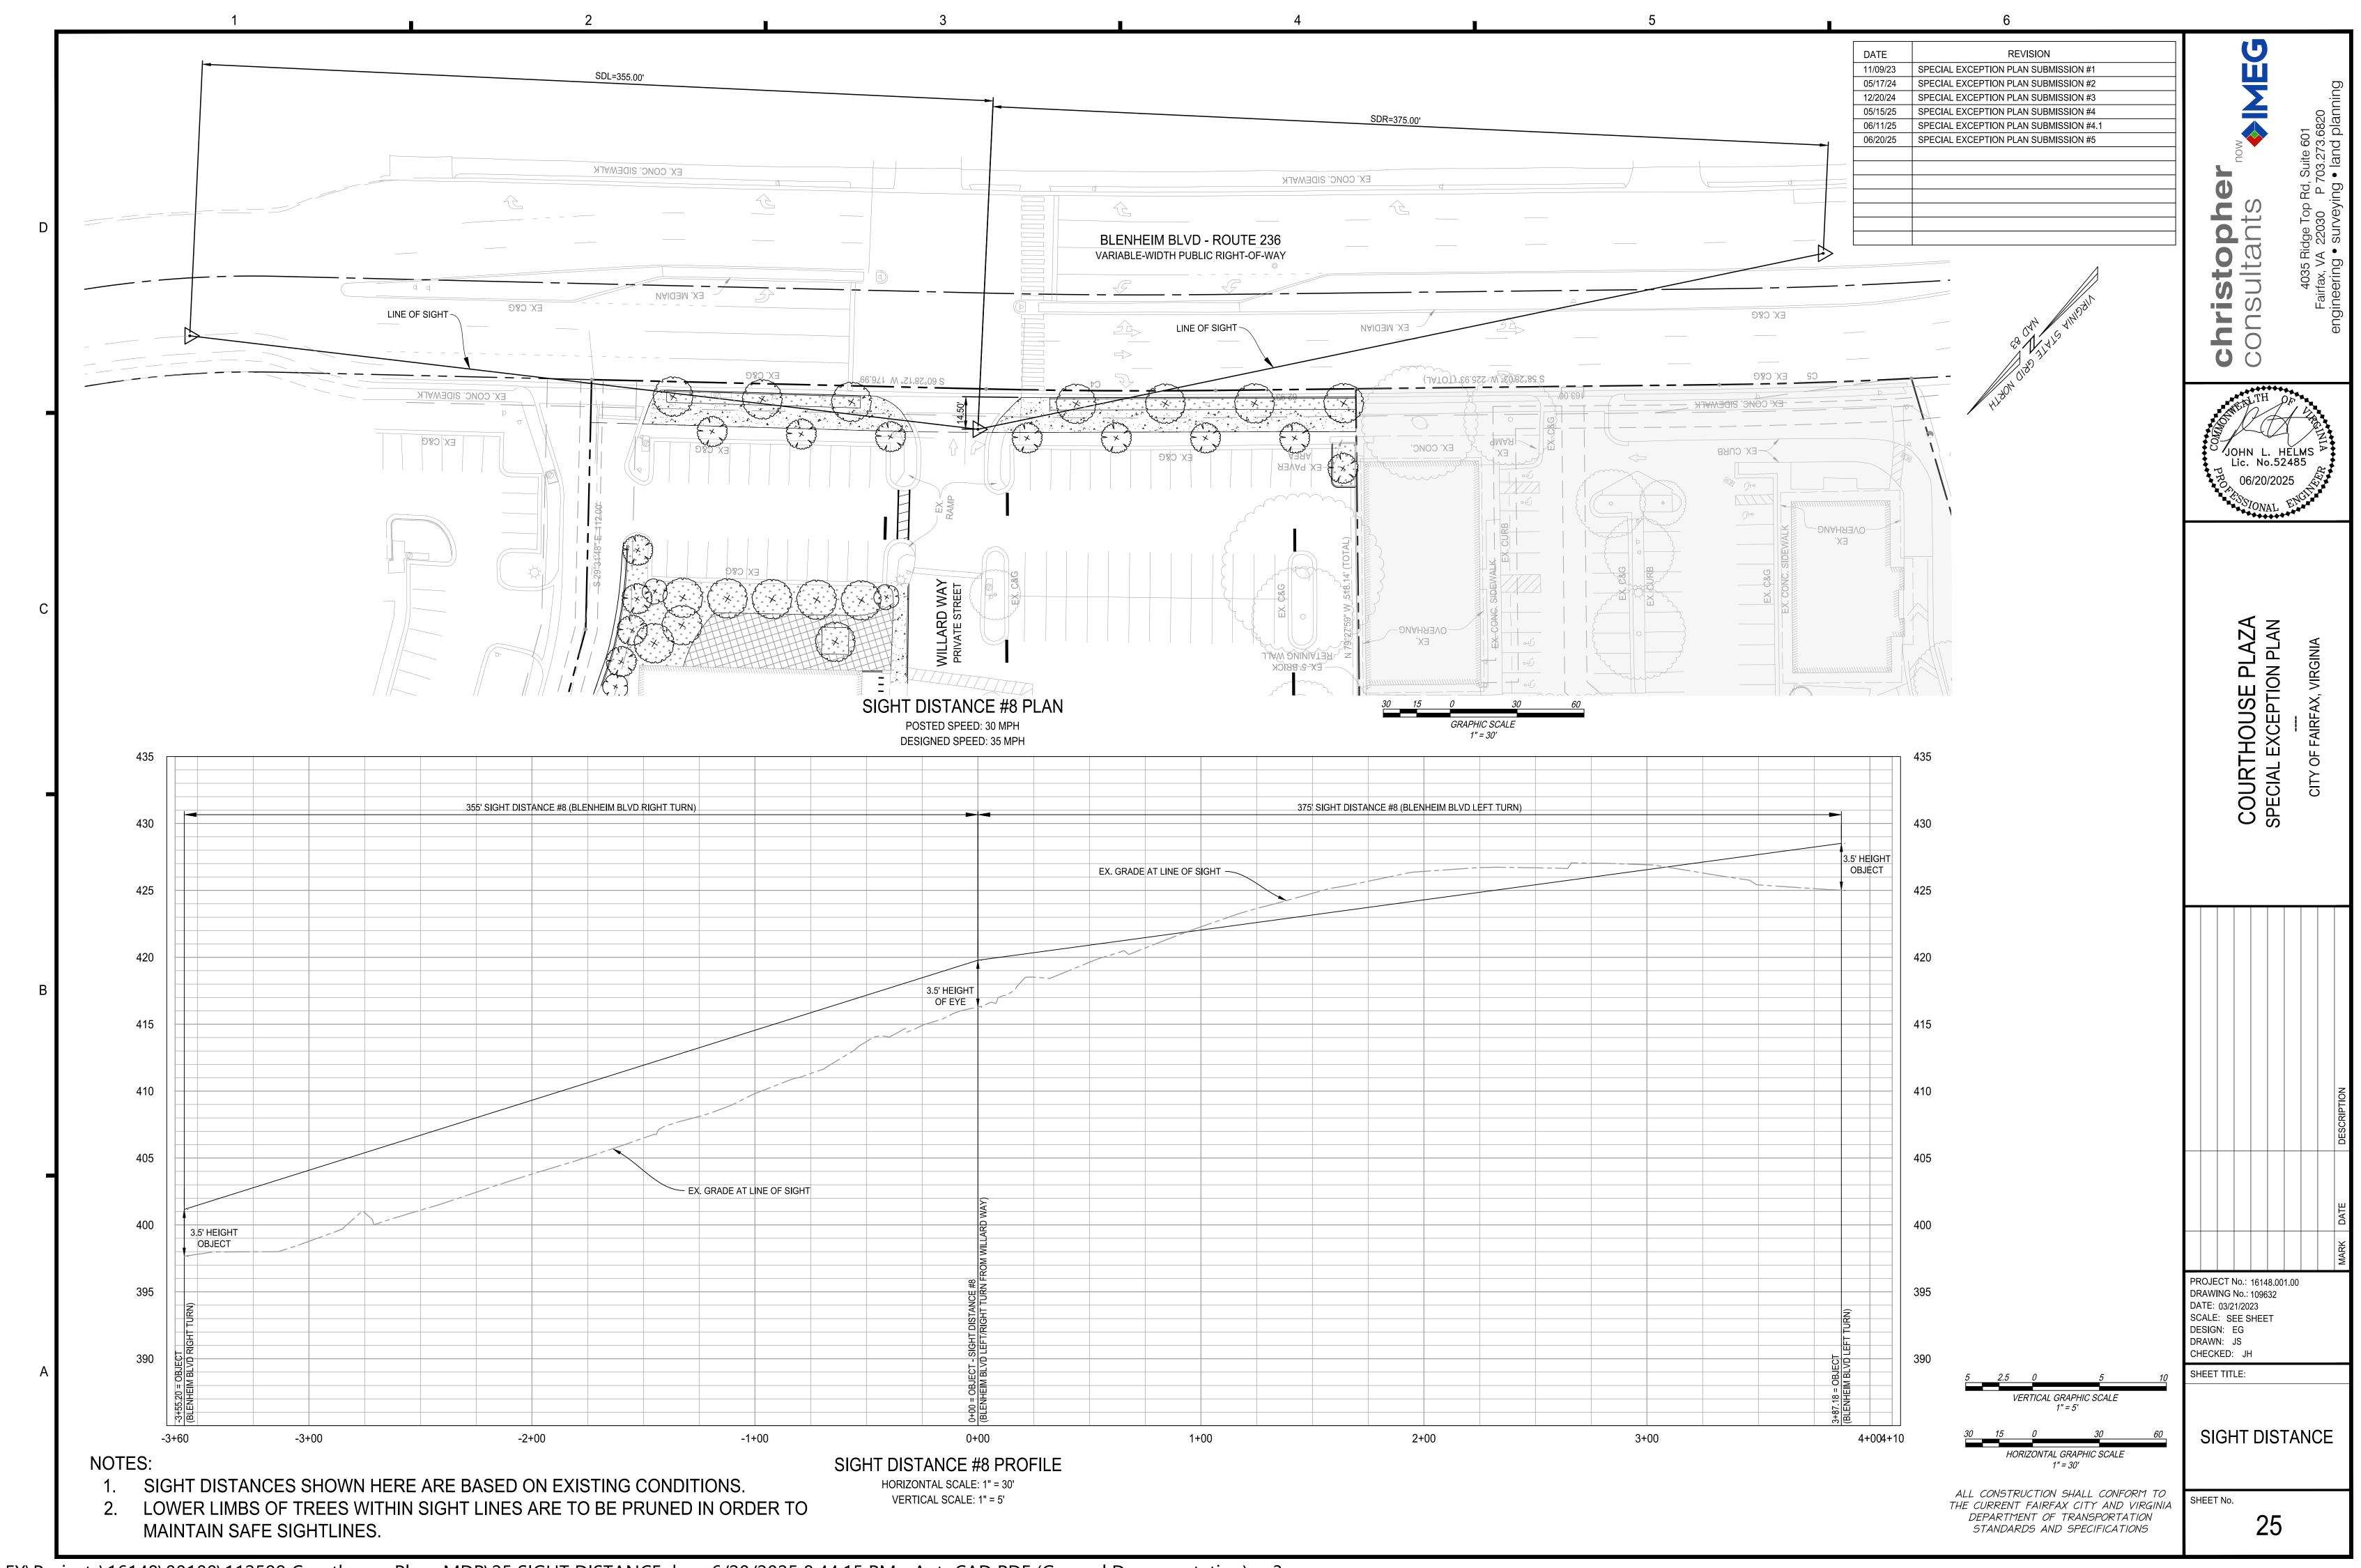


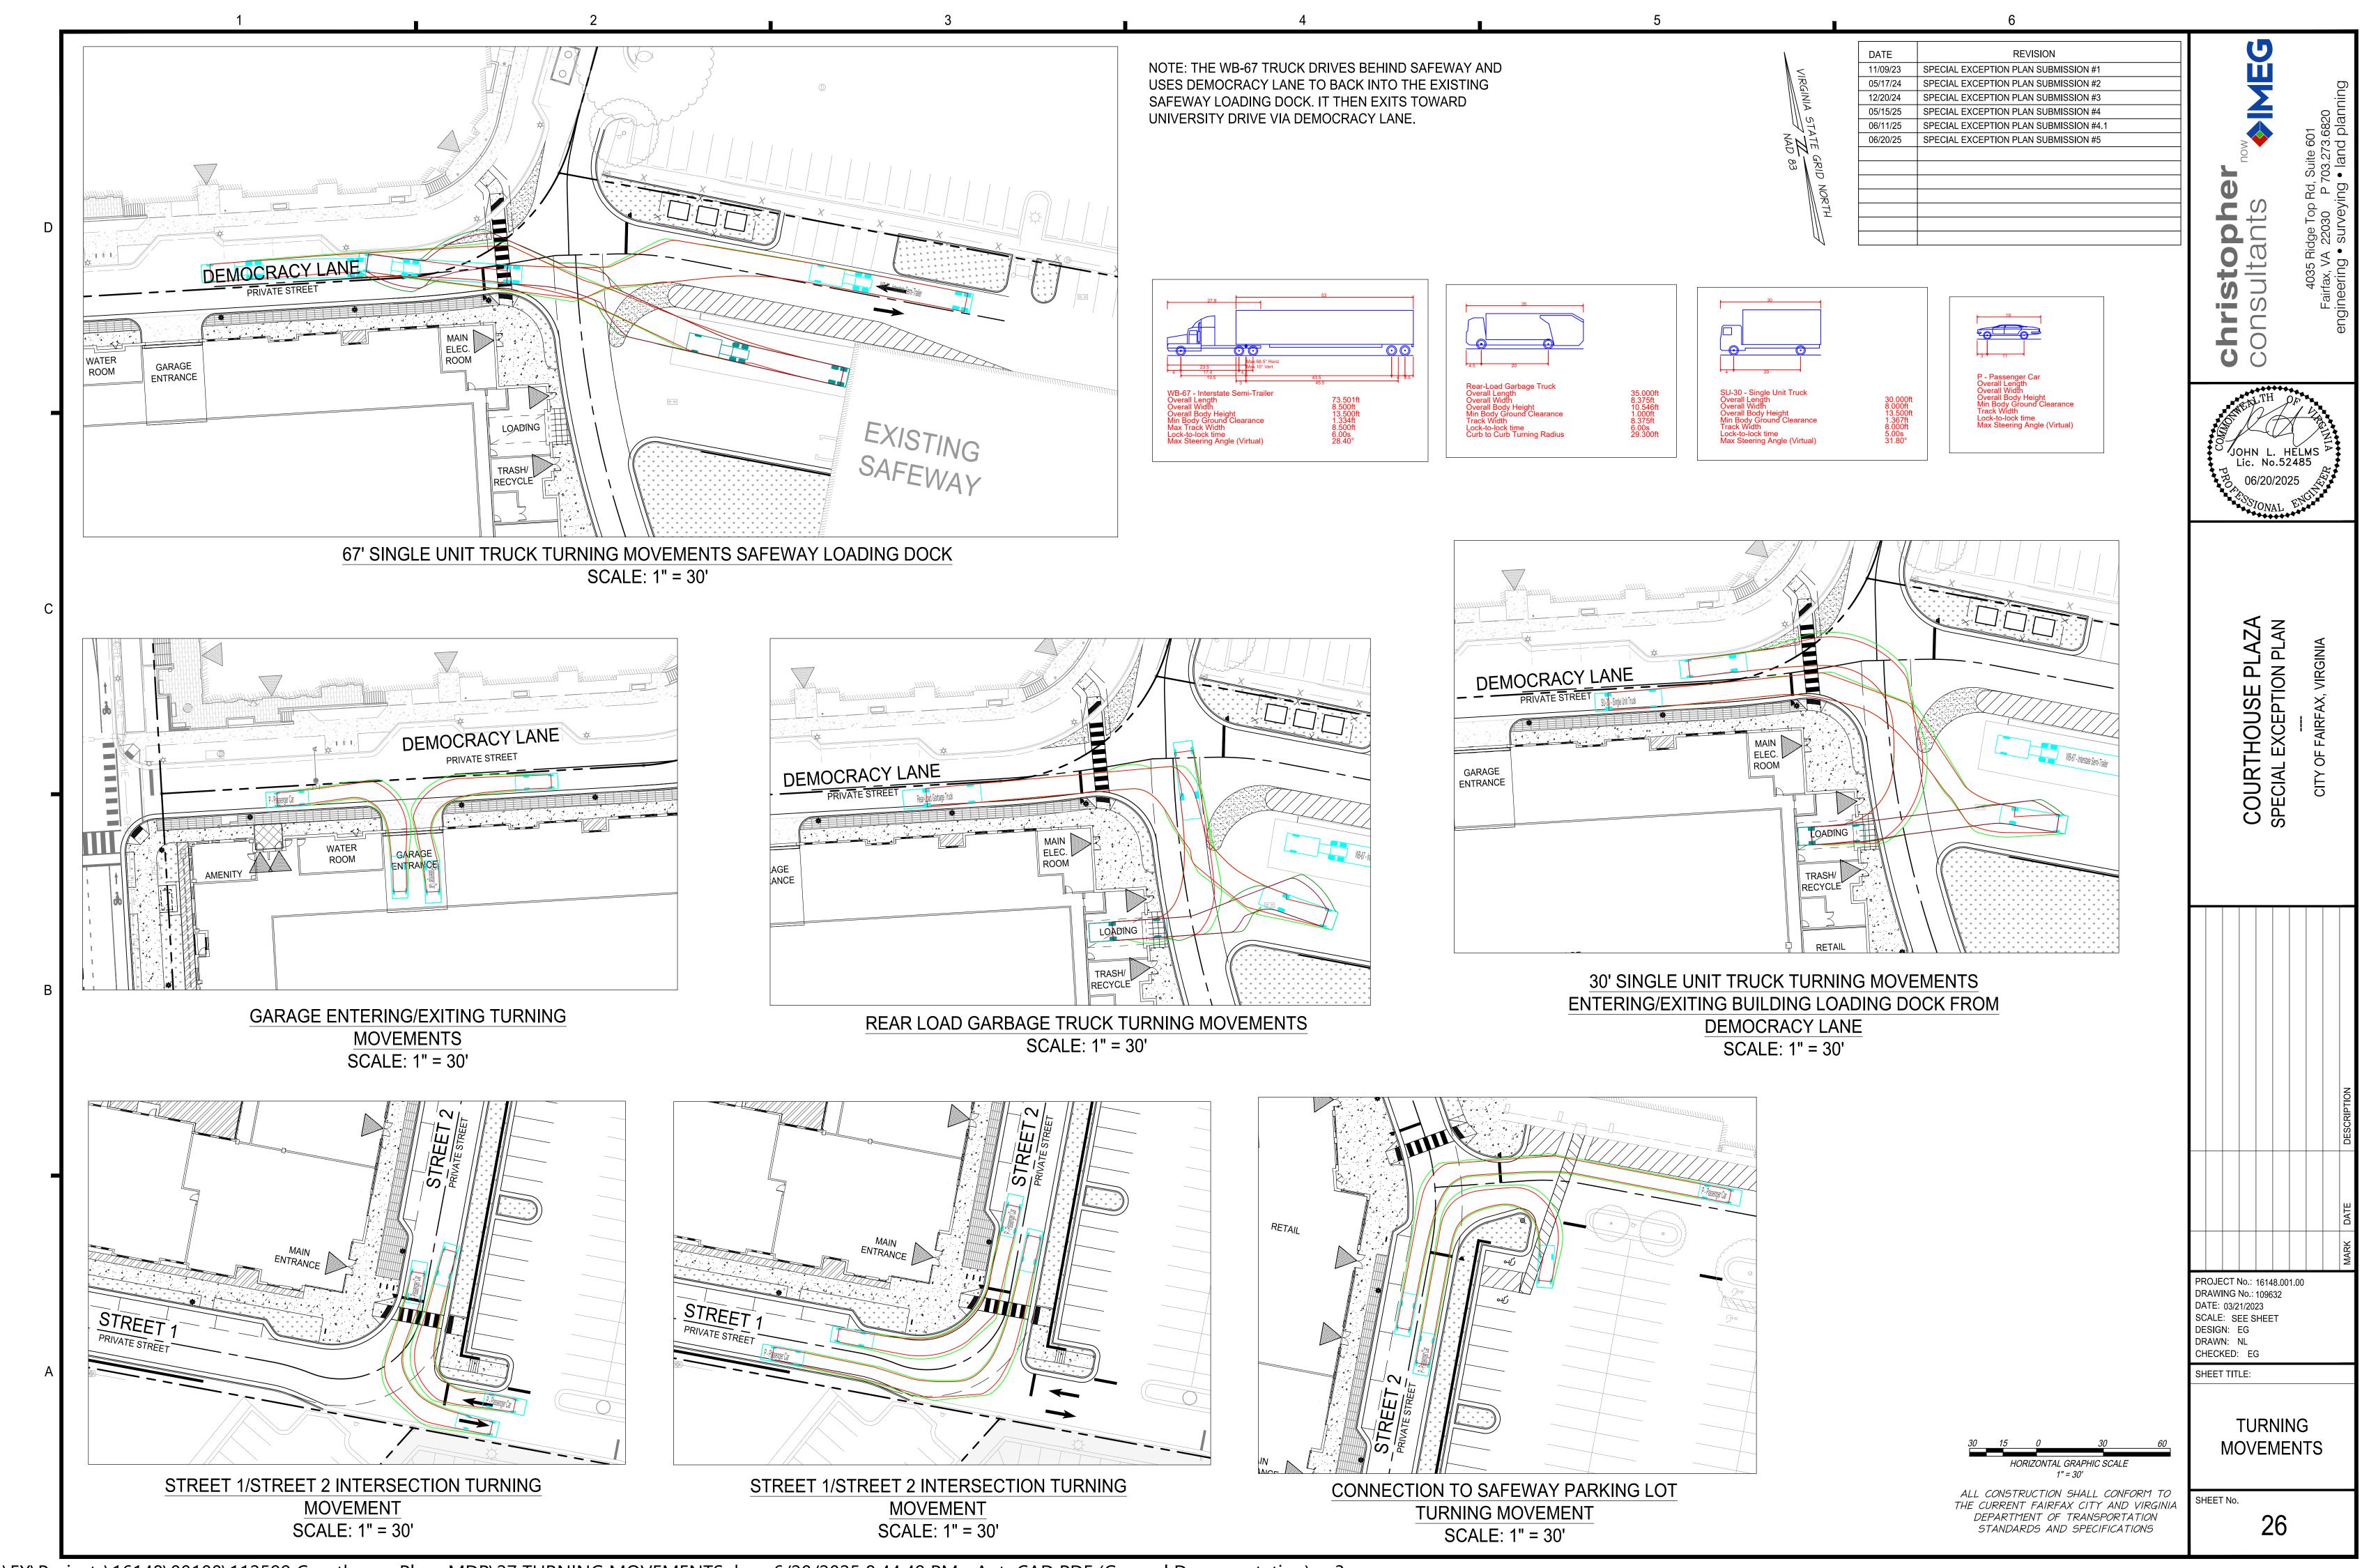



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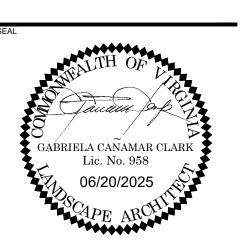


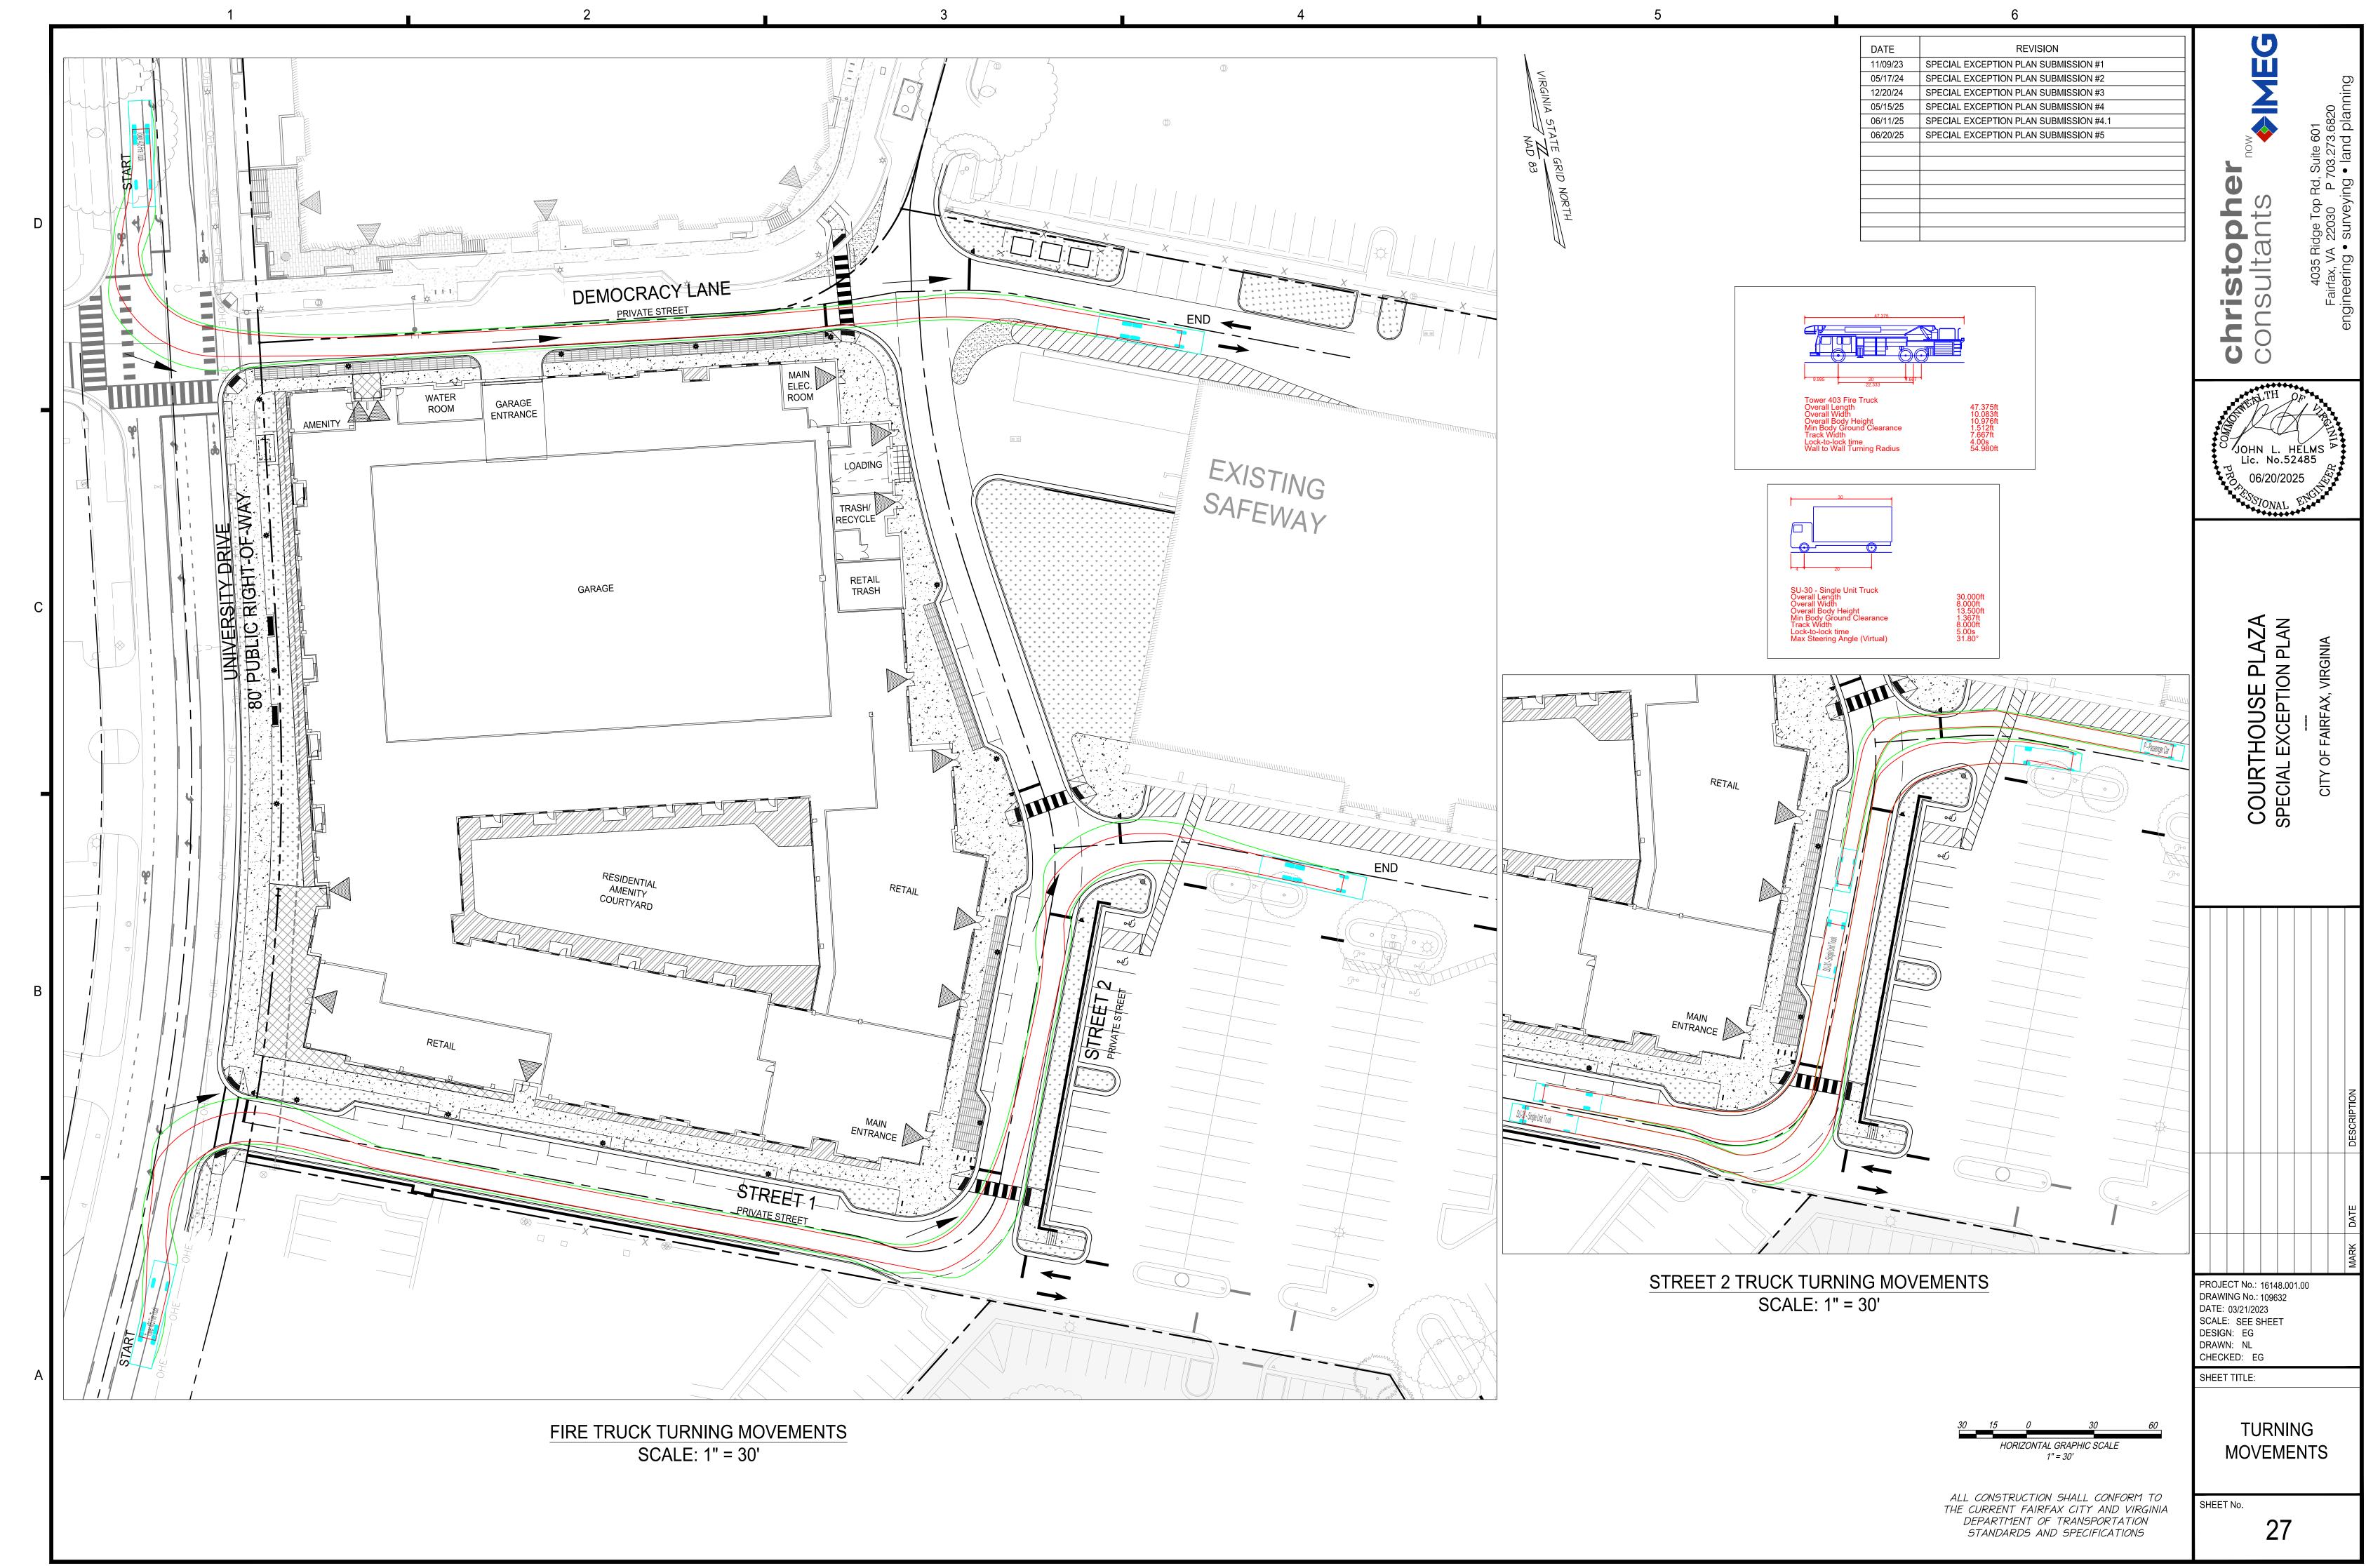200 S. PEYTON STREET ALEXANDRIA, VA 22314 703.549.7784 WWW.LANDDESIGN.COM

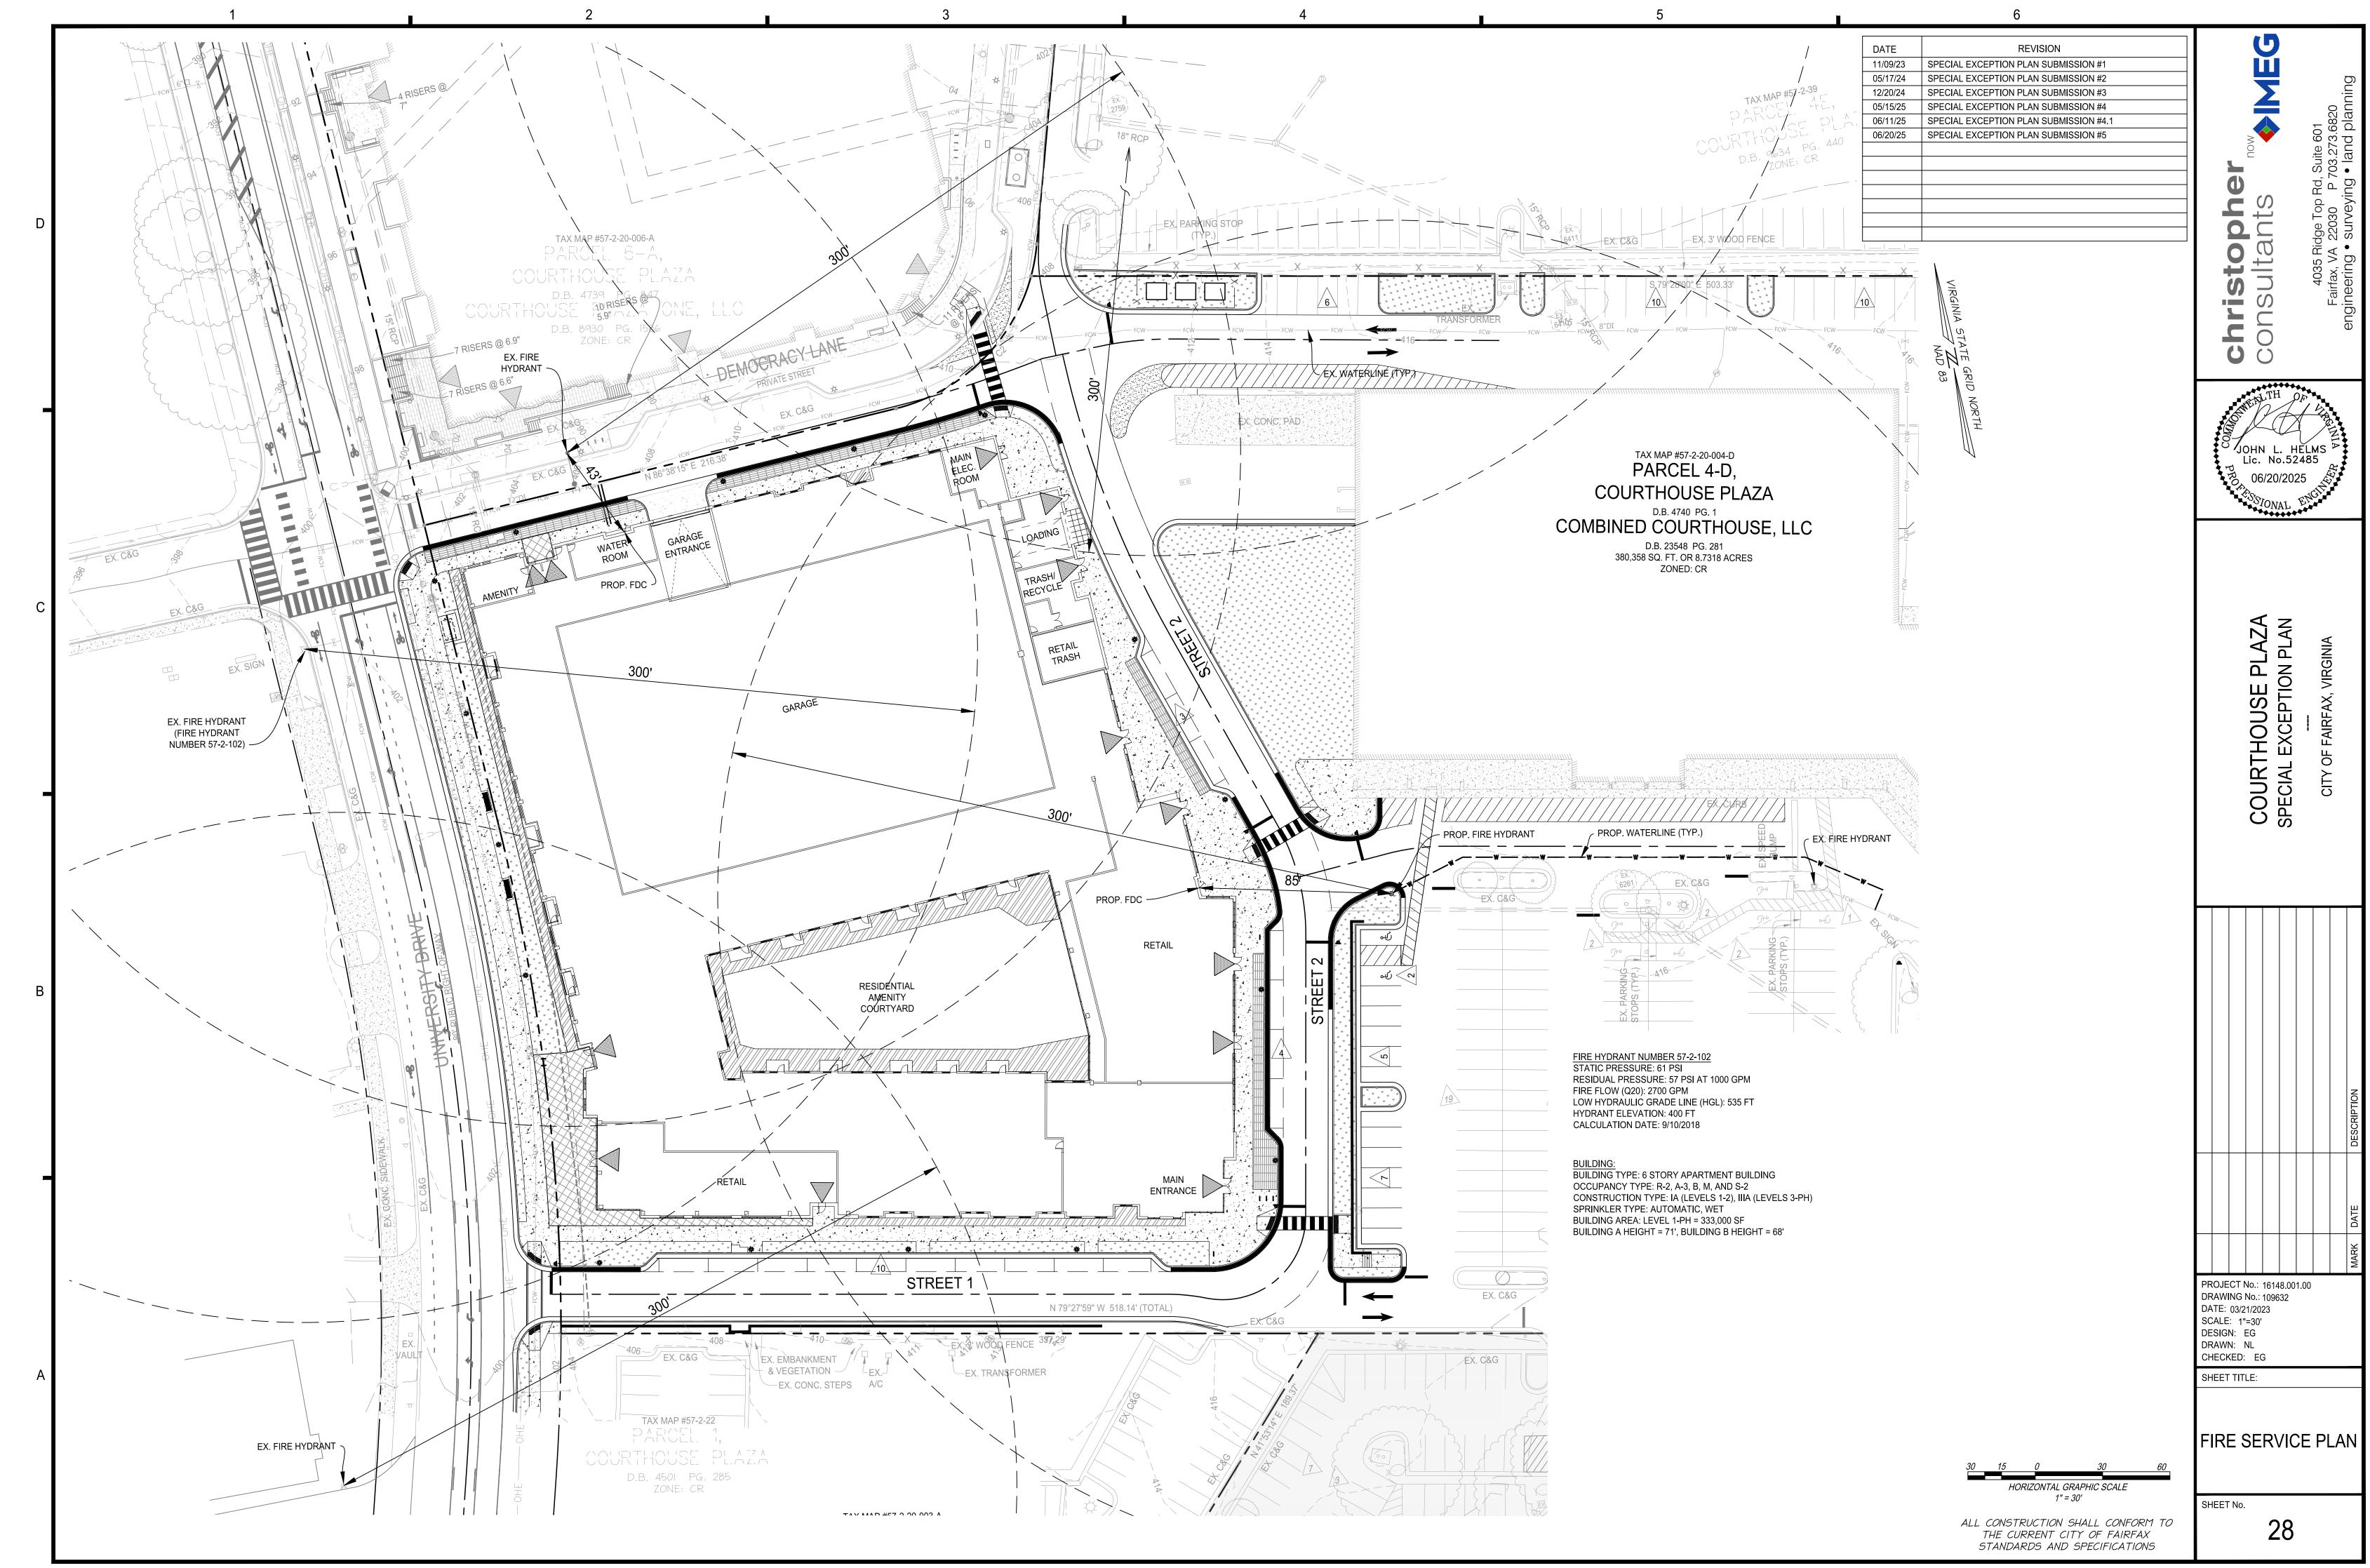16,090 SF

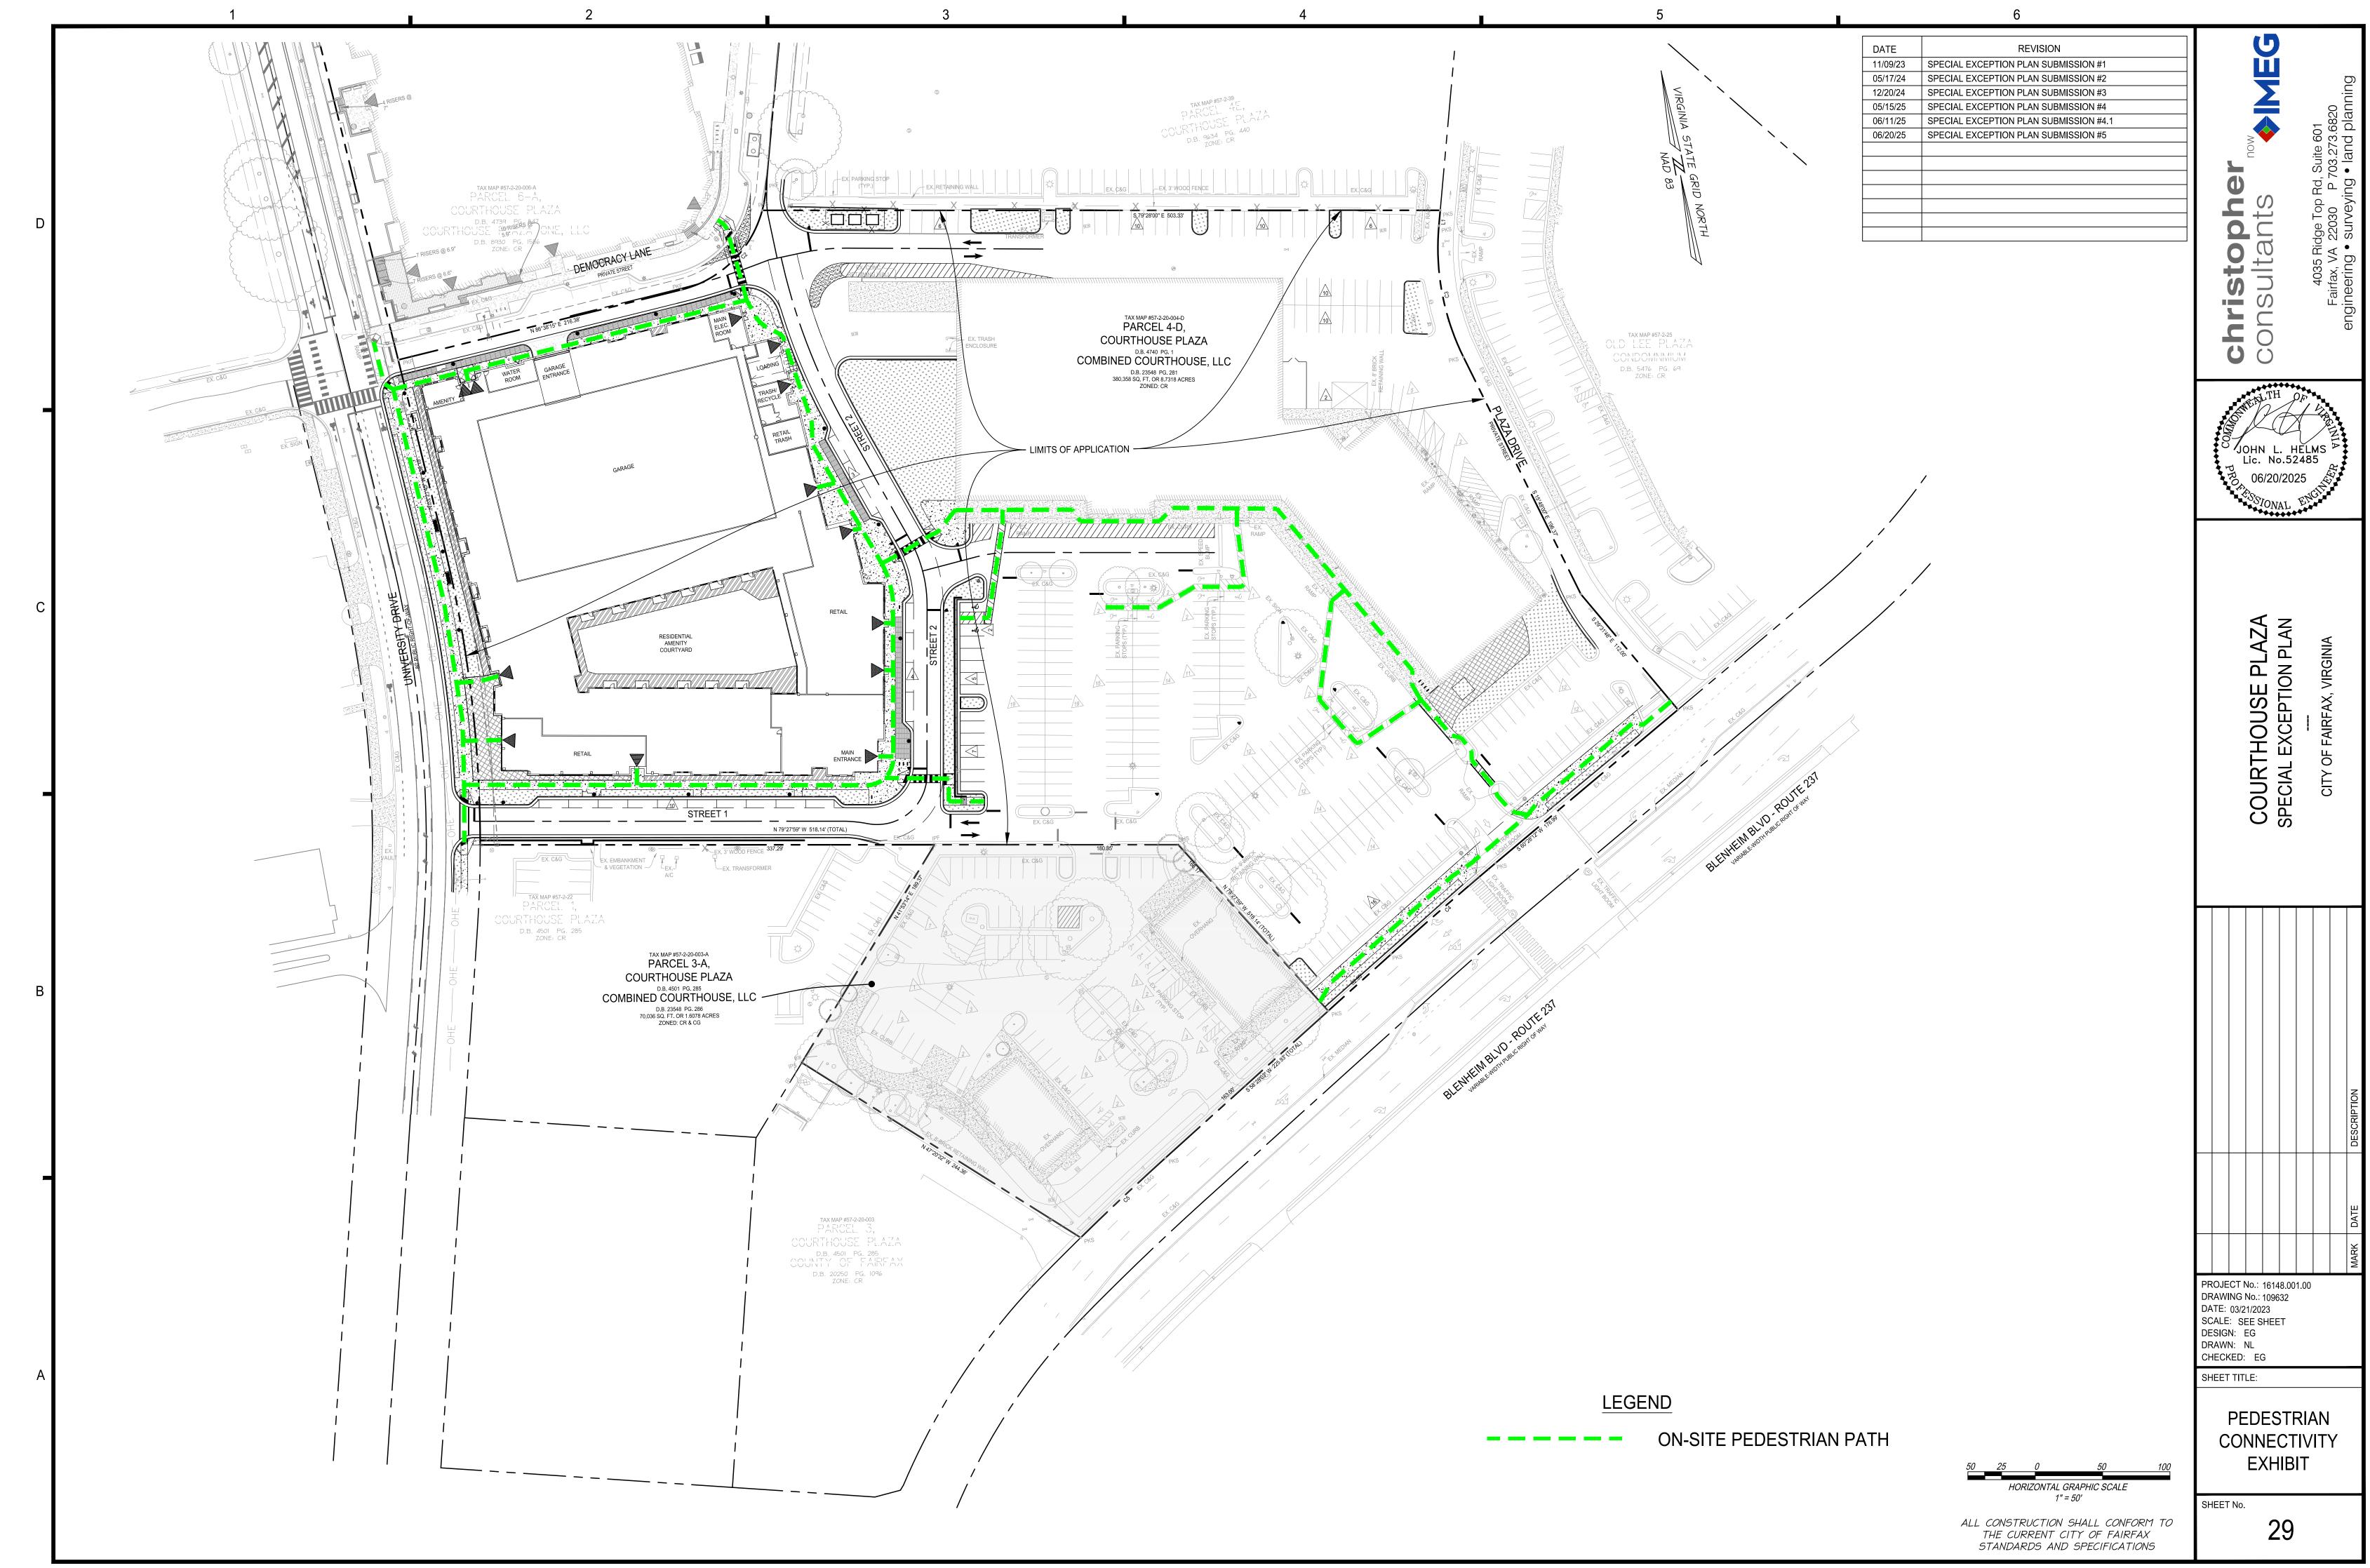17,814 SF

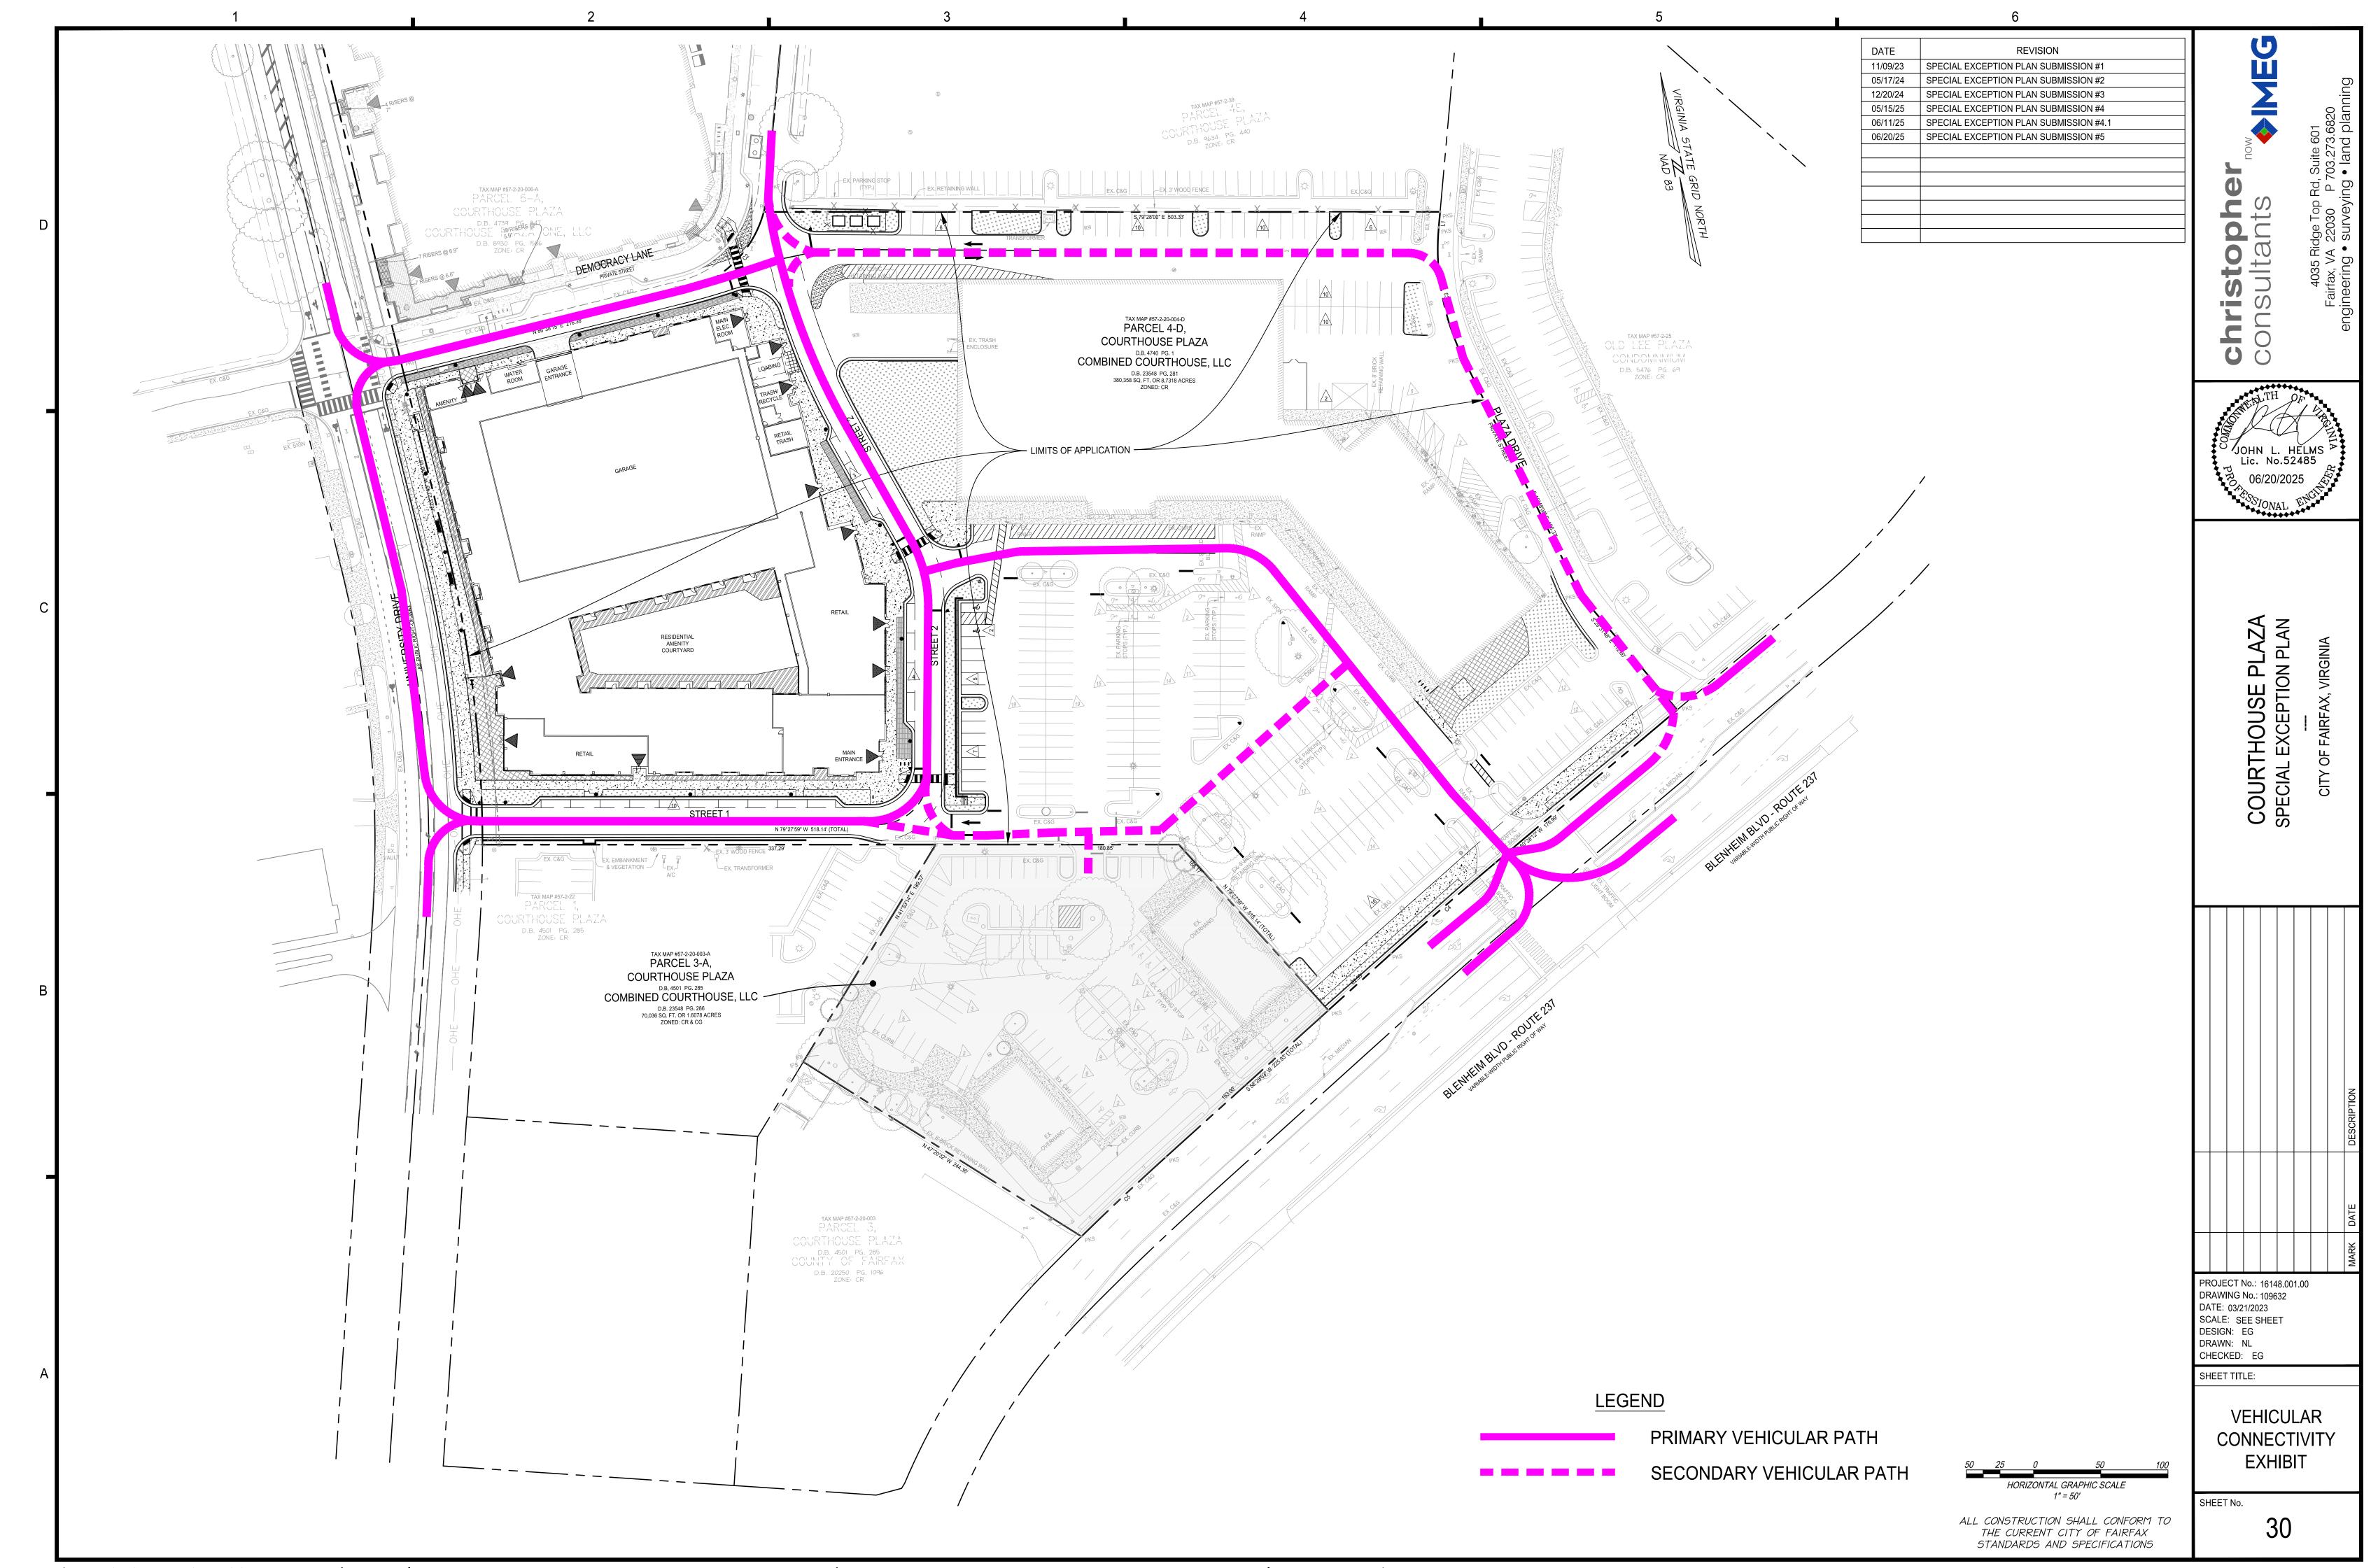ENHANCED HARDSCAPE

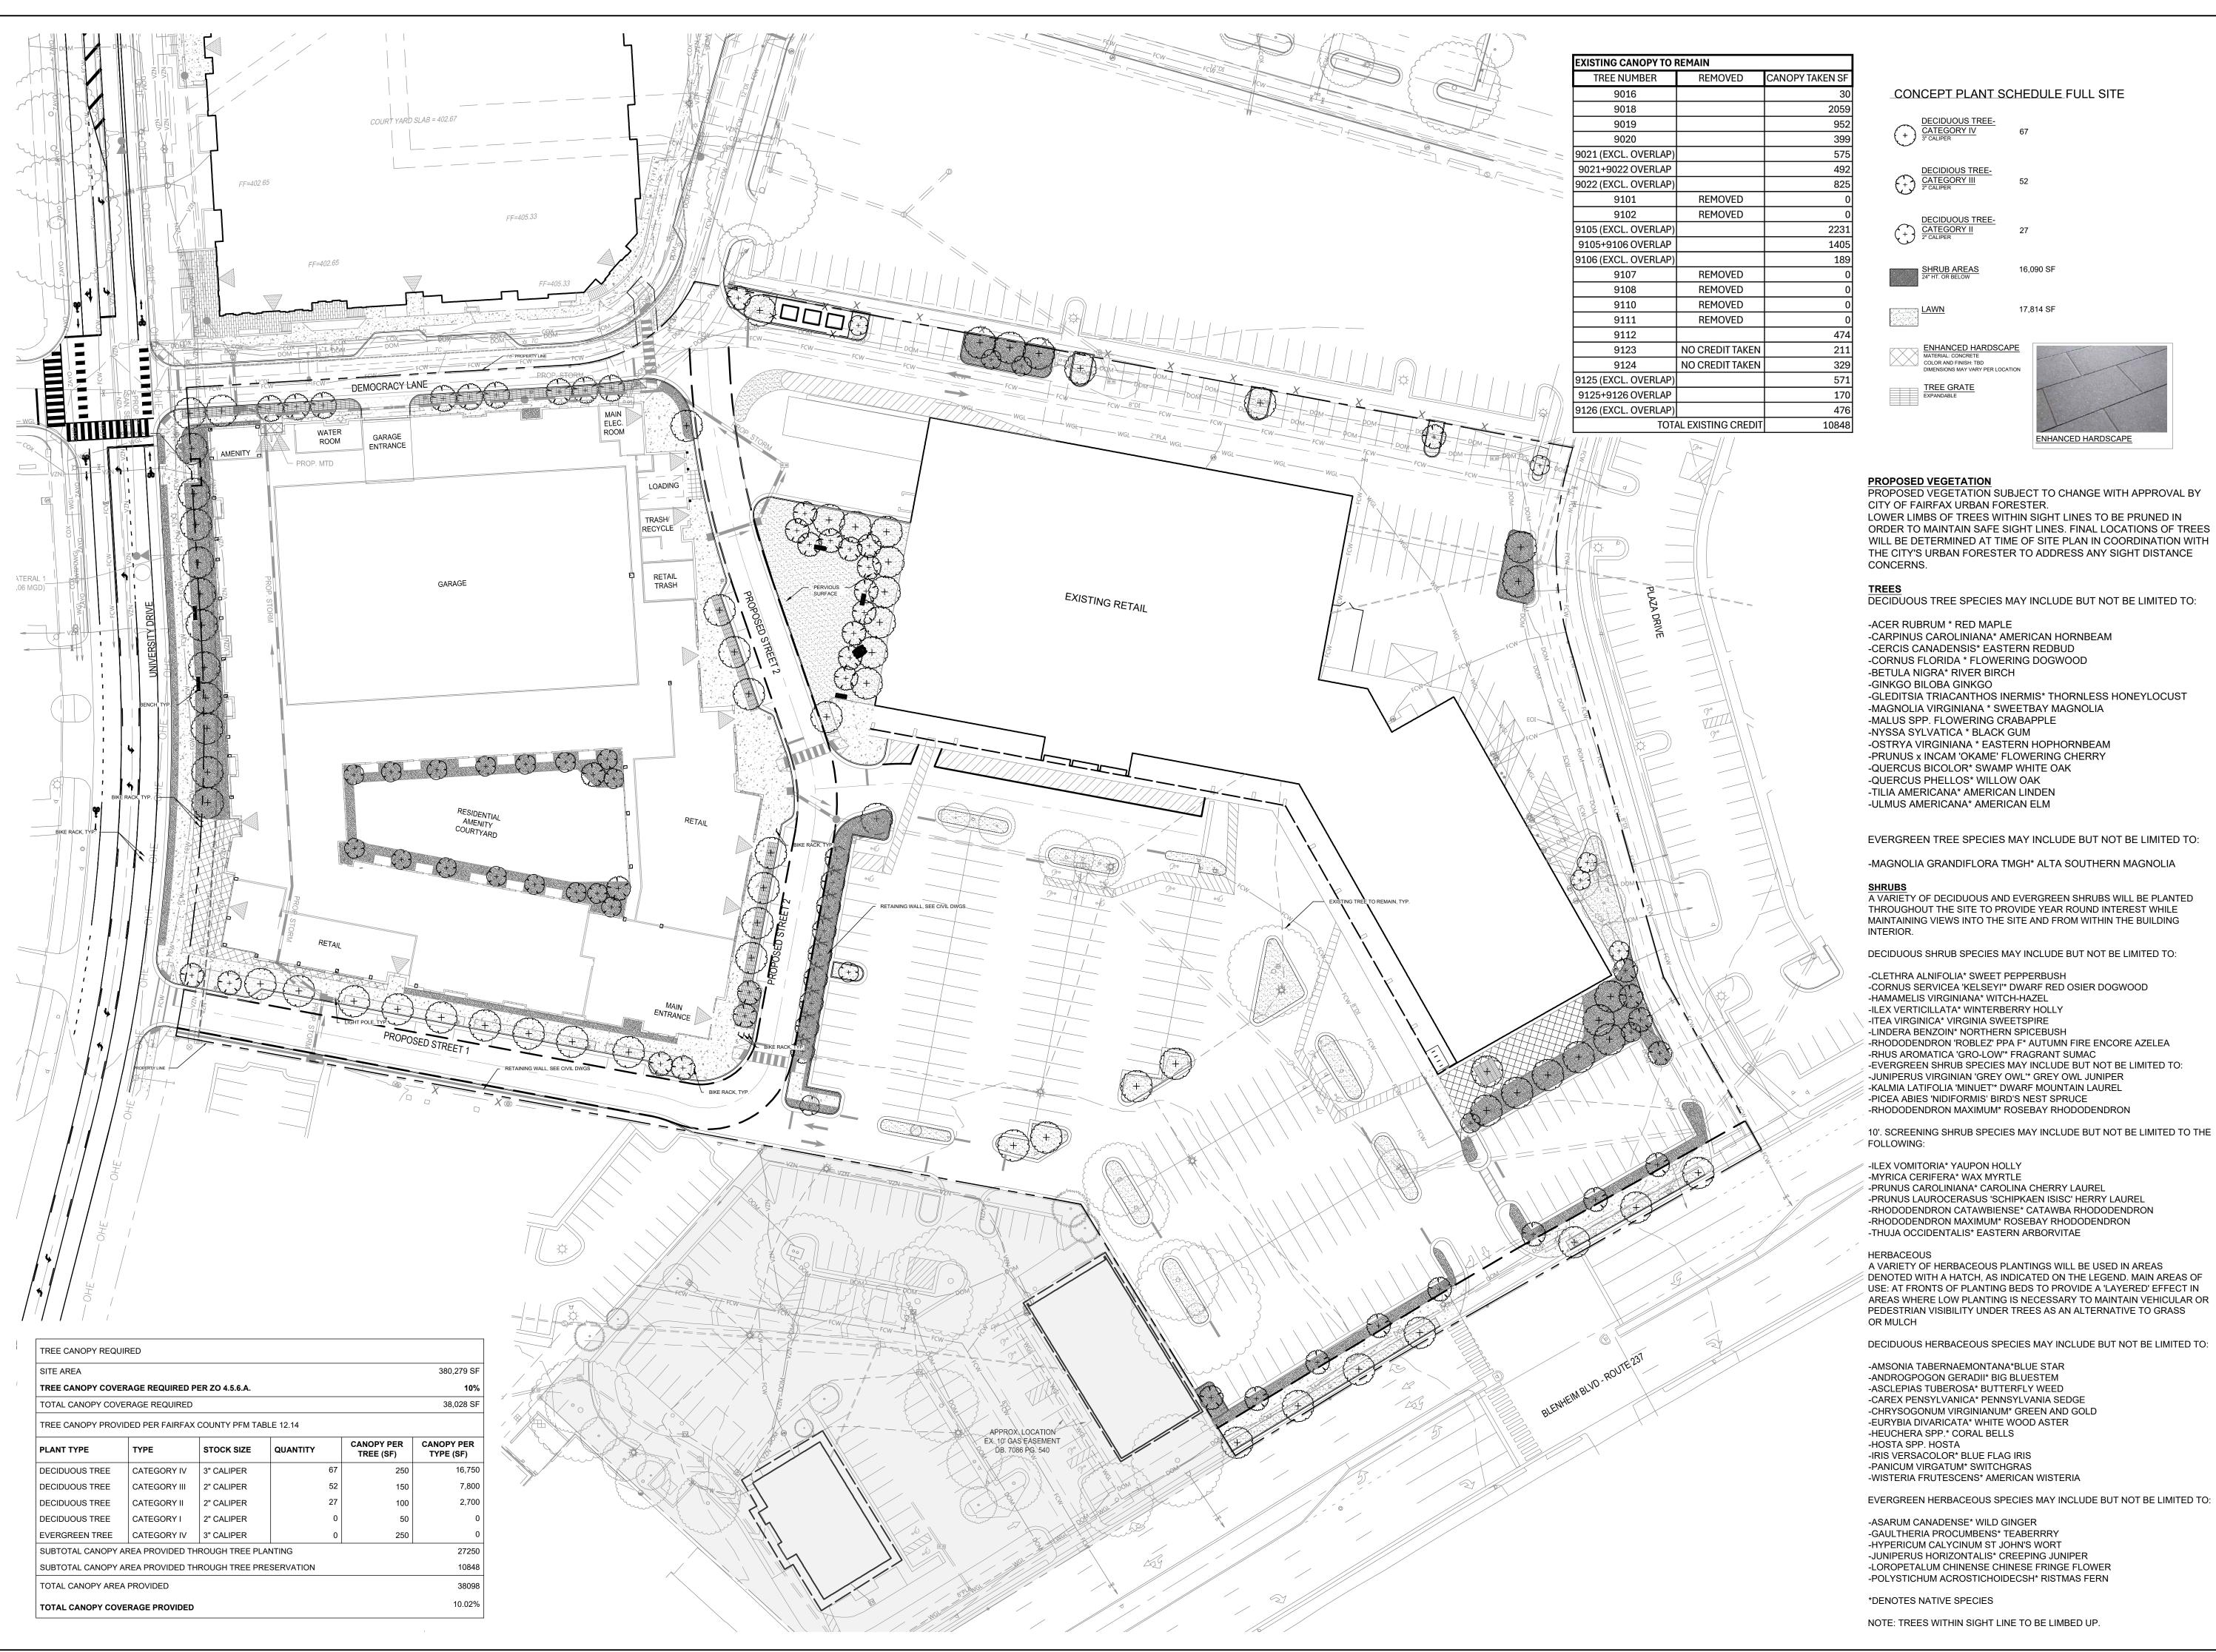


COURTHOUSE **PLAZA**


COMBINED COURTHOUSE LLC 3922 BLENHEIM BOULEVARD FAIRFAX, VA

2023062 REVISION / ISSUANCE DESCRIPTION SE 1ST SUBMISSION SE RESUBMISSION SE RESUBMISSION 2024-12-20 4 SE RESUBMISSION 2025-05-13 4.1 SE RESUBMISSION 2025-06-11 5 SE RESUBMISSION 2025-06-20

> DESIGNED BY: GC DRAWN BY: JVW/DC CHECKED BY: GC/JVW

CONCEPTUAL LANDSCAPE PLAN

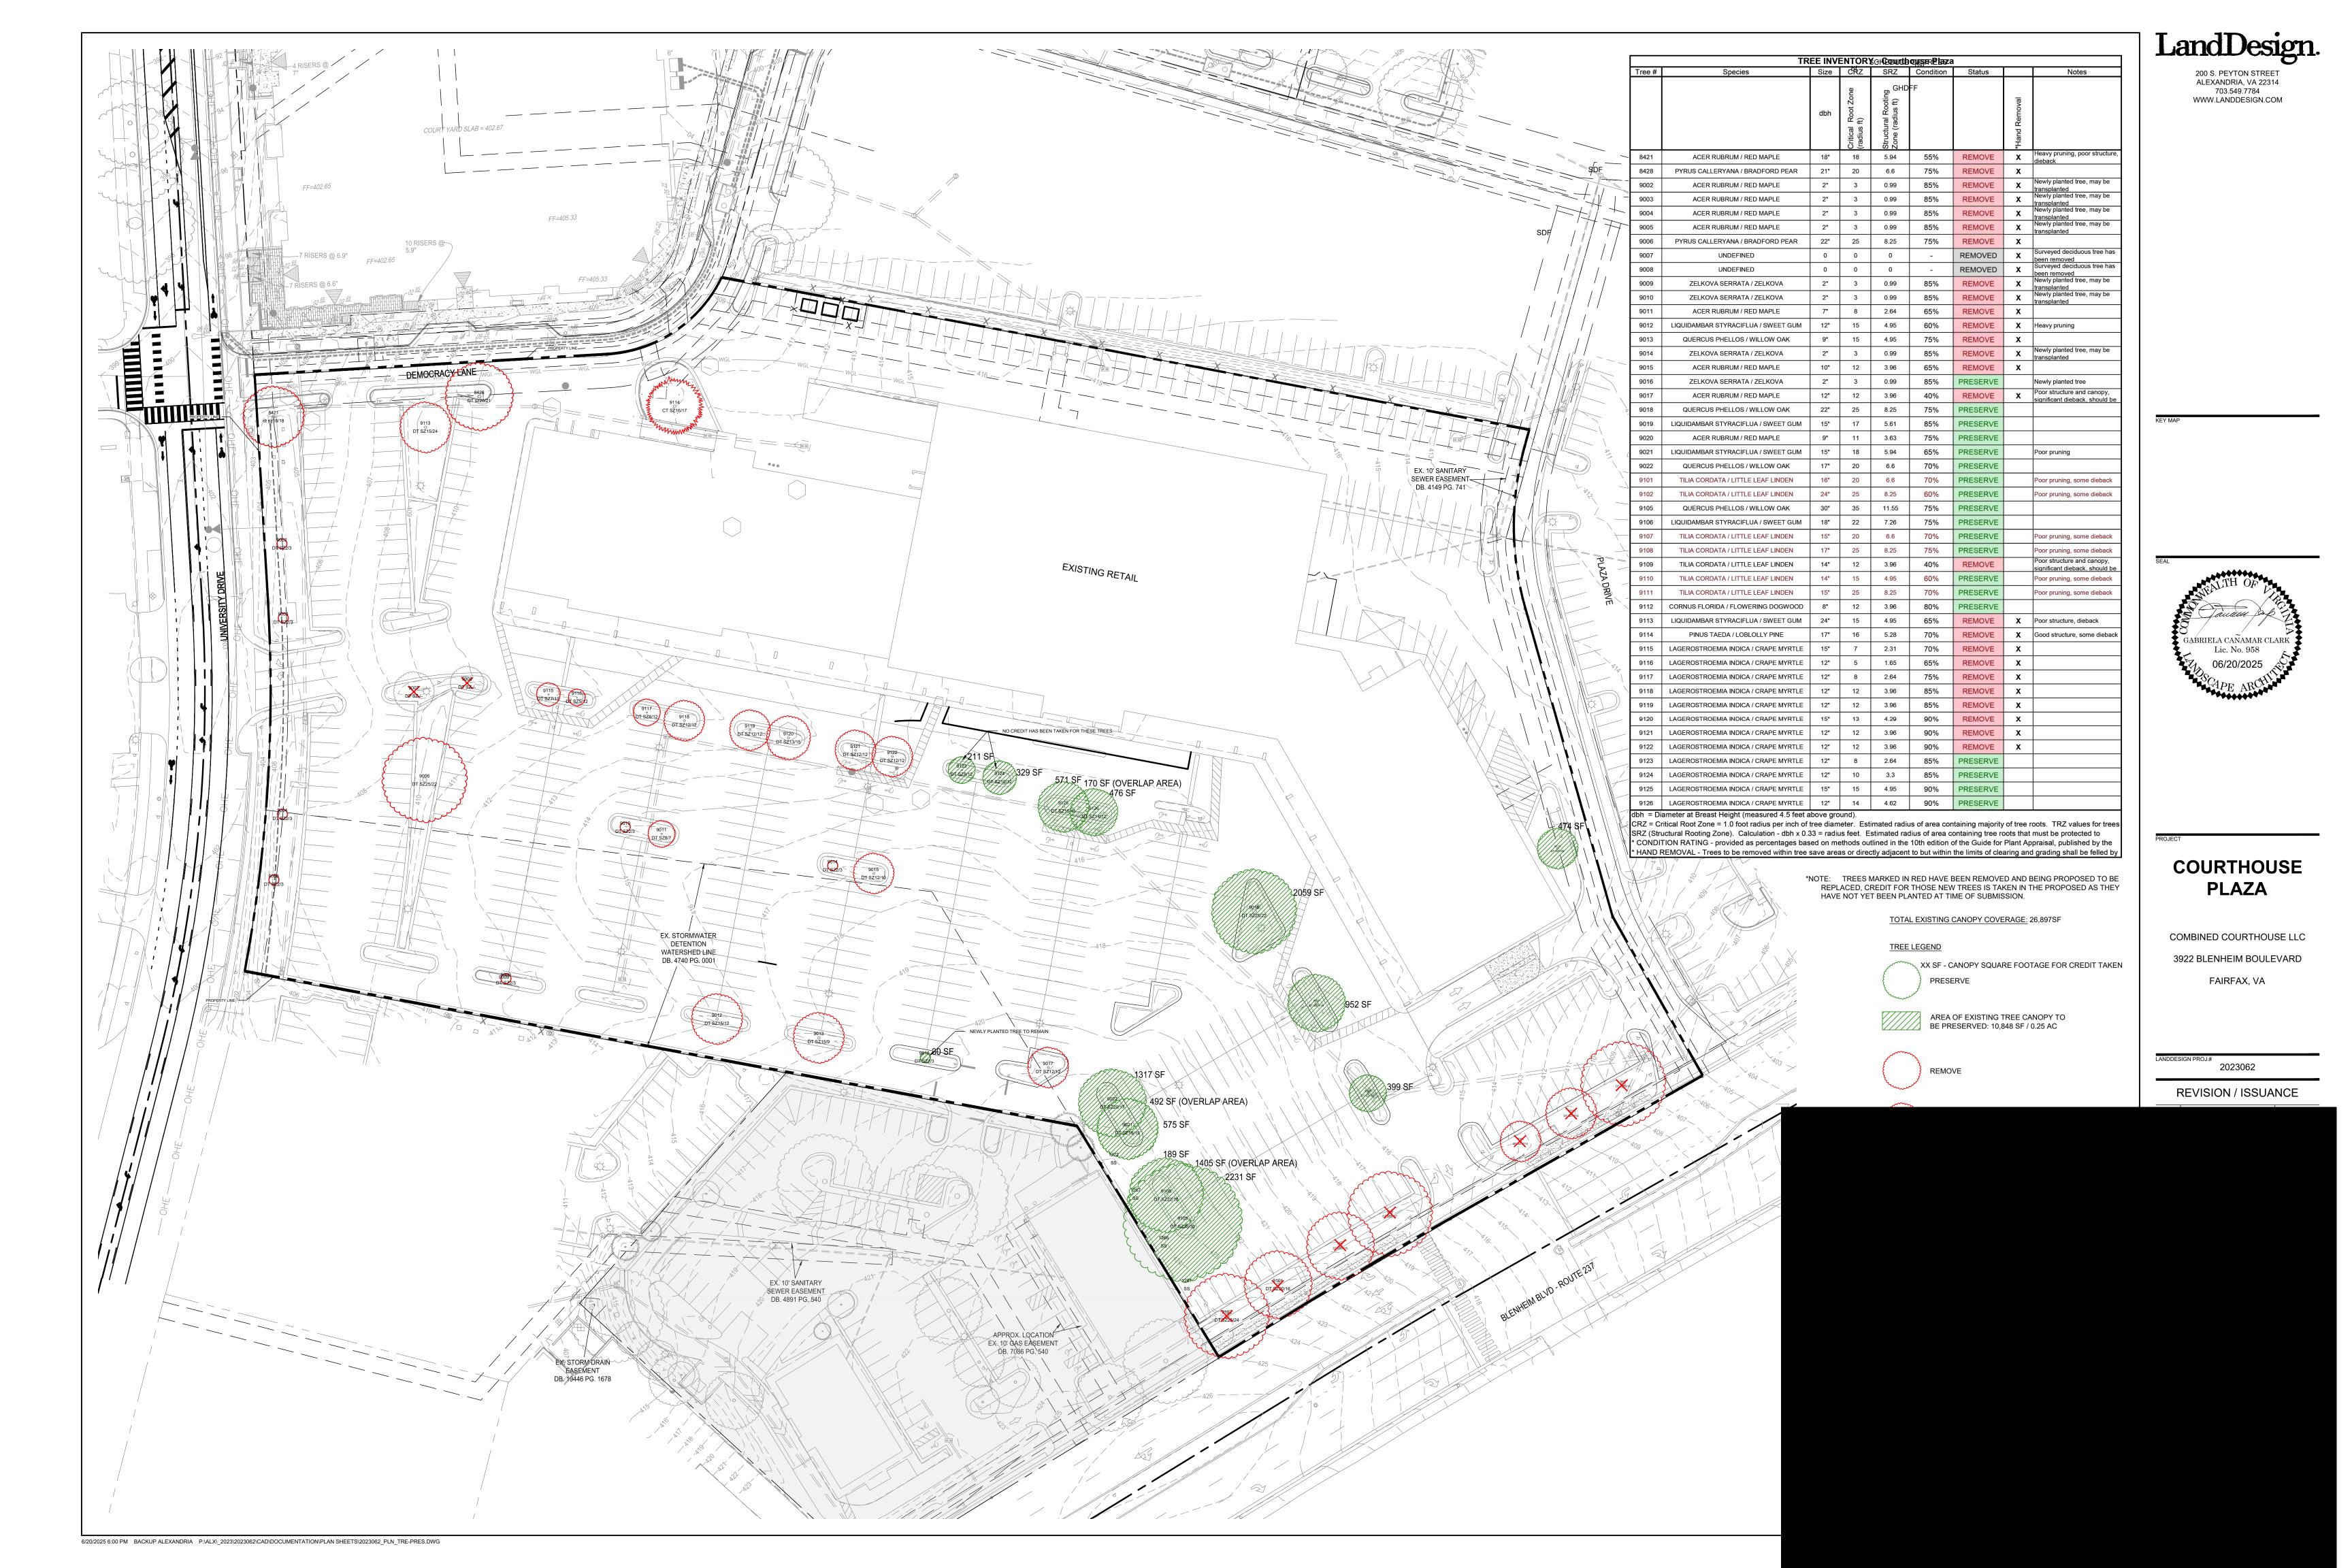

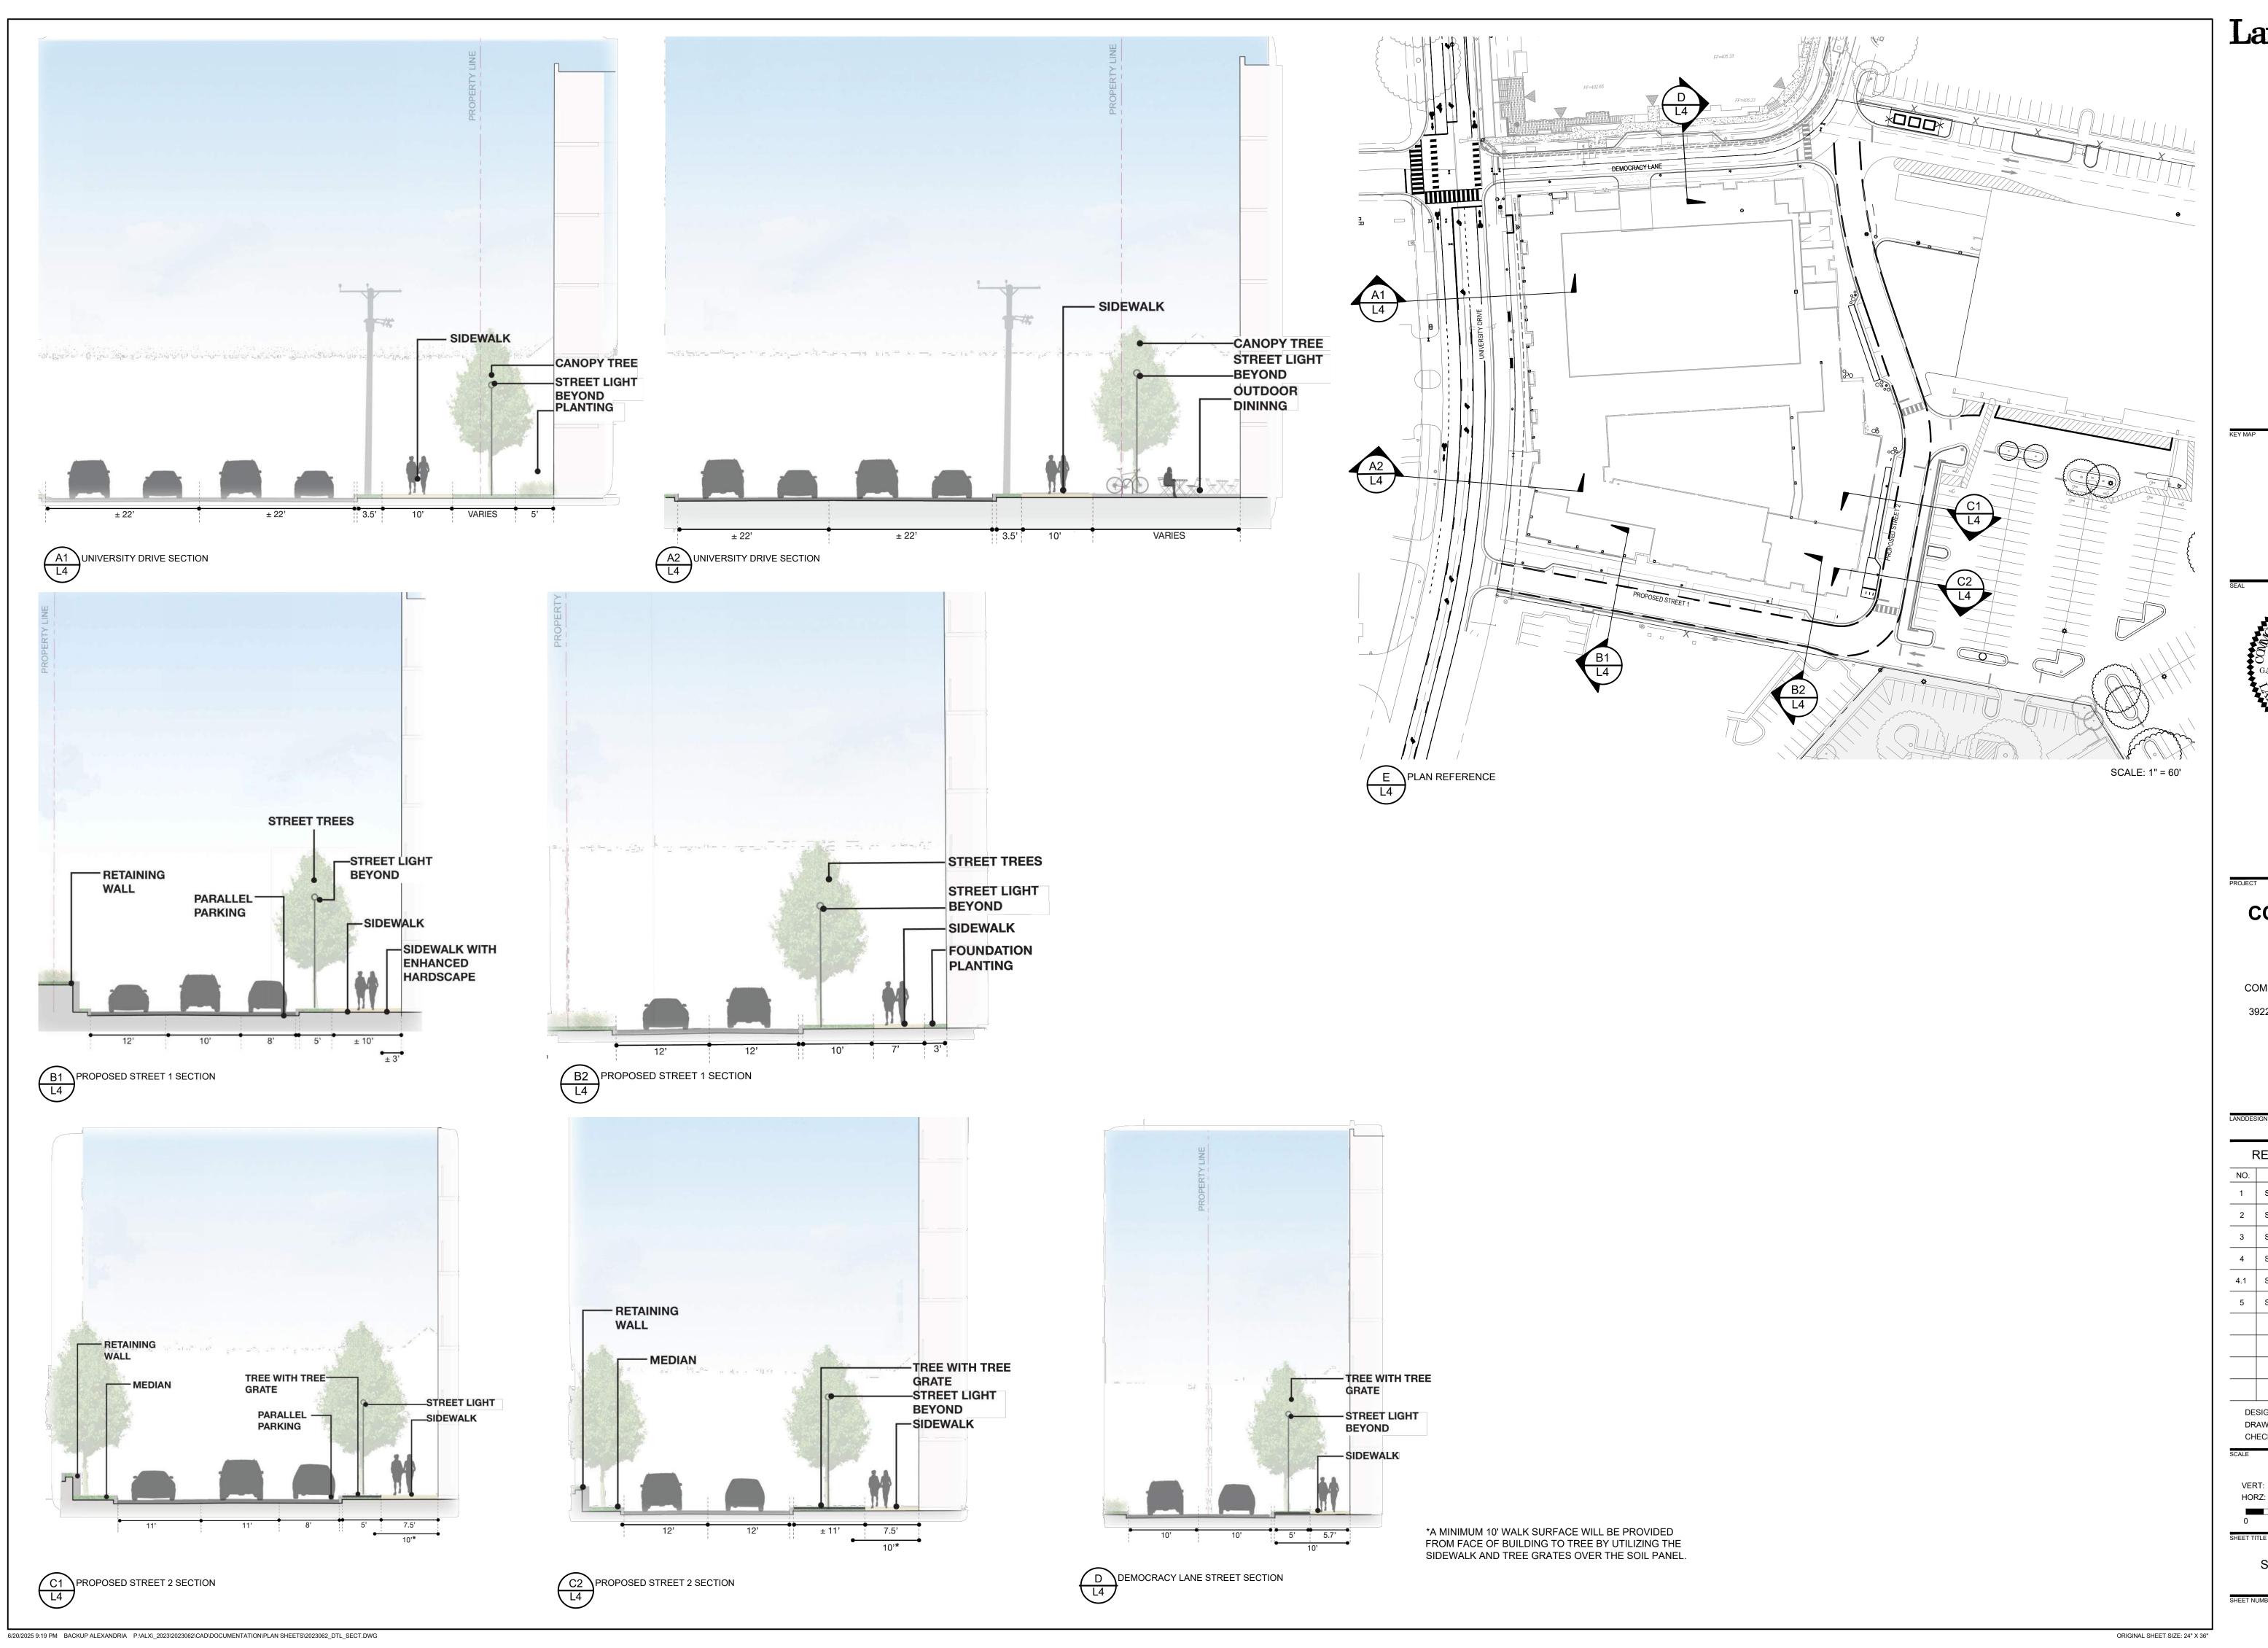

LandDesign.

200 S. PEYTON STREET ALEXANDRIA, VA 22314 703.549.7784 WWW.LANDDESIGN.COM

GABRIELA CAÑAMAR CLARK
Lic. No. 958
06/20/2025
CAPE ARCHIE

COURTHOUSE PLAZA


COMBINED COURTHOUSE LLC
3922 BLENHEIM BOULEVARD
FAIRFAX, VA

F	REVISION / ISSUA	ANCE		
NO.	DESCRIPTION	DATE		
1	SE 1ST SUBMISSION	2023-11-09		
2	SE RESUBMISSION	2024-05-17		
3	SE RESUBMISSION	2024-12-20		
4	SE RESUBMISSION	2025-05-13		
4.1	SE RESUBMISSION	2025-06-11		
5	SE RESUBMISSION	2025-06-20		
DESIGNED BY: GC				
DRAWN BY: JVW/DC CHECKED BY: GC/JVW				

VERT: N/A HORZ: 1"=10'

STREET SECTIONS

IBER L4

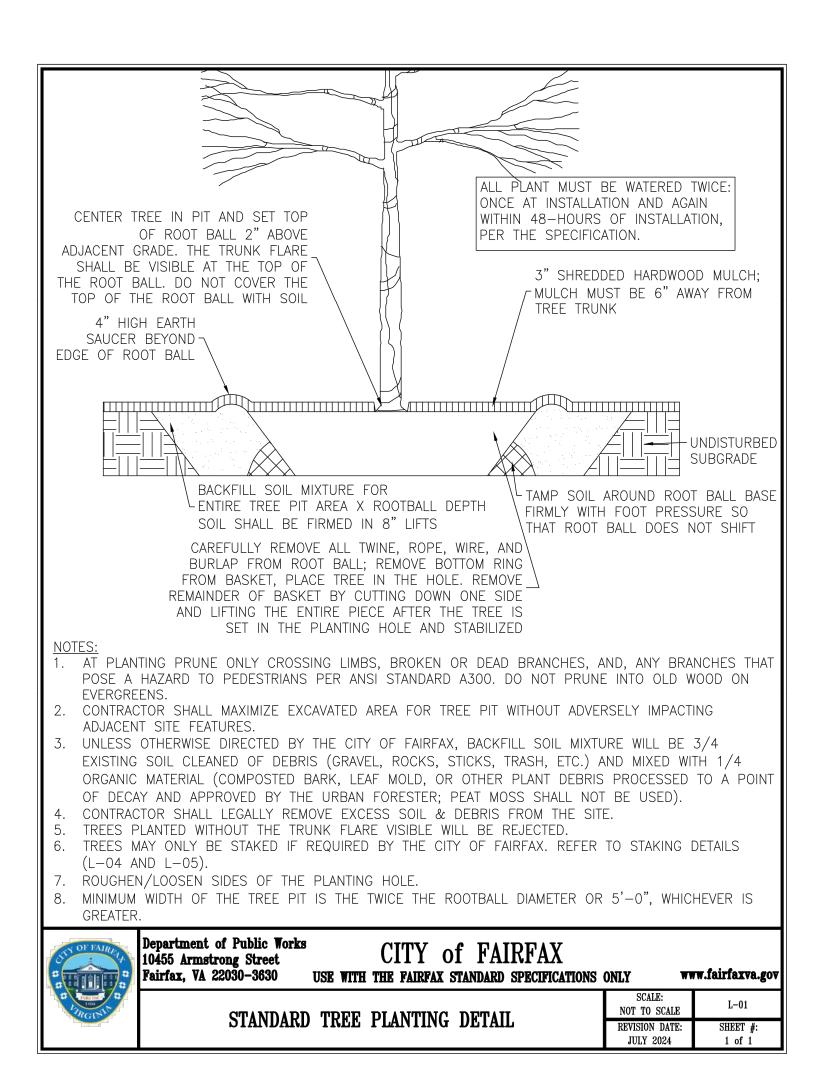

SHRUB

REFER TO

PLANTING PLAN

& PLANT LIST

FOR SPACING

SHRUB BED

COMPACTED BACKFILL SOIL MIXTURE FROM TOP 2/3 OF ROOT BALL

AT PLANTING PRUNE ONLY BROKEN OR DEAD BRANCHES PER ANSI A300 STANDARD.

AND APPROVED BY THE CITY OF FAIRFAX. PEAT MOSS MAY NOT BE USED).

CONTRACTOR SHALL REMOVE EXCESS SOIL & DEBRIS FROM SITE.

DO NOT PLACE MULCH IN CONTACT WITH STEM OF SHRUBS.

partment of Public Works

0455 Armstrong Street

2. PLANTING PIT/TRENCH SHALL BE DUG DEEP ENOUGH TO ALLOW AT LEAST 1/8TH OF ROOT BALL TO

4. UNLESS OTHERWISE DIRECTED BY THE CITY OF FAIRFAX, BACKFILL SOIL MIXTURE WILL BE $\frac{3}{4}$ EXISTING

MATERIAL (COMPOSTED BARK, LEAF MOLD, OR OTHER PLANT DEBRIS PROCESSED TO A POINT DECAY

CITY of FAIRFAX

SOIL CLEANED OF DEBRIS (GRAVEL, ROCKS, STICKS, TRASH, ETC.) AND MIXED WITH 1 ORGANIC

3. SET PLANT IN ERECT, STABLE, AND UNIFORM POSITIONS IN THE CENTER OF THE PLANTING PIT.

Fairfax, VA 22030-3630 USE WITH THE FAIRFAX STANDARD SPECIFICATIONS ONLY

MULCH OVER ENTIRE

PLACE TOP 1/8 OF ROOT BALL

ABOVE FINISHED GRADE (TYP.)

REMOVE ALL TWINE, ROPE, WIRE, AND BURLAP

3" SHREDDED HARDWOOD

TYPICAL SHRUB PLACEMENT NEAR PARKING LOTS NOT TO SCALE

PARKING LO

-BACKFILL SOIL

MIXTURE (TYP.)

r FINISHED

www.fairfaxva.gov

NOT TO SCALE

L-06

GRADE

FOR CONTAINER: LOOSEN

ROOT BALL OF ANY ROOT

BOUND PLANTS

THIS DETAIL SUPERSEDES ALL

OF FAIRFAX.

ALL PLANTS MUST BE WATERED

AGAIN WITHIN 48-HOURS OF

INSTALLATION, PER THE

SPECIFICATIONS.

TWICE: ONCE AT INSTALLATION AND

OTHER SHRUB PLANTING DETAILS IN THE CITY


2 X WIDTH


◆OF ROOT BALL →


ORIENT BEST FACE OF PLANT TO BE THE MOST VISIBLE.

LUNDISTURBED SUBGRADE OR

BE SET ABOVE EXISTING GRADE.

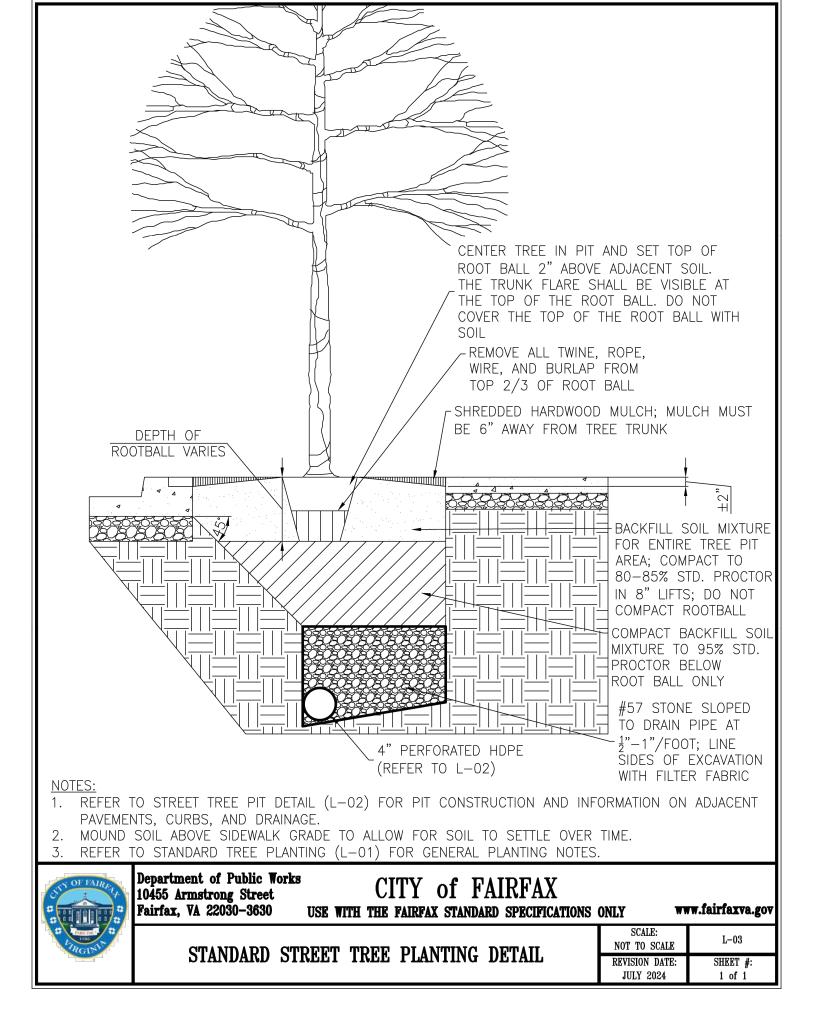

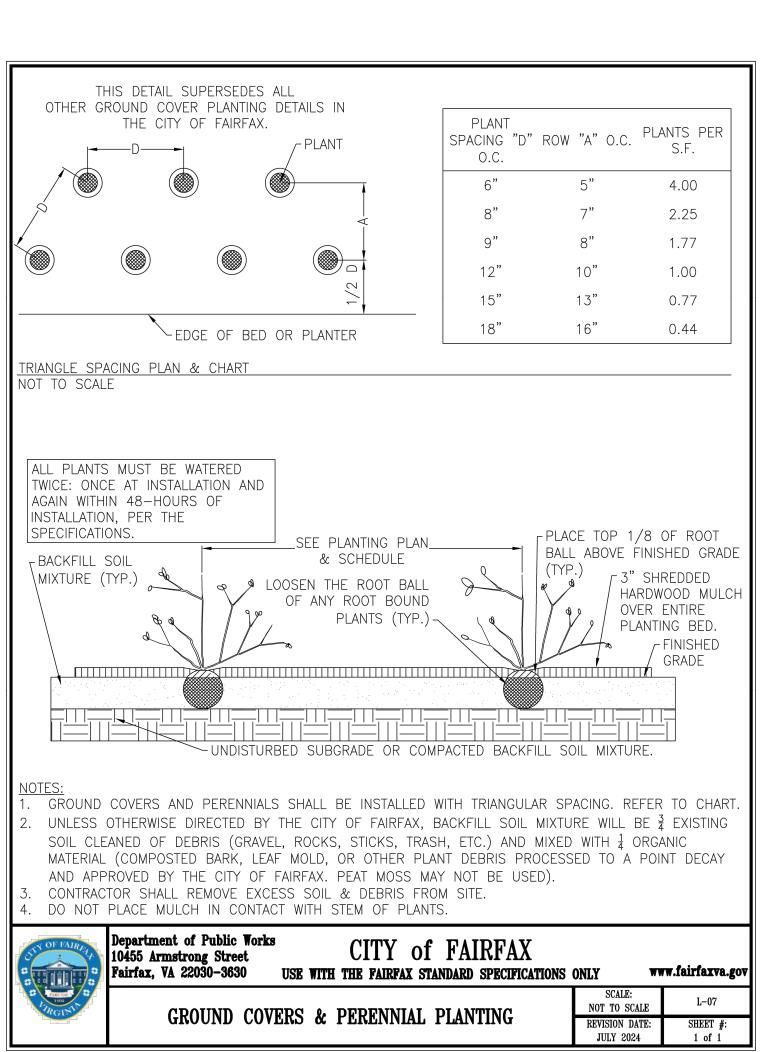

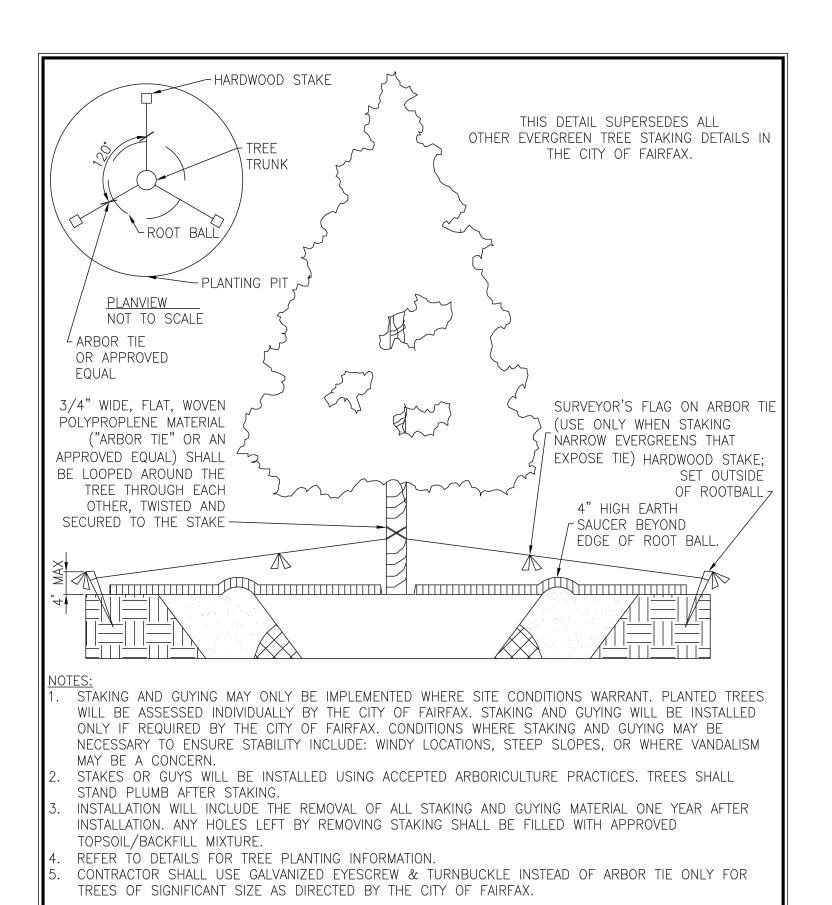

partment of Public Works CITY of FAIRFAX 0455 Armstrong Street Fairfax, VA 22030-3630 USE WITH THE FAIRFAX STANDARD SPECIFICATIONS ONLY www.fairfaxva.gov L-05 NOT TO SCALE EVERGREEN TREE STAKING DETAIL REVISION DATE: JULY 2024

The requirements of the City of Fairfax Zoning Ordinance and Public Facilities Manual shall be followed. No changes shall be made to tree conservation unless directed or approved by Fairfax City Urban

All tree conservation activities shall be performed under the direct supervision of an ISA Certified Arborist and follow most recent ANSI standards for tree care.

Prior to the pre-construction meeting, the contractor shall have the limits of clearing and grading clearly marked in the field with flagging. These limits shall not exceed those shown on the approved

Prior to installation of erosion and sediment controls, grading, demolition, or other disturbance, including tree removal, a pre-construction meeting shall be held with Fairfax City Urban Forester. Changes to the plan, based on field conditions, may be requested by the Urban Forester at the time

of the pre-construction meeting. Removal of trees, noted for removal on the plan, inside a tree preservation area shall be performed, by hand, without ground disturbance, or disturbance to nearby preserved trees. Trees in these areas shall be cut flush to the ground, without stump grinding. If stump grinding is necessary then approval

by Fairfax City Urban Forester may be requested. All pruning shall be in accordance to most recent ANSI standards for tree care. Any tree maintenance not in accordance with these standards may be a violation of the zoning ordinance. If additional pruning is needed to meet clearance standards for rights of way approval by Fairfax City Urban

No person shall remove or destroy any tree which is five (5) inches or greater at standard height (4.5 feet from base of ground), on any residential zone lot greater than one-half acre and in all other zoned districts without first obtaining a tree removal permit from the zoning administrator. Any tree removed, damaged or destroyed will be replaced at the discretion of the zoning administrator. The contractor shall not disturb and shall protect all trees and shrubs outside of construction limits, including trees on other properties, or rights-of-way.


Tree protection areas shall have all non-native invasive vines removed at the end of the project. An invasive management plan shall be provided when deemed necessary by Fairfax City Urban Forester or per the approved plan to ensure tree survival. Tree protection area shall be covered with shredded hardwood mulch, or other organic mulch as approved by Fairfax City Urban Forester.


Any substitutions or changes to the approved landscape plan shall be requested and approved by Fairfax City Urban Forester prior to installation.

All planting materials and work shall comply with recommendations and requirements of most recent ANSI standards for nursery stock and per the approved plan. Any material below this standard will not be accepted and will require replacement.

Installation of plants shall be within Fairfax City's approved planting seasons approximately March-May or September-December during unfrozen soil conditions. Planting outside these seasons require approval by Fairfax City Urban Forester prior to installation. All material shall be installed within 72 hours from delivery to the project site. An inspection of materials by Fairfax City Urban Forester may be requested with minimum five (5) days notice prior to installation.

At the end of the project, conserved and planted trees must be inspected and approved by Fairfax City Urban Forester. Changes to the plan, based on field conditions, may be requested by the Urban Forester at the time of inspection.

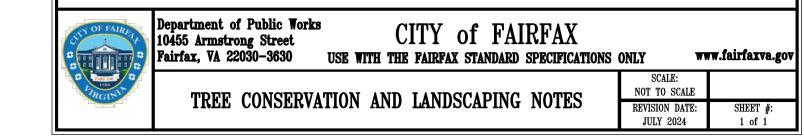

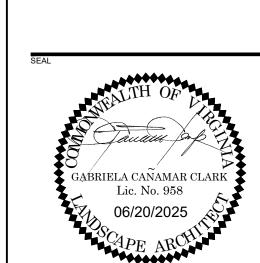

ALEXANDRIA, VA 22314 703.549.7784 WWW.LANDDESIGN.COM

COURTHOUSE **PLAZA**

COMBINED COURTHOUSE LLC 3922 BLENHEIM BOULEVARD FAIRFAX, VA

LANDDES	ign proj.# 2023062					
REVISION / ISSUANCE						
NO.	DESCRIPTION	DATE				
1	SE 1ST SUBMISSION	2023-11-09				
2	SE RESUBMISSION	2024-05-17				
3	SE RESUBMISSION	2024-12-20				
4	SE RESUBMISSION	2025-05-13				
4.1	SE RESUBMISSION	2025-06-11				
5	SE RESUBMISSION	2025-06-20				
	SIGNED BY: GC AWN BY: JVW/DC					

VERT: N/A

HORZ: AS SHOWN

CHECKED BY: GC/JVW


DETAILS - PLANTING


L601


JULY 2024


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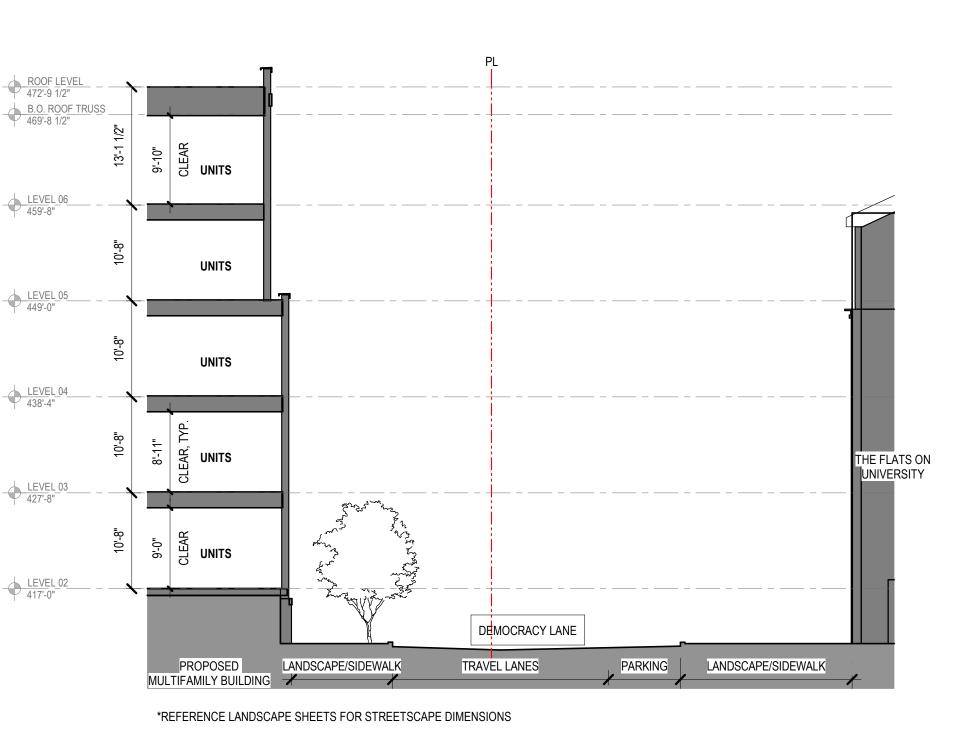
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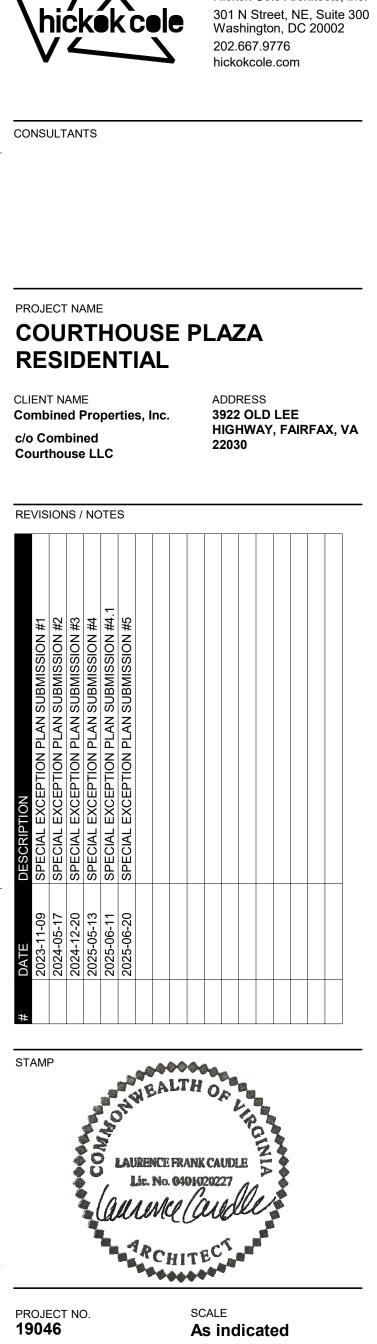




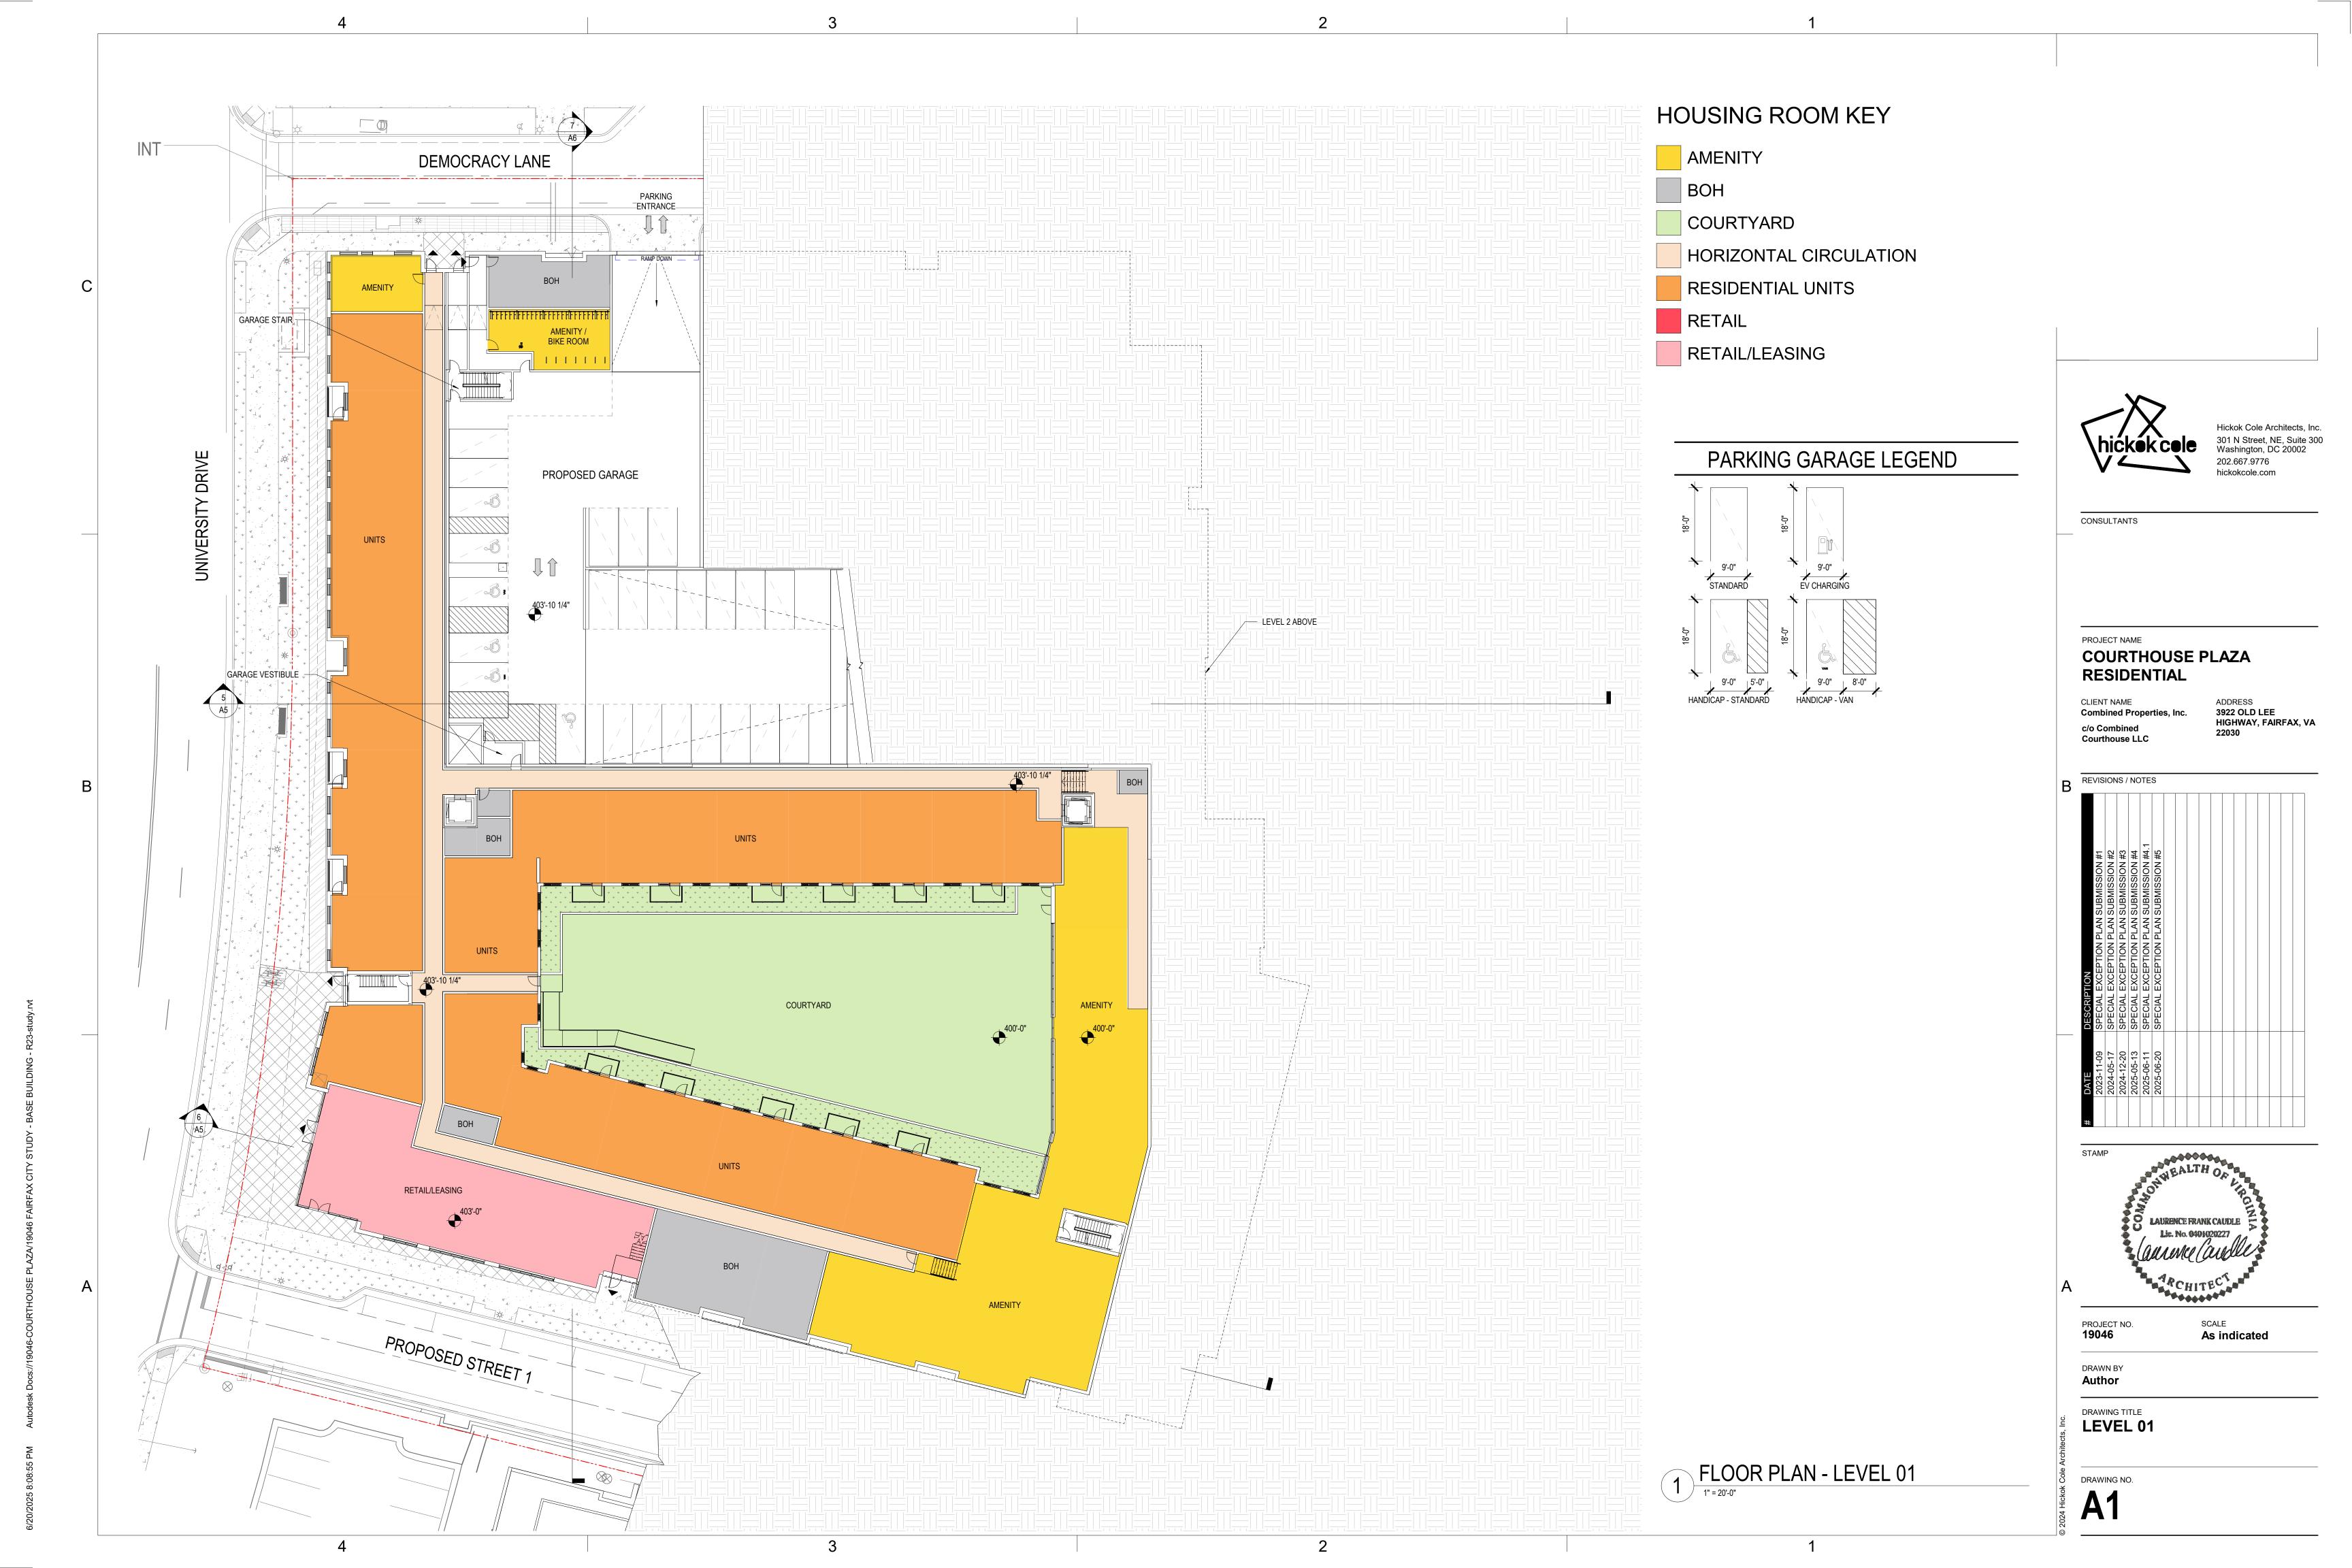

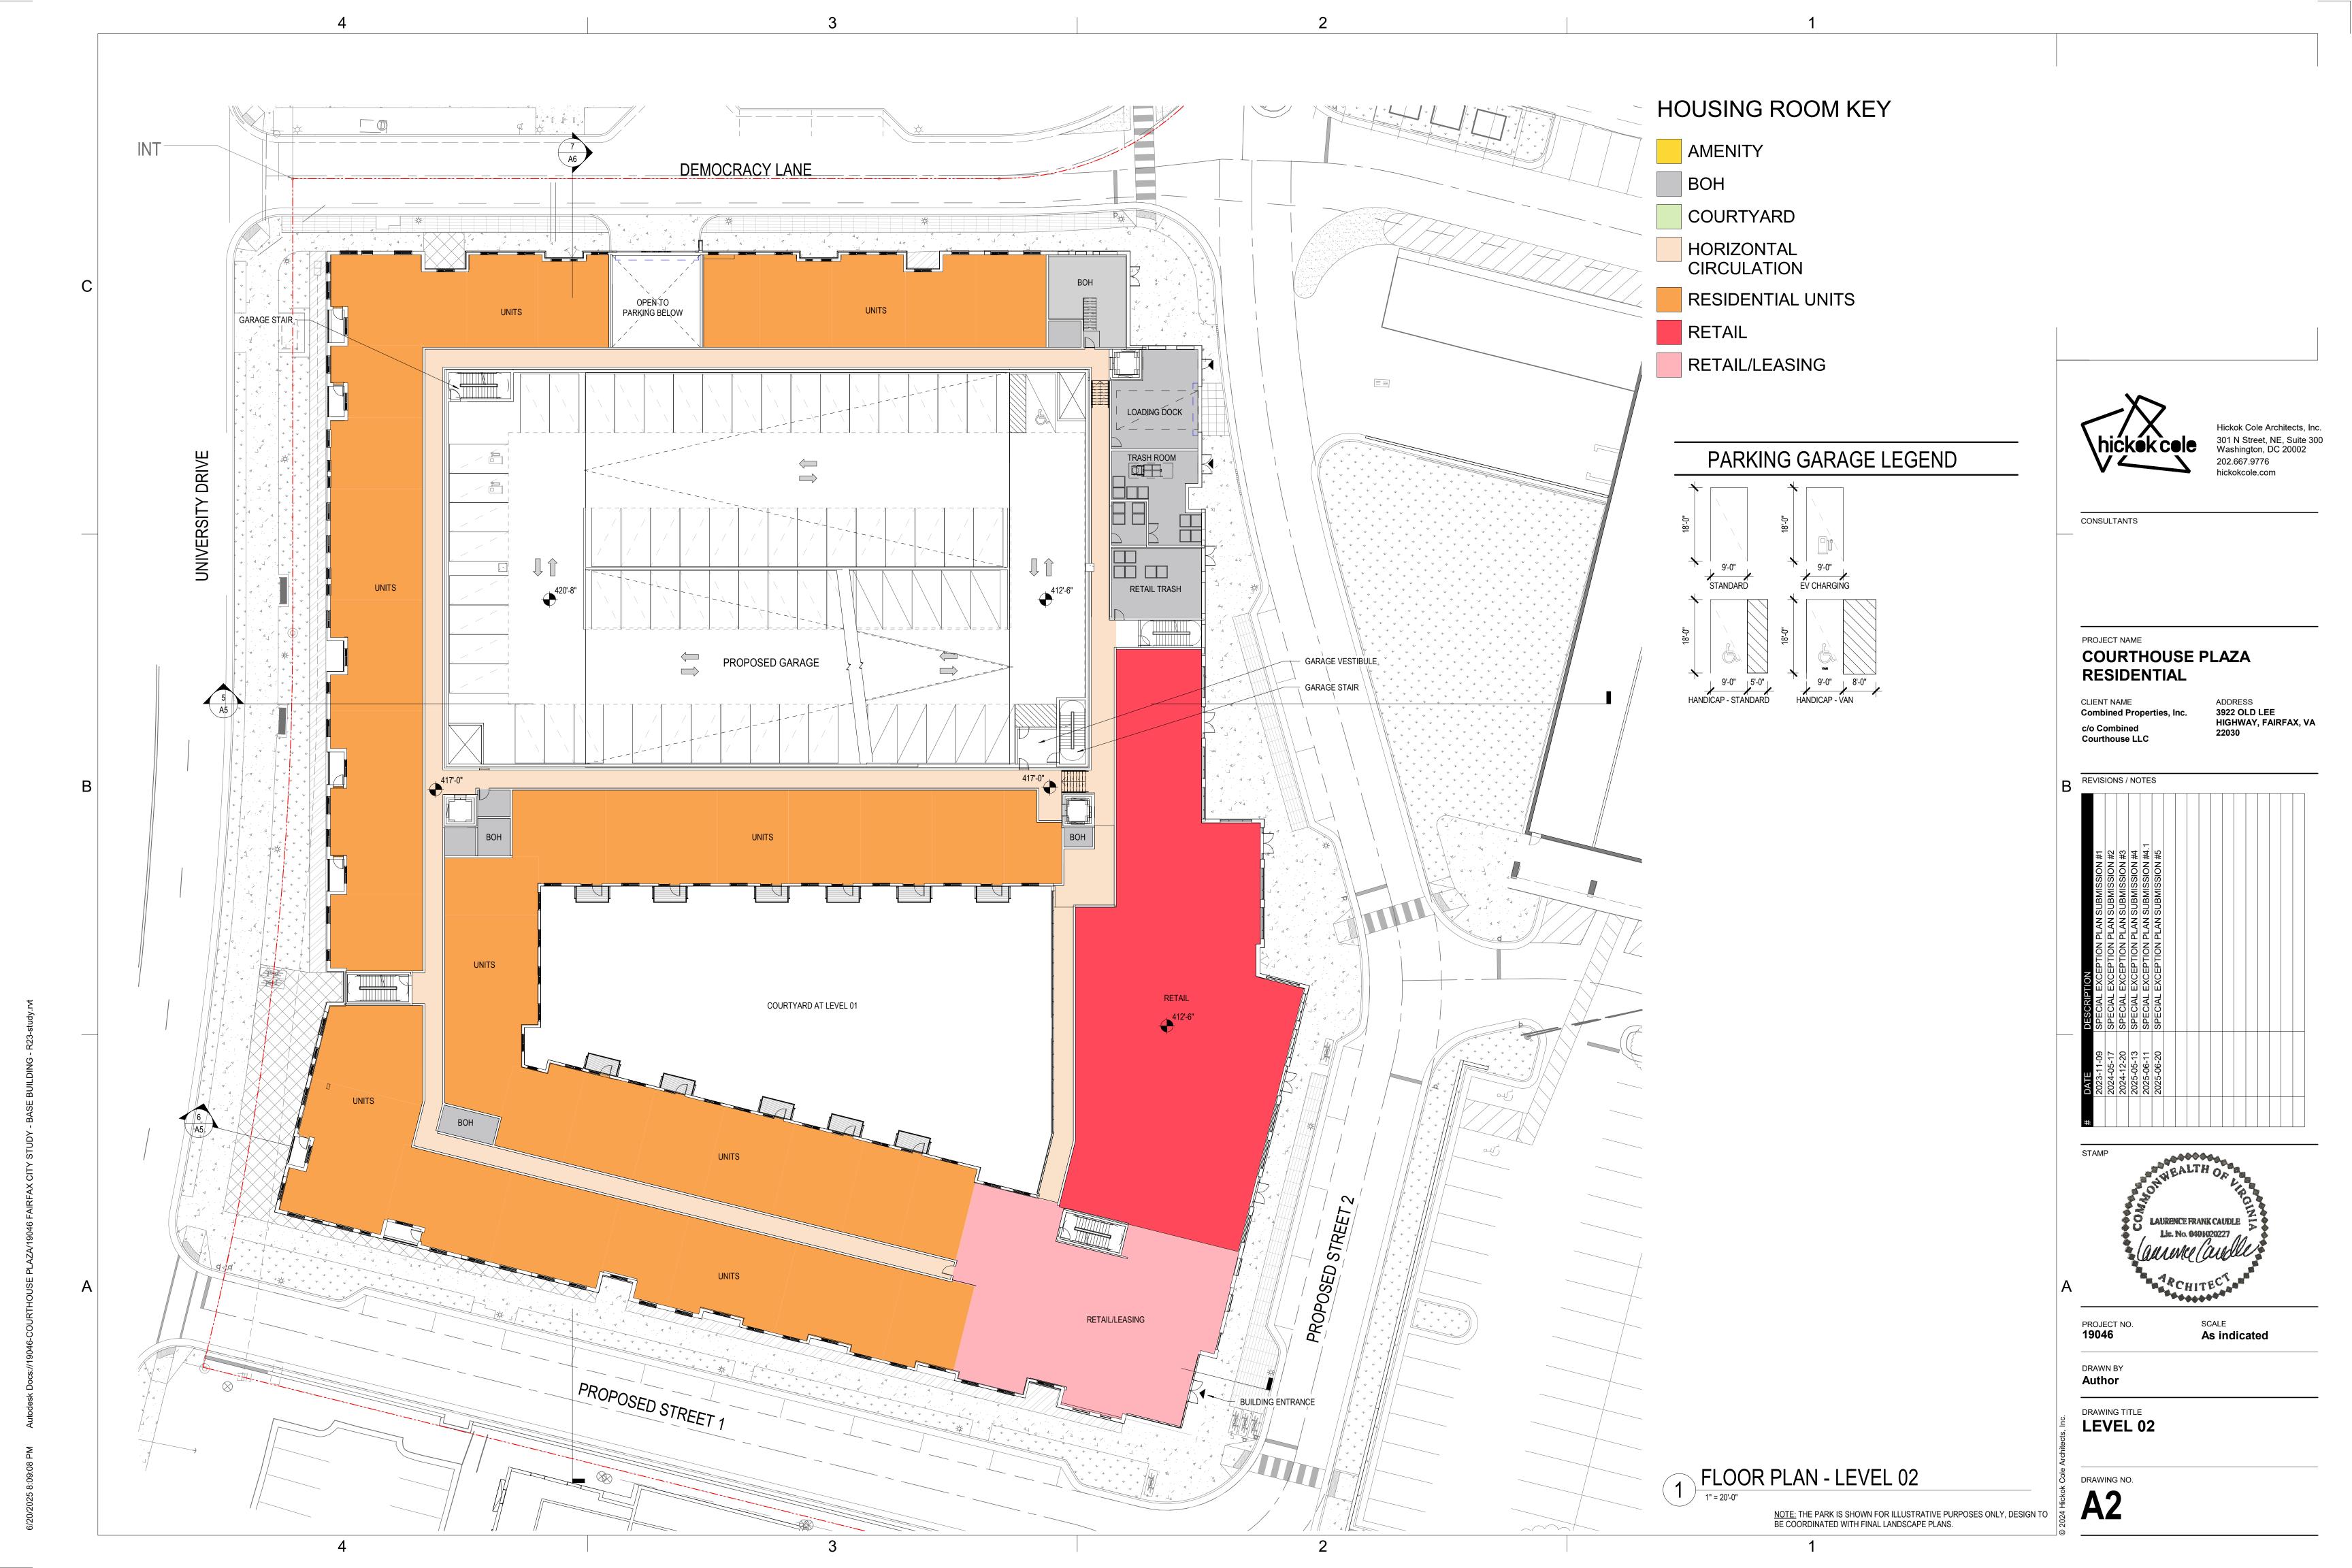LANDSCAPE/SIDEWALK

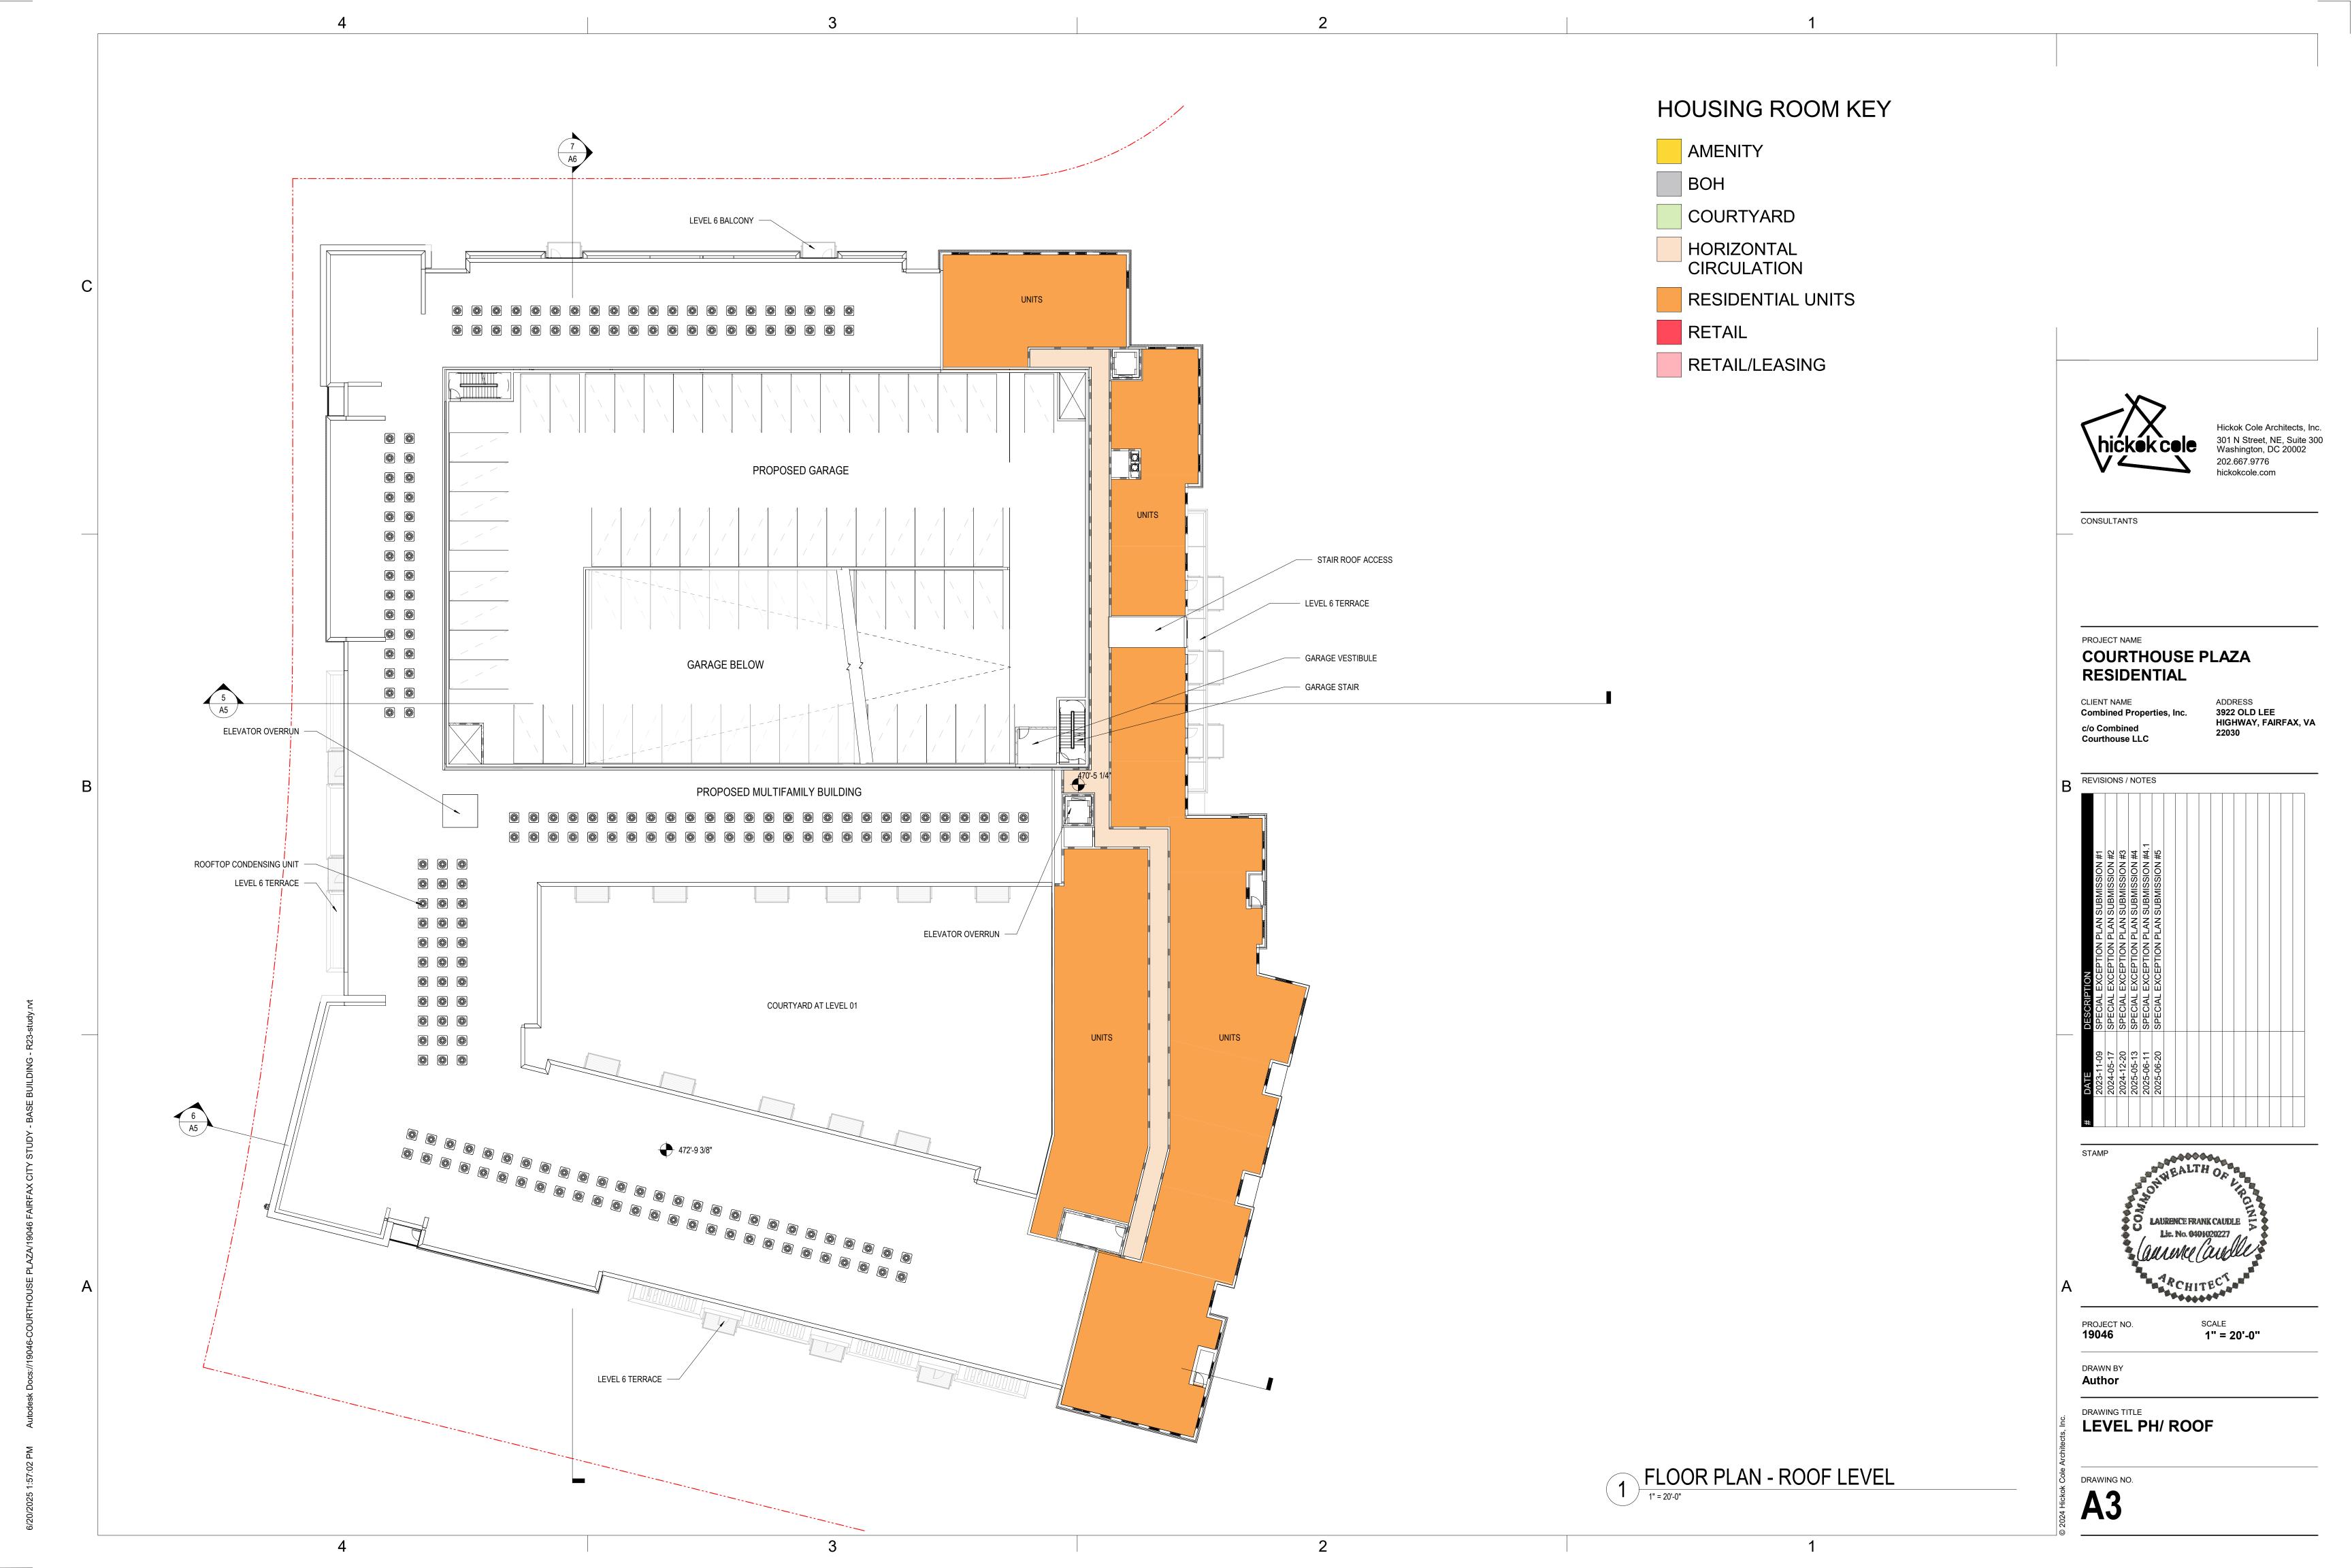

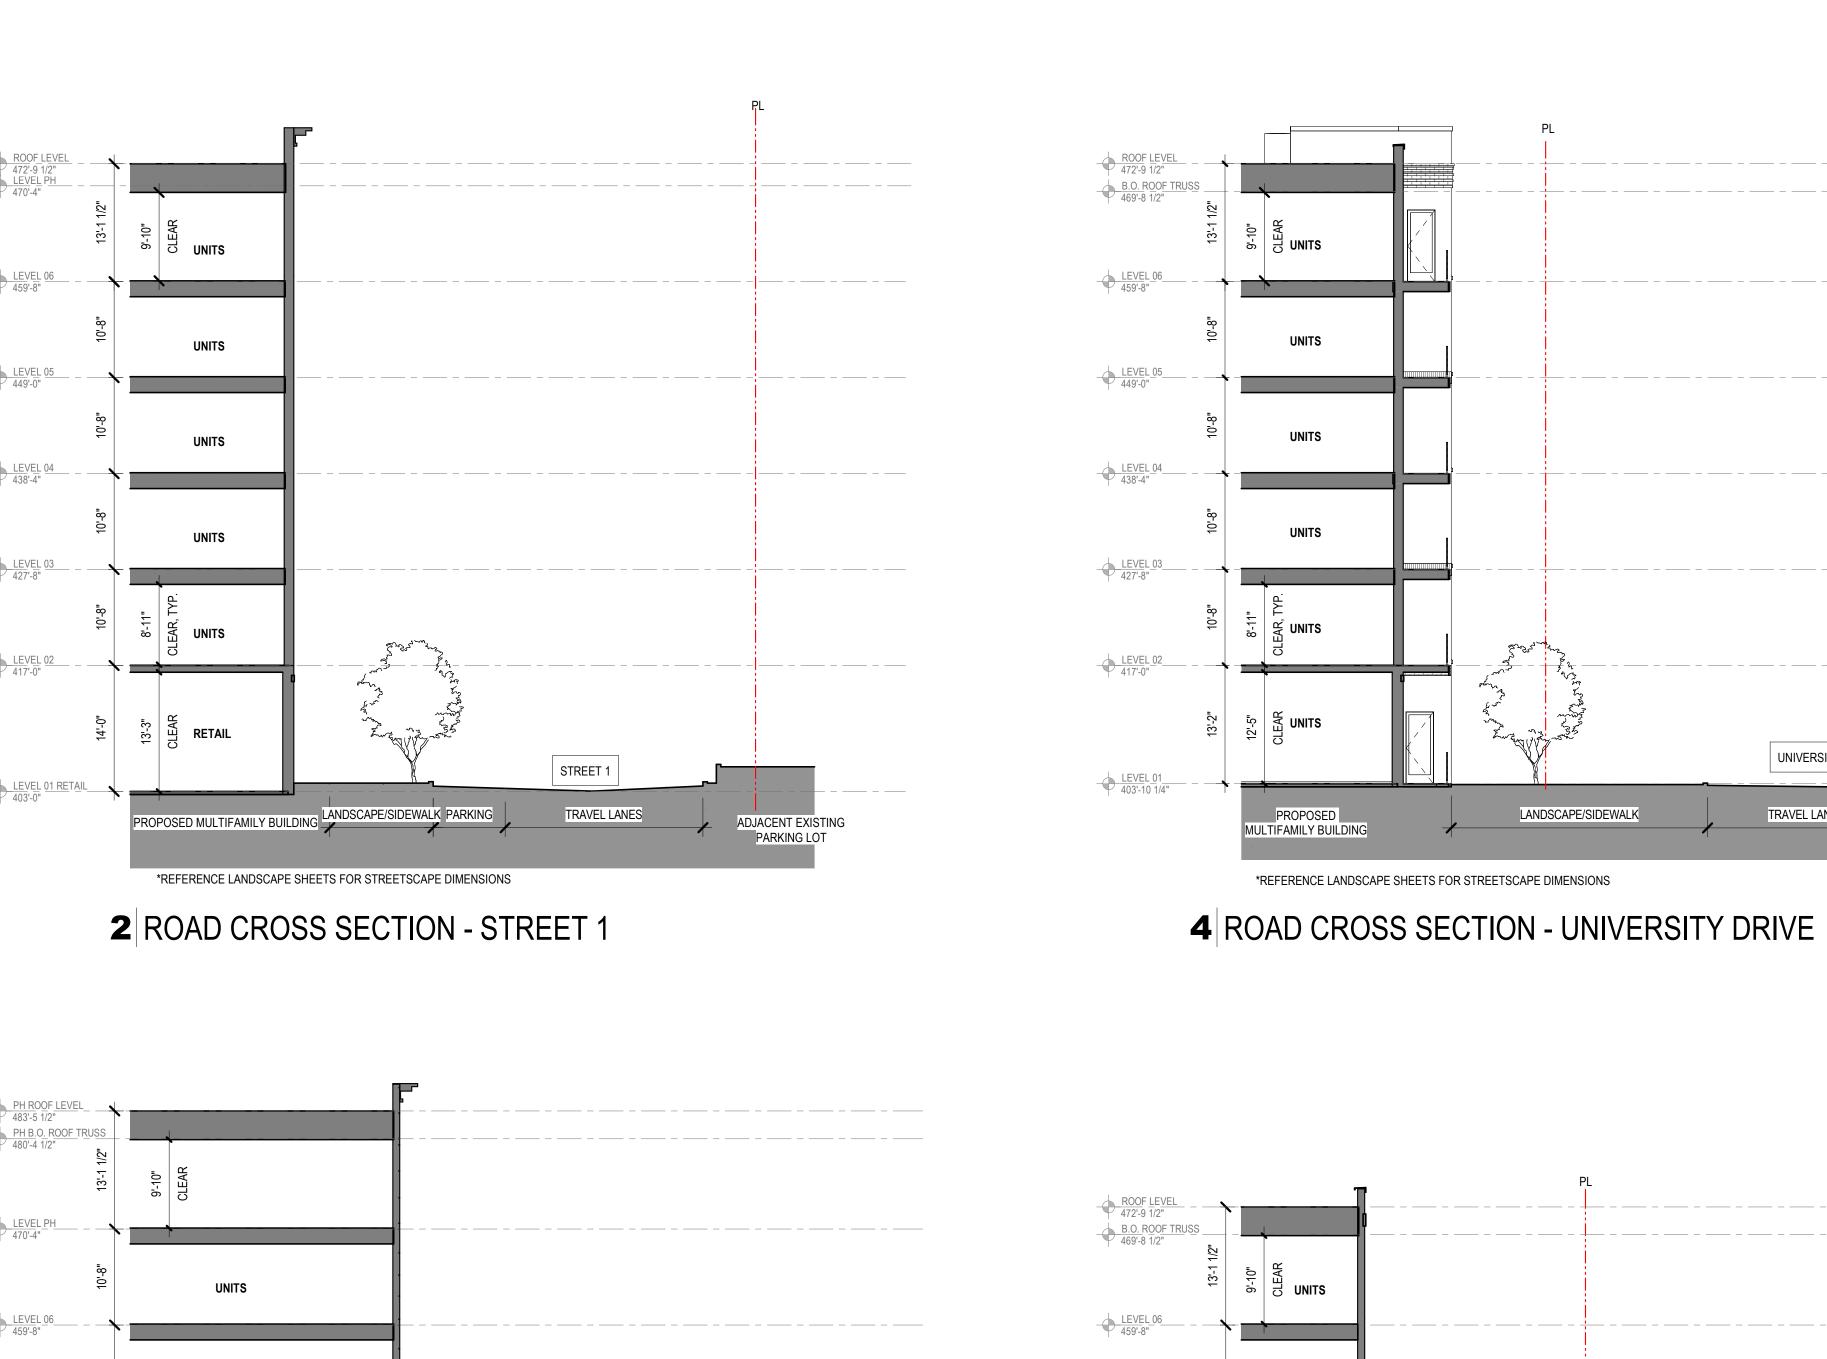

STREET 2

TRAVEL LANES

LANDSCAPE PARKING LOT

LANDSCAPE/ SIDEWALK PARKING

*REFERENCE LANDSCAPE SHEETS FOR STREETSCAPE DIMENSIONS


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UNIVERSITY DRIVE

TRAVEL LANES

CROSS SECTIONS


DRAWING NO. **A4**

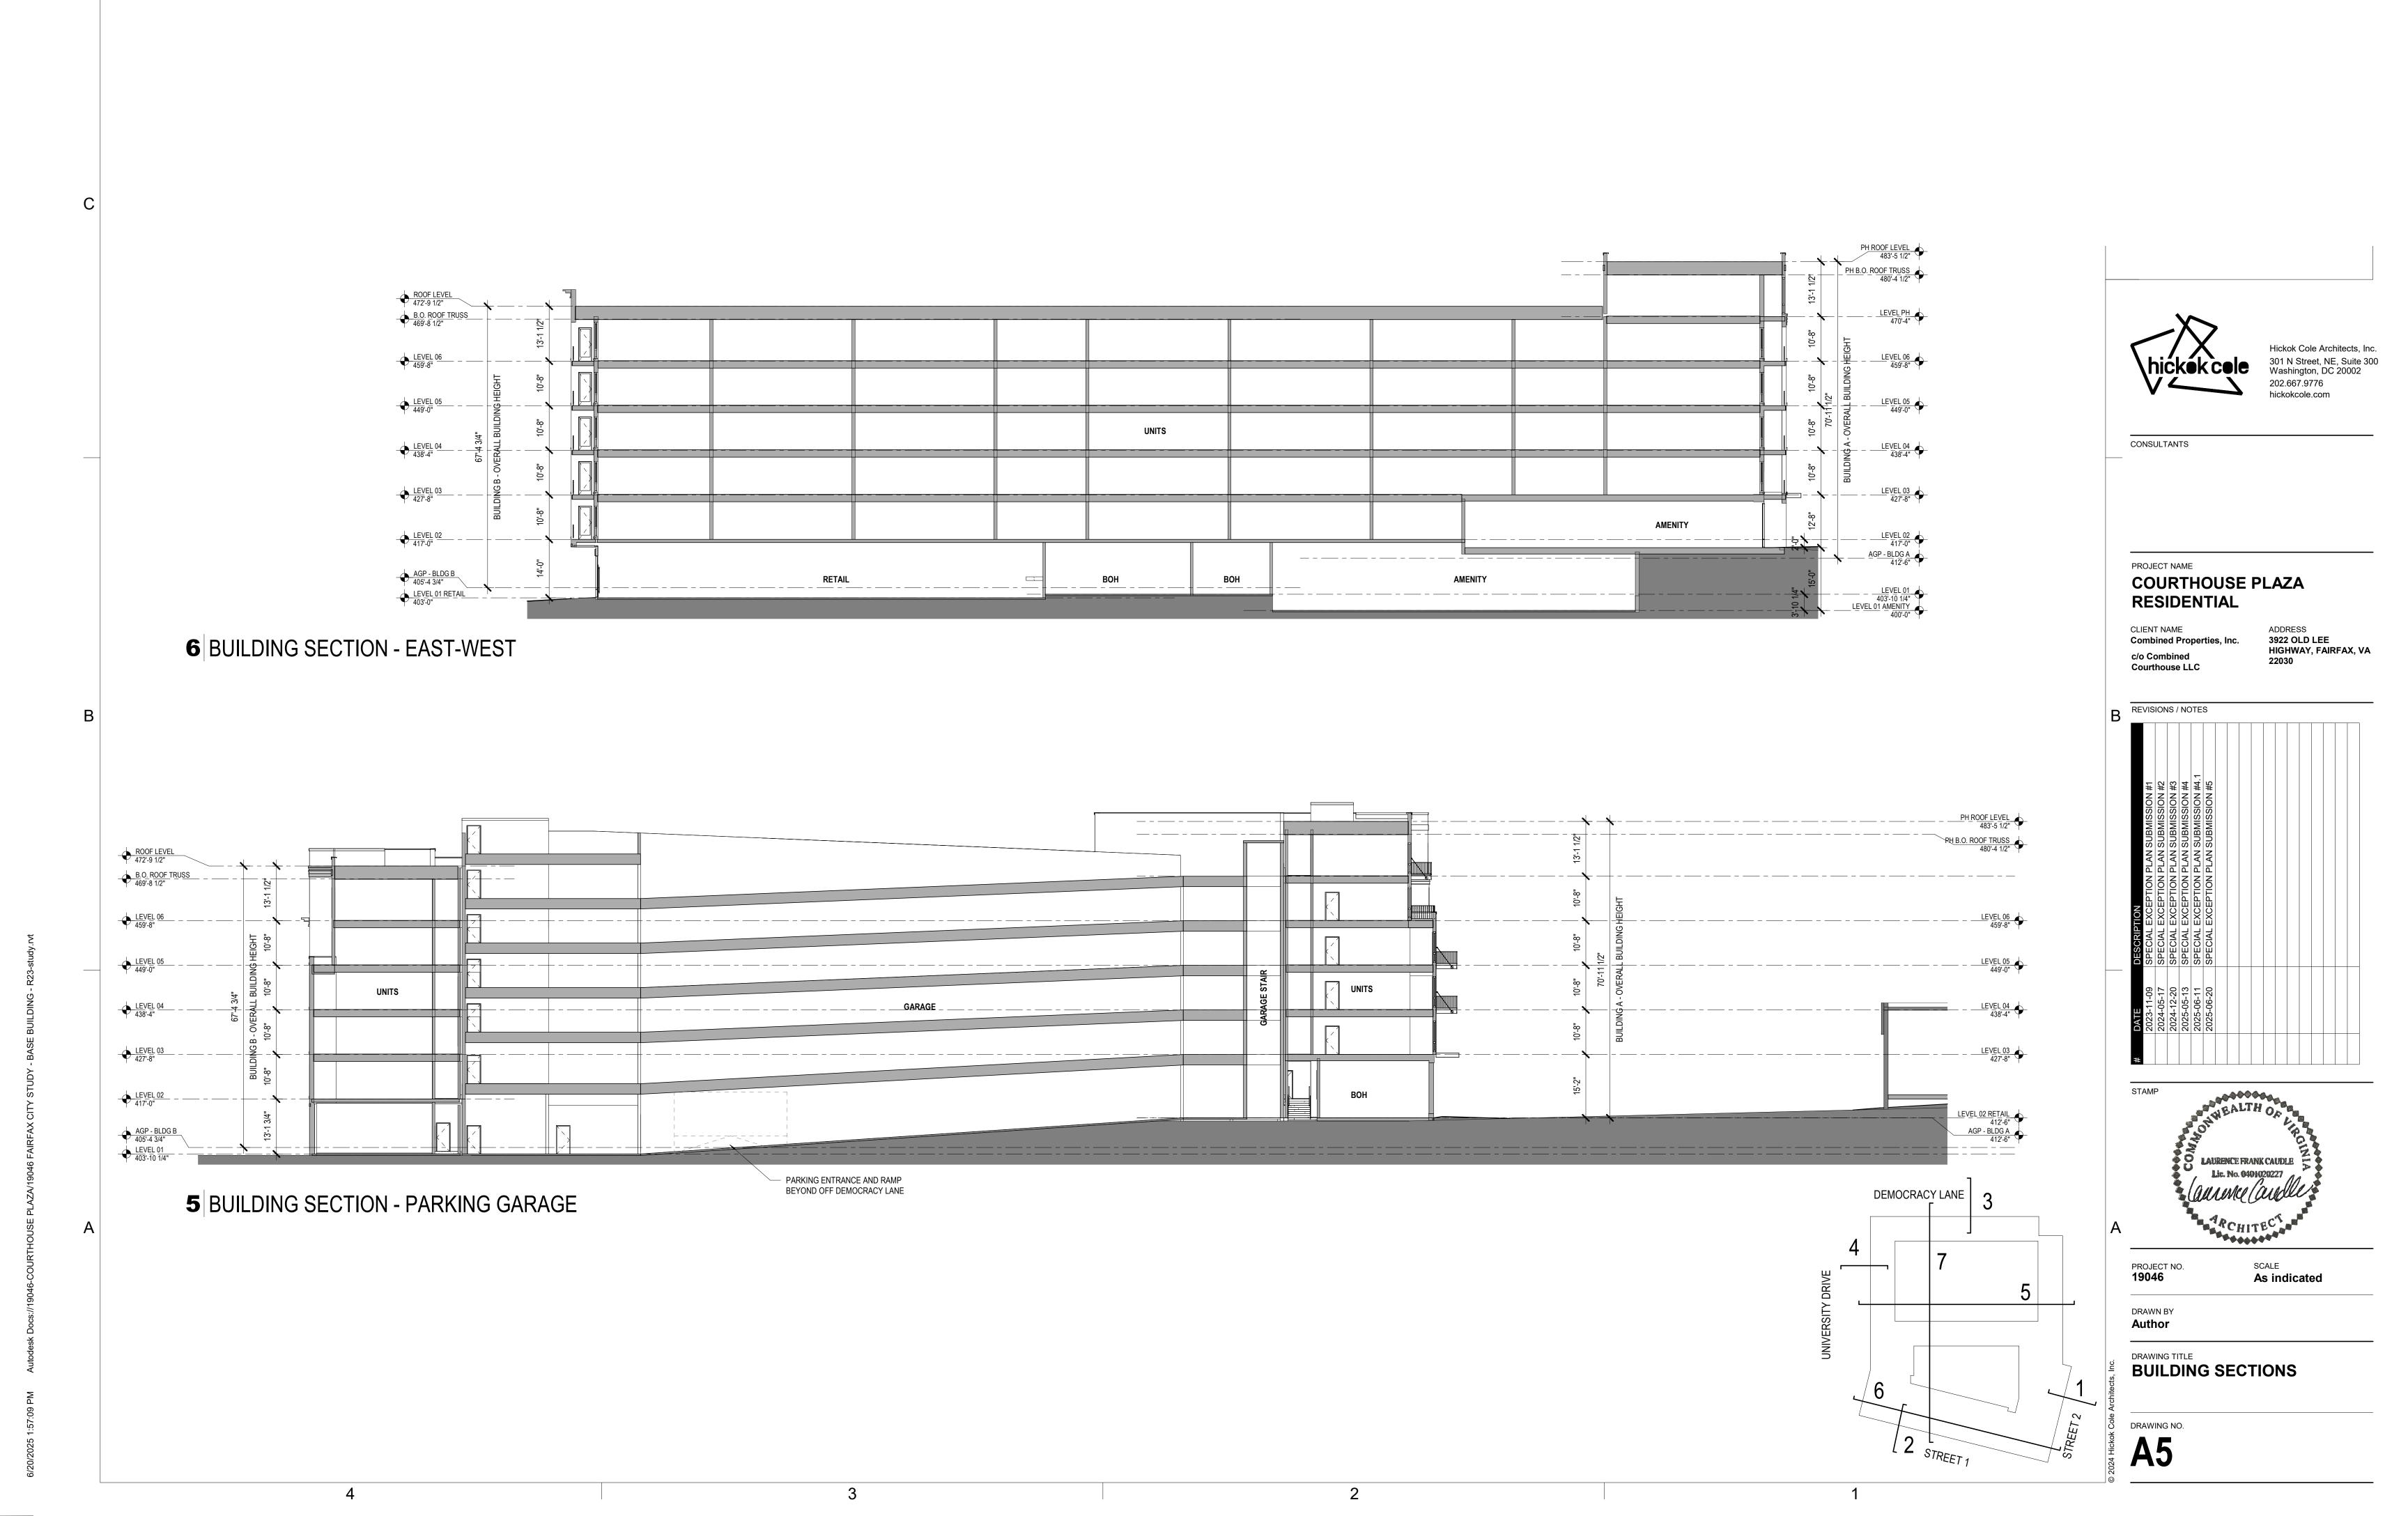

ROOF LEVEL 472'-9 1/2"

B.O. ROOF TRUSS
469'-8 1/2" UNITS COURTYARD UNITS

7 BUILDING SECTION - NORTH-SOUTH

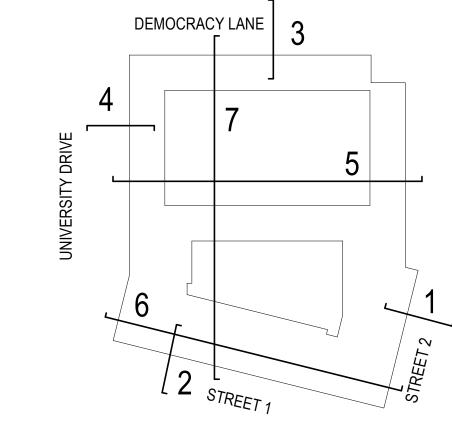




Hickok Cole Architects, Inc. 301 N Street, NE, Suite 300 Washington, DC 20002 202.667.9776 hickokcole.com

CONSULTANTS

PROJECT NAME **COURTHOUSE PLAZA** RESIDENTIAL

CLIENT NAME Combined Properties, Inc. c/o Combined Courthouse LLC

ADDRESS 3922 OLD LEE HIGHWAY, FAIRFAX, VA

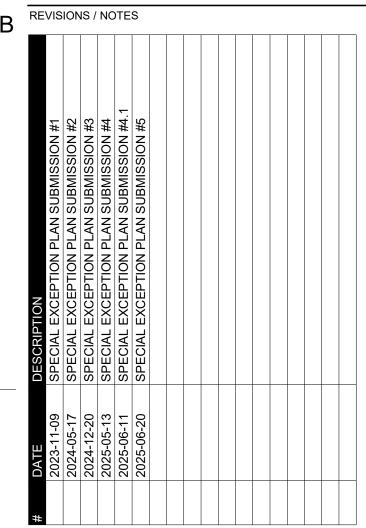




SCALE

As indicated PROJECT NO. **19046**


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DRAWING TITLE
BUILDING SECTIONS


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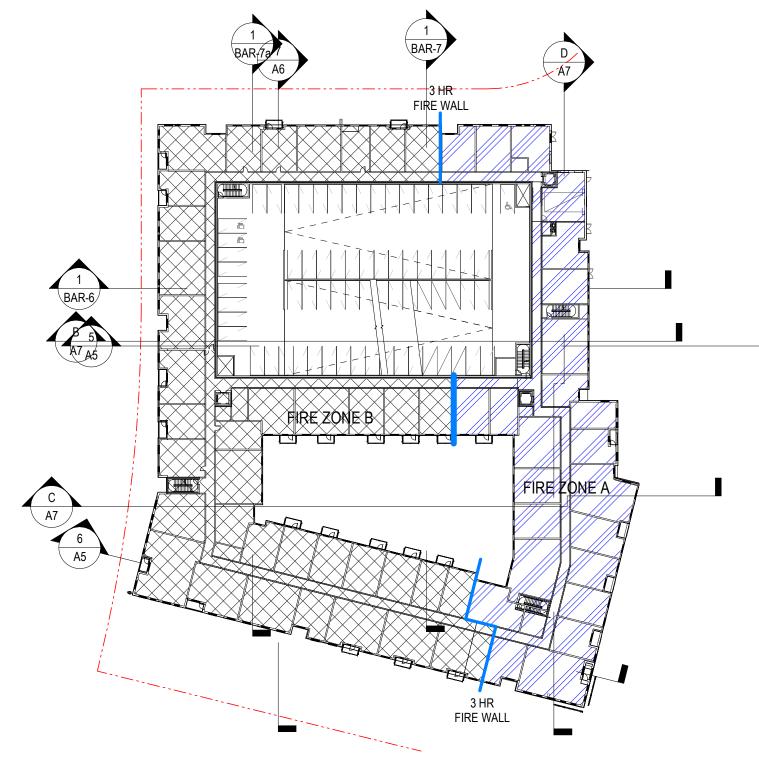
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C CONSTRUCTION TYPE - DIAGRAM E/W THROUGH COURTYARD

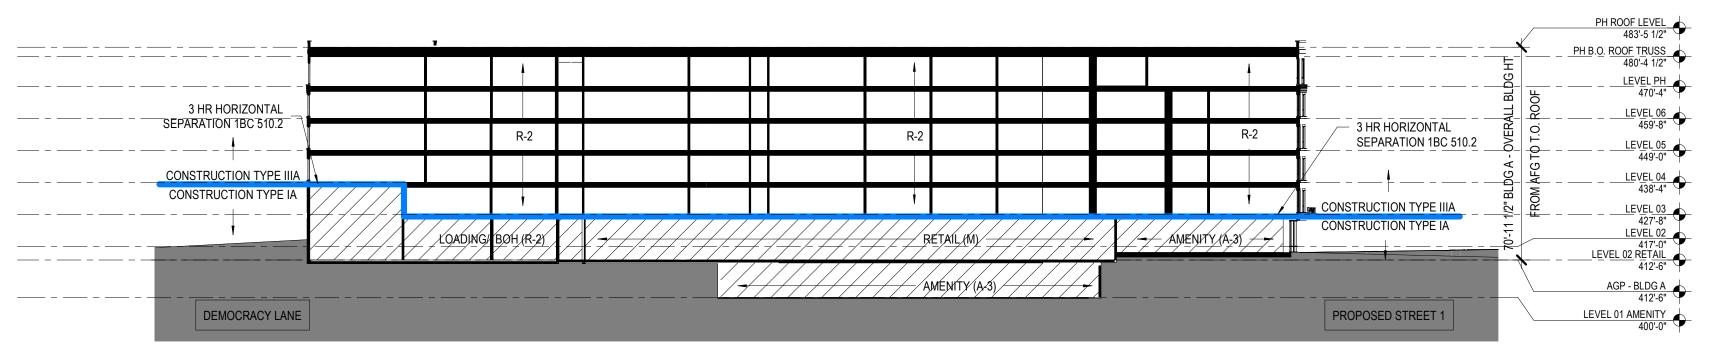

B CONSTRUCTION TYPE - DIAGRAM E/W THROUGH GARAGE



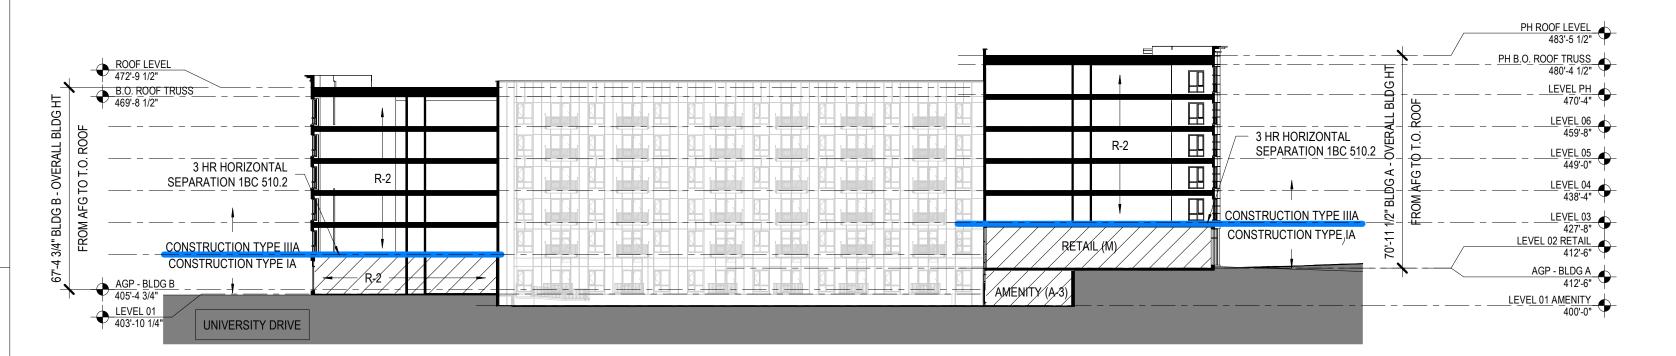

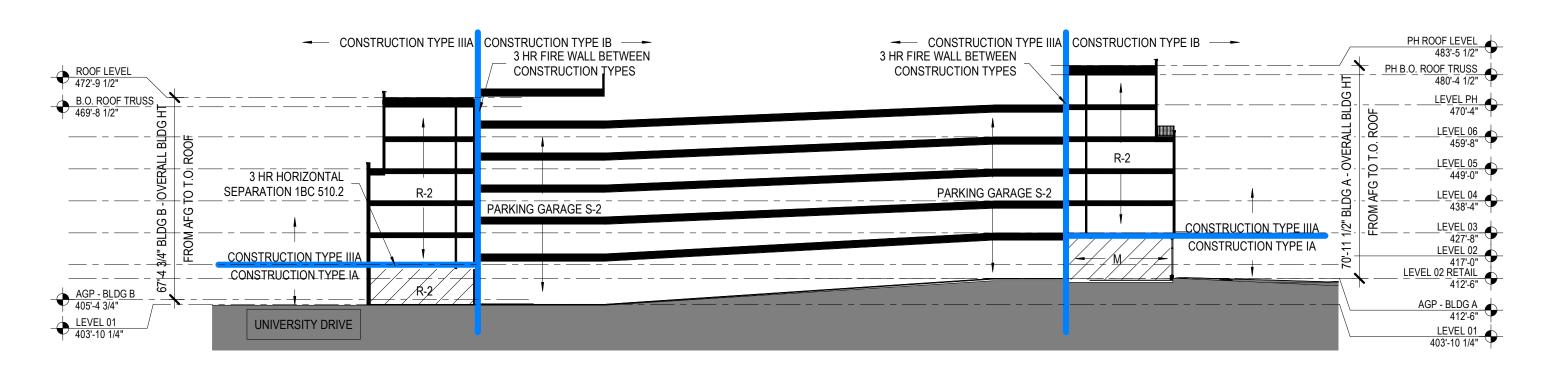


CONSULTANTS

PROJECT NAME **COURTHOUSE PLAZA** RESIDENTIAL

CLIENT NAME Combined Properties, Inc. c/o Combined Courthouse LLC

ADDRESS **3922 OLD LEE** HIGHWAY, FAIRFAX, VA

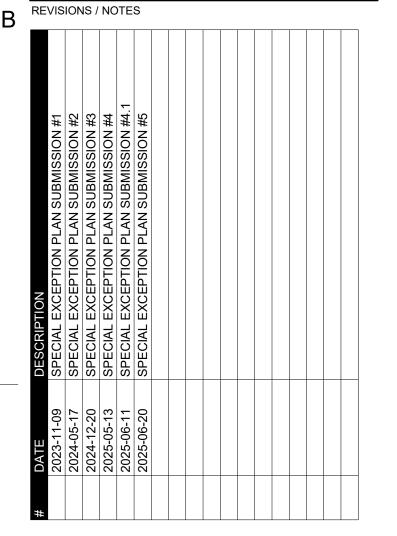



SCALE

As indicated PROJECT NO. **19046**

DRAWN BY

DRAWING TITLE **CONSTRUCTION TYPE DIAGRAM**

DRAWING NO. **A7**

— BROWN BRICK CORBELLING WHITE FIBER CEMENT — PH ROOF LEVEL 483'-5 1/2" WHITE FIBER CEMENT TAUPE METAL COPING, TYP. PH B.O. ROOF TRUSS 480'-4 1/2" WHITE FIBER CEMENT DARK BRONZE STANDING SEAM METAL BROWN METAL CORNICE ROOF LEVEL 472'-9 1/2" B.O. ROOF TRUSS 469'-8 1/2" LEVEL 02 RETAIL / 412'-6" BROWN BRICK ACCENT BLACK BRICK ----BROWN BRICK -AGP - BLDG B 405'-4 3/4" - BLACK BRICK ACCENT LEVEL 01 403'-10 1/4" GARAGE ENTRANCE METAL GARAGE DOOR BLACK BRICK

2 ELEVATION - NORTH
1/16" = 1'-0"



1 ELEVATION - SOUTH

1/16" = 1'-0"

NOTE: THESE ELEVATIONS ARE FOR ILLUSTRATIVE PURPOSES ONLY, FINAL LAYOUT AND SIGNAGE WILL BE DETERMINED BY FINAL ARCHITECTURE AND ENGINEERING AT THE TIME OF SITE PLAN.

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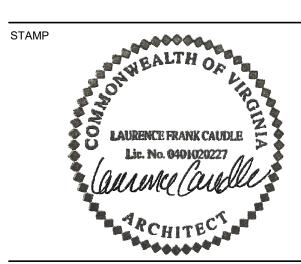
CONSULTANTS

PROJECT NAME **COURTHOUSE PLAZA** RESIDENTIAL

CLIENT NAME Combined Properties, Inc. c/o Combined Courthouse LLC

ADDRESS **3922 OLD LEE** HIGHWAY, FAIRFAX, VA

REVISIONS / NOTES AL EXCEPTION PLAN SUBMISSION #1
AL EXCEPTION PLAN SUBMISSION #2
AL EXCEPTION PLAN SUBMISSION #3
AL EXCEPTION PLAN SUBMISSION #4
AL EXCEPTION PLAN SUBMISSION #4.1
AL EXCEPTION PLAN SUBMISSION #5.1



SCALE 1/16" = 1'-0" PROJECT NO. **19046**

DRAWN BY **Author**

DRAWING TITLE
ELEVATIONS

DRAWING NO.



Hickok Cole Architects, Inc. 301 N Street, NE, Suite 300 Washington, DC 20002 202.667.9776 hickokcole.com

COURTHOUSE PLAZA

3922 OLD LEE HIGHWAY, FAIRFAX, VA

LAURENCE FRANK CAUDLE Lic. No. 0401020227

SCALE 1/16" = 1'-0"

ELEVATIONS