# VIEW ALONG MCLEAN AVENUE





RENDERING NOT TO SCALE

Paul VI Development | Fairfax, Virginia











# VIEW FROM KEITH AVENUE





RENDERING NOT TO SCALE

Paul VI Development | Fairfax, Virginia











# VIEW FROM CEDAR AVENUE & OAK STREET





RENDERING NOT TO SCALE













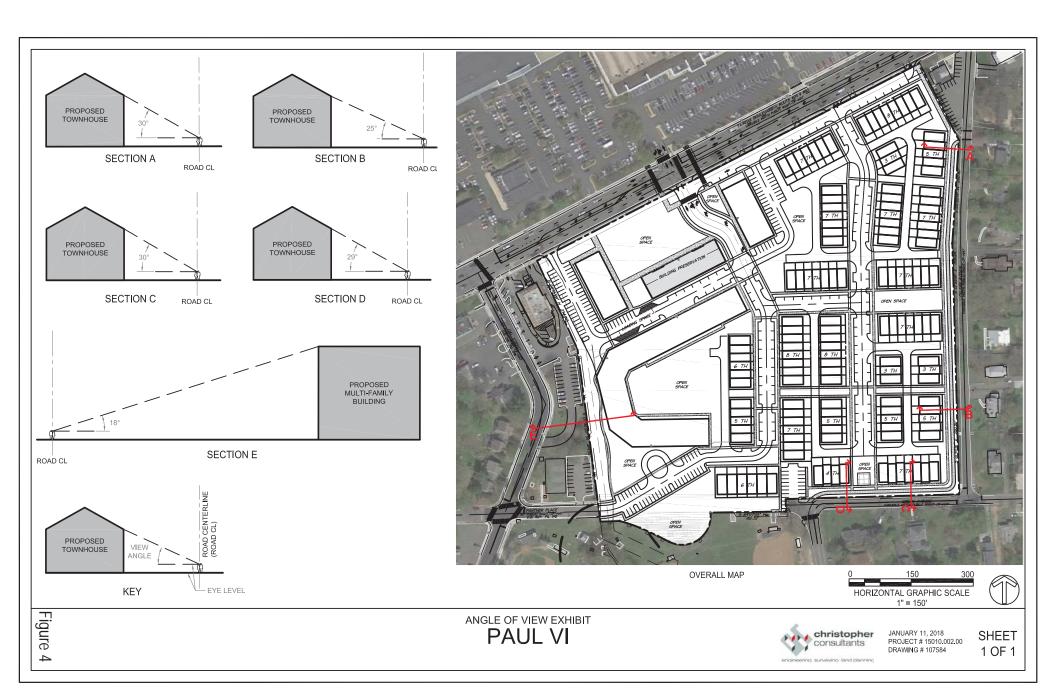

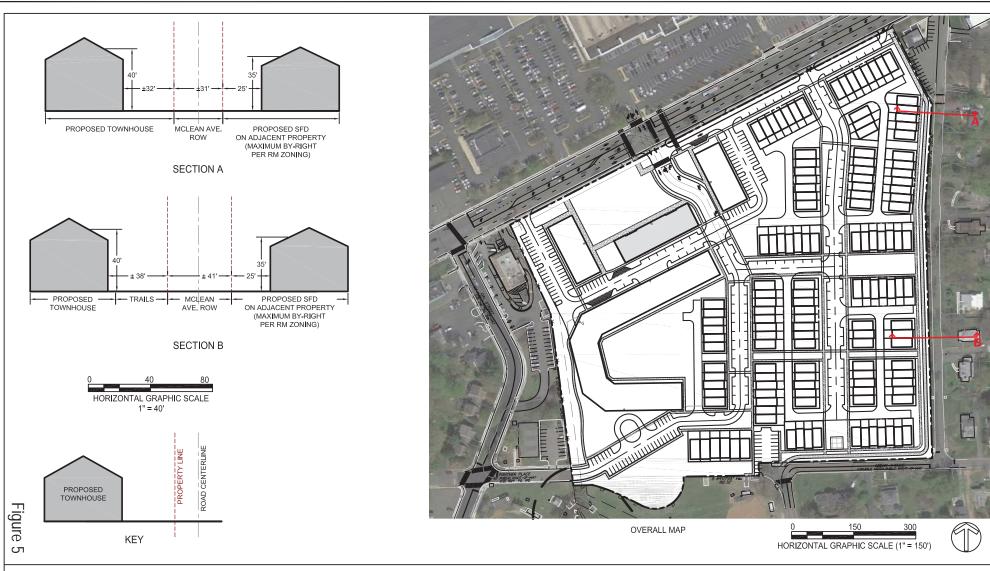

THIS EXHIBIT COMPARES THE DIMENSIONAL STANDARDS (BUILDING HEIGHT & SETBACK) FOR THE PROPOSED DEVELOPMENT WITH THE PROPERTIES ACROSS MCLEAN AVE. THE SECTIONS ABOVE SHOW THE PROPOSED TOWNHOUSE DEVELOPMENT FOR PAUL VI (ON THE LEFT) AS A 3-STORY TOWNHOUSE. THE BUILDINGS SHOWN ON THE RIGHT ARE THE PROPOSED SINGLE FAMILY DWELLING (SFD) DEVELOPMENT THAT COULD BE PERMITTED BY-RIGHT PER RM ZONING.


DIMENSIONAL STANDARDS COMPARISON EXHIBIT PROPOSED TOWNHOUSES VS. PROPOSED SFD (MAXIMUM BY-RIGHT PER RM ZONING)

PAUL VI



JANUARY 11, 2018 PROJECT # 15010.002.00 DRAWING # 107584


SHEET 1 OF 1

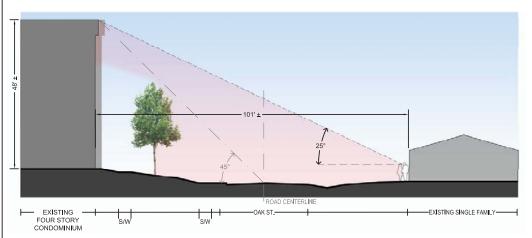

MOUNT VINEYARD - EXISTING VIEW FROM OAK STREET FACING SOUTH TOWARDS MAIN STREET



MOUNT VINEYARD - EXISTING VIEW FROM OAK STREET FACING SOUTH TOWARDS MAIN STREET

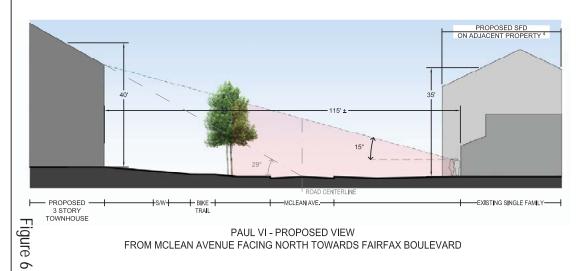



**DETAILED MAP VIEW** 

HORIZONTAL GRAPHIC SCALE (1" = 150')



THIS SHEET IS FOR ILLUSTRATIVE PURPOSES ONLY.

2. ALL MEASUREMENTS ARE APPROXIMATE.

3. THE FOLLOWING DENOTES VIEWSHED FROM PEDESTRIAN VANTAGE POINT:



PAUL VI & MOUNT VINEYARD



JANUARY 11, 2018 PROJECT # 15010.002.00 DRAWING # 107584

SHEET 1 OF 1

4. MAXIMUM BY-RIGHT PER RM ZONING: 35' BUILDING HEIGHT & 25' FRONT YARD BUILDING SETBACK

Table I
Shared Parking Analysis Summary
Paul VI - Commercial/Community Uses (1)

Land Use		Amount	<u>Units</u>	<u>Parking</u>	<u>Spaces</u>
Demand (No Shared Parking)					
Retail <sup>(1)</sup>		16,000	S.F.	8	0
Restaurant (Fine/Casual Dining)		4,000	S.F.	2	0
Community Space		24,000	S.F.	8	<u>0</u>
	Total	44,000	S.F.	18	0
Shared Parking Demand (Peak Month	n - Late Dec <u>)</u>			<u>Weekday</u>	Weekend
Retail				50	65
Restaurant (Fine/Casual Dining)				16	8
Community Space				64	55
Total S	Shared Spaces			130	128
Savings Due to Sharing				(50)	(52)
Percent Saved				-28%	-29%
F	Parking Supply			134	134
Extra Spaces (Su	•			4	6

### Notes:

<sup>(1)</sup> City of Fairfax Base Rates Used With 10% Transit Reduction and 10% Reduction for Internal Trips (to/from residential)

Table IA
Parking Required Without Sharing
Paul VI - Commercial/Community Uses

						Mode Ad	ljustment			Noncapt	ive Ratio	
			Den	nand	Wee	kday	Wee	kend	Wee	kday	Weekend	
Land Use	Qua	entity	Weekday	Weekend	Daytime	Evening	Daytime	Evening	Daytime	Evening	Daytime	Evening
Retail	16,000	sf GLA	69	67	90%	90%	90%	90%	90%	90%	90%	90%
Employee			11	13	90%	90%	90%	90%	90%	90%	90%	90%
Fine/Casual Dining Restaurant	4,000	sf GLA	17	17	90%	90%	90%	90%	90%	90%	90%	90%
Employee			3	3	90%	90%	90%	90%	90%	90%	90%	90%
Community Use	24,000	sf GLA	72	72	90%	90%	90%	90%	90%	90%	90%	90%
Employee			8	8	90%	90%	90%	90%	90%	90%	90%	90%
Subtotal Customer/Guest Spaces			158	156		•						
Subtotal Employee/Resident Spaces			<u>22</u>	<u>24</u>								
Total Parking Spaces			180	180								

Table IB


Parking Required With Sharing

Paul VI - Commercial/Community Uses

	Weekday			Weekend			Weekday			Weekend							
	Project				Non-					Non-		Peak Hr	Peak Mo	Estimated	Peak Hr	Peak Mo	Estimated
	Data		Base	Mode	Captive	Project		Base	Mode	Captive	Project	Adj	Adj	Parking	Adj	Adj	Parking
Land Use	Quantity	Unit	Rate	Adj	Ratio	Rate	Unit	Rate	Adj	Ratio	Rate	7 PM	December	Demand	3 PM	December	Demand
Retail	16,000	sf GLA	4.30	0.90	0.90	3.48	/ksf GLA	4.20	0.90	0.90	3.40	0.75	1.00	42	1.00	1.00	54
Employee			0.70	0.90	0.90	0.57	/ksf GLA	0.80	0.90	0.90	0.65	0.95	1.00	8	1.00	1.00	11
Fine/Casual Dining Restaurant	4,000	sf GLA	4.30	0.90	0.90	3.48	/ksf GLA	4.20	0.90	0.90	3.40	1.00	1.00	14	0.45	1.00	6
Employee			0.70	0.90	0.90	0.57	/ksf GLA	0.80	0.90	0.90	0.65	1.00	1.00	2	0.75	1.00	2
Community Use	24,000	sf GLA	3.00	0.90	0.90	2.43	/ksf GLA	3.00	0.90	0.90	2.43	1.00	1.00	58	0.84	1.00	49
Employee			0.33	0.90	0.90	0.27	/ksf GLA	0.33	0.90	0.90	0.27	1.00	1.00	6	1.00	1.00	6
												Cust	omer	114	Cust	tomer	109
												Emp	loyee	<u>16</u>	Emp	loyee	<u>19</u>
												To	otal	130	T	otal	128

Table 2
Shared Parking Demand By Month
Paul VI - Commercial/Community Uses

<u>Month</u>	<u>Weekday</u>	Weekend
January	109	101
February	109	101
March	114	105
April	113	105
May	115	107
June	116	106
July	114	106
August	118	108
September	114	105
October	115	107
November	119	109
December	130	128

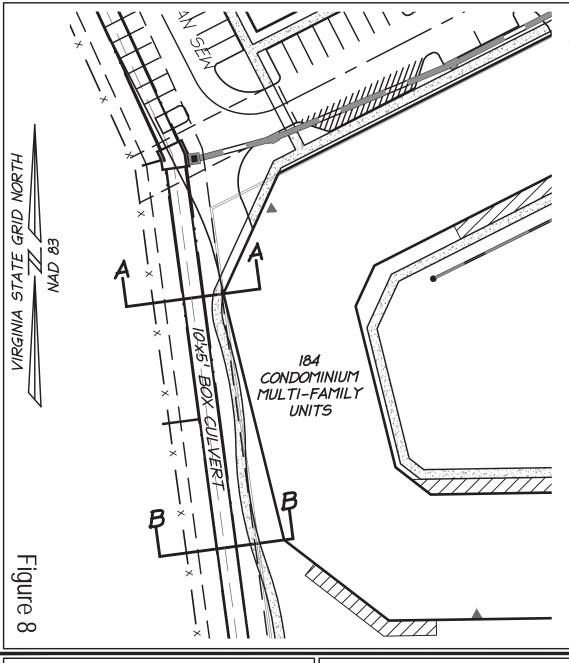

### 10'X5' BOX CULVERT NOTES:

I. ADDITIONAL REINFORCING WITHIN THE CULVERT MAY BE REQUIRED AT THE TIME OF SITE PLAN REVIEW TO PROTECT FROM LATERAL PRESSURE.

2. ADDITIONAL ACCESS POINTS MAY BE REQUIRED AT SPECIFIC LOCATIONS AS REQUESTED AT TIME OF FINAL SITE PLAN.

50 25 0 50 100 GRAPHIC SCALE 1" = 50'



IO'X5' BOX CULVERT & BUILDING FOOTER EXHIBIT CROSS SECTION PLAN VIEW


PAUL VI


CONCEPT PLAN

CITY OF FAIRFAX, VA

DESIGN: TET	SCALE: I" = 50'
DRAWN: MFC	30
CHECKED: TET	SHEET:
DATE:	1 2
01/31/2018	1 OF )



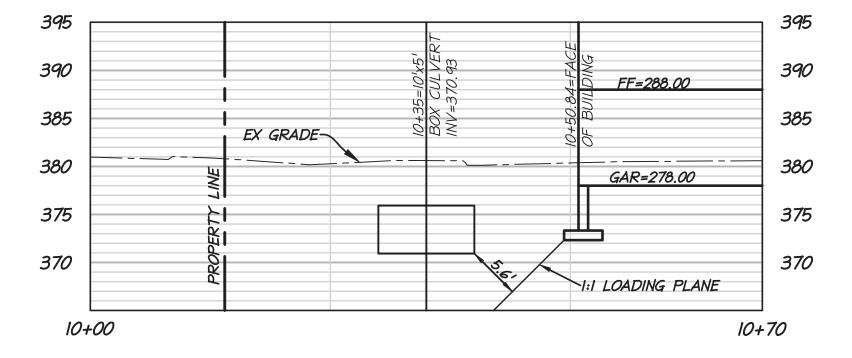


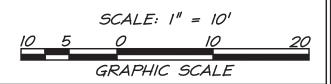





10'X5' BOX CULVERT & LOADING PLAN EXHIBIT
CROSS SECTION "A"
PAUL VI
CONCEPT PLAN
CITY OF FAIRFAX, VA

DESIGN: TET	SCALE: I" = 10'
DRAWN: MFC	
CHECKED: TET	SHEET:
DATE: 01/31/2018	2 <sub>0</sub> 3
017 317 2010	

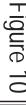

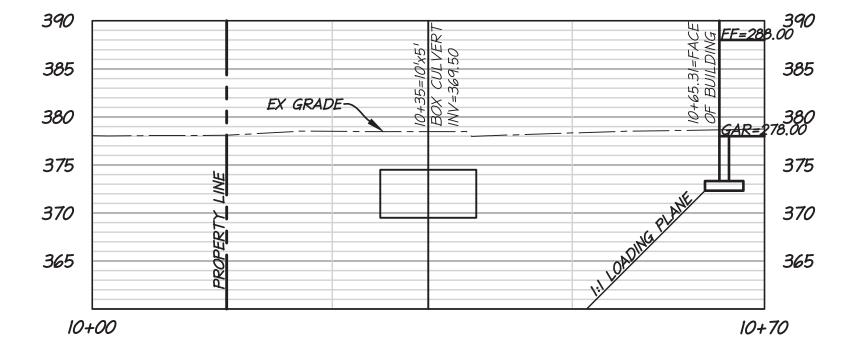

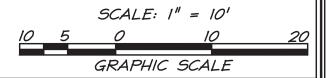




10'X5' BOX CULVERT & LOADING PLAN EXHIBIT
CROSS SECTION "B"
PAUL VI
CONCEPT PLAN
CITY OF FAIRFAX, VA

DATE: 01/31/2018	3 of 3
CHECKED: TET	SHEET:
DRAWN: MFC	7,0
DESIGN: TET	SCALE: I" = 10'

### **TABULATIONS** TOTAL Linear feet along private streets: 3,135 Total number of trees required (1 tree for 40 feet): 79 Total number of trees provided: 108 **PRIVATE STREET** Linear feet along private street: 572 Total number of trees required (1 tree for 40 feet): 15 Total number of trees provided: 21 PRIVATE STREET Linear feet along private street: 375 Total number of trees required (1 tree for 40 feet): 10 Total number of trees provided: 15 PRIVATE STREET Linear feet along private street: 214 Total number of trees required (1 tree for 40 feet): 6 Total number of trees provided: 7 **PRIVATE STREET** 463 Linear feet along private street: Total number of trees required (1 tree for 40 feet): 12 Total number of trees provided: 19 **PRIVATE STREET** Linear feet along private street: 694 Total number of trees required (1 tree for 40 feet): 18 Total number of trees provided: 25 PRIVATE STREET Linear feet along private street: 817 Total number of trees required (1 tree for 40 feet): 21 Total number of trees provided: 21

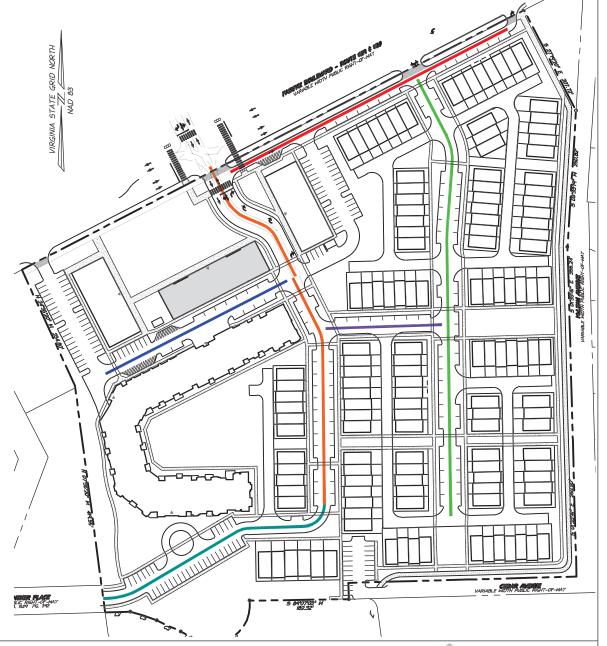

NOT TO SCALE

PRIVATE STREET TREE EXHIBIT

PAUL VI



engineering surveying land planning